



# STRAWBERRY HILL CENTER BUFFER REPLANTING

## CONDITIONAL NOTES:

- A. Existing trees include large white oak.
- B. A clearing program was initiated Monday, July 1, 1990, as described in the memo from the tree ordinance dept. dated June 28, 1990. The clearing program will be conducted in accordance with the proposed layout plan. The undisturbed area for the existing trees will be maintained and no further disturbance will be made as indicated on proposed layout plan.
- C. Tree protection will be provided around each tree, a tree barrier equal to the drip line plus 10' will be constructed around each tree. The barrier will be continuous with other than that needed to walls shown on the proposed layout plan and attached to them. Shaded areas within this area will be protected surrounding these trees and not be cleared. Within the surrounding structural part of the property, the tree protection will be continuous. Tree protection/rotating wall will be field located and confirmed by the planning commission staff before construction of the walls. PVC sleeves will be installed around the base of each tree to prevent future damage or future disturbance of the undisturbed area.
- D. All earthmoving equipment will be constructed within the undisturbed area defined by tree protection/rotating wall.
- E. Private arborist services will be obtained from an approved vendor. The arborist services shall submit a maintenance program. The arborist service shall submit the tree protection/rotating program by July 25th for review and approval by the planning commission staff. The program is to continue at a minimum of 12 months. The arborist services shall be responsible for protection/rotating plan.
- F. Maintenance and fertilization program will be initiated by the developer in accordance with the buffer replanting plan.

## GRADED/CLERED AREA OF SARDIS ROAD

- A. All large stumps preventing the spreading of top soil will be removed. The cleared area will be graded to a slope of 1% and 3' of top soil will be evenly spread over the cleared area by a ranked front tractor and box blade. Only native topsoil will be used. The topsoil will be compacted to minimize compaction.
- B. Once the topsoil has been replaced, the cleared area will be remedied with a berms mix for stabilization. Construction of the berms will begin as soon as the road will begin at the earliest possible date after the completion of the clearing.
- C. The approved buffer replanting plan will be planted this fall (1990) during the acceptable planting season.
- D. The buffer areas will be mulched with 3" of pine needle mulch.
- E. Planting contractor shall meet with the Charlotte Tree Foundation to discuss the details of the buffer replanting species, locations and methods before installation.

## PROPOSED PLANT SCHEDULE

SPRING QTR.	SUMMER QTR.	FALL QTR.	WINTER QTR.
1. 1. Quercus coccinea	3 1/2"-4"		
1a. 2. Betula populifolia	4 1/2"-5"		
2. 1. Garrya spp.	3 1/2"-4"		
2a. 2. Betula spp.	4 1/2"-5"		
3. 2. Quercus rubra	3 1/2"-4"		
3a. 2. Betula spp.	4 1/2"-5"		
4. 1. Quercus rubra	3 1/2"-4"		
4a. 1. Quercus rubra	4 1/2"-5"		
5. 2. Myrsinaceae		6"-7"	
5a. 2. Kalmia latifolia			
6. 1. Coptisaceae			6"-7"
6a. 1. Eastern Redbud			6"-7"
7. 6. Pinus virginiana			6"-7"

General Notes:  
1. Buffer areas to be mulched with 3" of pine needle mulch.

## CONSTRUCTION SEQUENCE CONTACT SCHEDULE

- The planning commission staff, the Charlotte-Mecklenburg foresty staff, the Sardis Road property owner and the developer will be contacted before any work is completed.
- Before trenching begins at least 10 days notice will be given to the foresty and property owner.
- Areas beyond trench to property line will be clearly marked and tree protection devices installed.
- Before and during trenching construction.
- Before arborist begins work and new work is completed, the developer will be given 10 days notice to review for either cost, loss of trees or aesthetic reasons. Only structural problems should occur.
- After topsoil is redistributed.
- Before, during, and after new trees are planted.
- Please contact Keith MacLean, zoning 10-220; Joe Schubert, Urban Forestry 10-220; and Sherry Williamson, zoning 10-220.

ATTACHED TO MEMO DATED  
9/10/90 BY MARTIN R. CRATON, JR.  
9/10/90

SEE ADMINISTRATIVE APPROVAL  
DATE 9/10/90 FOR FURTHER  
INFORMATION

DATE JUL 10, 1990  
PROJECT NO. 0551-2

REVISIONS

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O ATTACHED to memo Dated  
7/10/10 by [REDACTED]

UNDISTURBED TREE SAVE AREA.

OUTSIDE WALL TO BE LOCATED  
IN FIELD WITH COORDINATION  
OF LANDSCAPE ARCHITECT.

4" PINE NEEDLE MULCH

UNDISTURBED GRADE LEVEL


UNDISTURBED SOIL

SANDY LOAM TOP SOIL  
BACK FILL

#### CONSTRUCTION NOTES:

1. INSIDE WALL EDGE TO BE FIELD LOCATED.
2. TRENCH INSIDE EDGE LINE TO TOP OF FOOTING ELV. WITH DITCH DITCH
3. PULL EXCESS DIRT PERPENDICULARLY AWAY FROM FACE OF WALL W/ BACK HOE.
4. HAND DIG FOOTING BED.
5. BUILD FOOTING W/ CMU
6. COMPLETE FINISH DETAILS AFTER FINISH GRADING.

SEE GRADING PLAN FOR WALL ELEVATIONS.

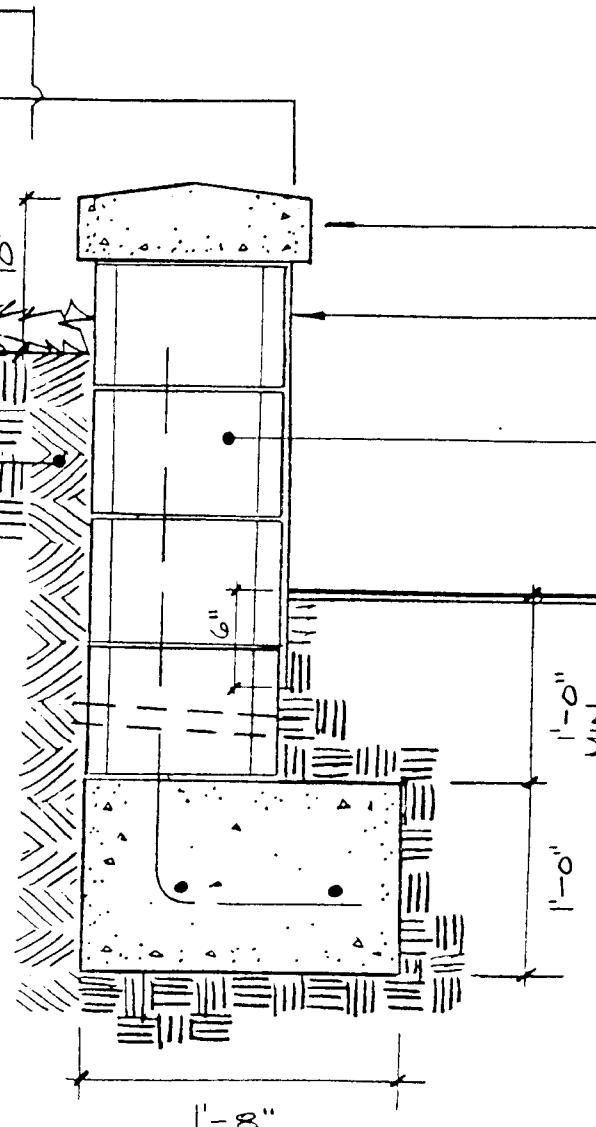

PRE CAST CONC. CAP SEE  
ARCHITECTURALS.

DRYVIT FINISH COAT. EXTEND  
6" BELOW FINISH GRADE, SEE  
ARCHS. FOR FINISH SPEC.

12" C.M.U.

FINISH GRADE.

4" PVC SLEEVE 2 PER  
TREE SAVE AREA.

CONC. FOOTING SEE  
STRUCTURALS.

COMPACTED SUBGRADE.

3

11

## TREE PROTECTION / RETAINING WALL

SCALE: 1" = 1' - 0"

# STRAWBERRY HILL CENTER

MARSH REALTY COMPANY  
P.O. BOX 35329 CHARLOTTE, N.C. 28217

REZONED AS THE VILLAGE AT STRAWBERRY HILL  
ZONING PETITION # 88-34

## SITE TABULATIONS

TOTAL SITE AREA: 6.2 ACRES

CURRENT ZONING: B1-CD

BUILDING SQ. FT.: 38,800

## PARKING TABULATION

Occupancy	Grocery, Drug Store, Shops	Mercantile 23,447SF/200 = 117
Restaurant	Assembly 150 Persons/3 = 50	
Bank	Business 2481SF/100 = 25	

Employees	
Grocery	15
Restaurant	10
Shop	20
Total	45/2

Park & Ride	= 23
Total Parking Required	= 62
Total parking Provided (6 Handicap Spaces)	= 277

LANDSCAPE AREA ACREAGE: 18,900 S.F.  
(PER TREE ORDINANCE REQUIREMENTS)

## STORM DRAINAGE DESIGN DATA

PROJECT	Strawberry Hill Center	COMPUTED BY	VSA	DATE	4/3	1990						
LOCATION	Charlotte	CHECKED BY	JWG	SHEET	1	OF 1						
STORM FREQUENCY 10 YEAR												
LOCATION	AREA	C	INTENSITY	Q = CIA	PIPE	REMARKS						
TO	SUB TOTAL	C	H	L	I	CFS	N	SLOPE	LGTH	SIZE	VEL	
TU 1	DI 2		0.13	.81		6.8	.72	.01	.008	106'	8"	- 8" Schedule 40 PVC
LI 2	CB 5	.05	0.18	.95		6.8	1.04	.012	.008	48'	15"	3.2
DI 3	DI 4		0.02	.95		6.8	0.13	.012	.008	42'	15"	3.0
DI 4	CB 5	.62	0.64	.95		6.8	4.13	.012	.026	36'	15"	5.6
CB 5	CB 6	.29	1.11	.77		6.8	6.08	.012	.021	204'	15"	5.4
CB 6	CB 7	.58	1.69	.86		6.8	10.07	.012	.028	114'	15"	8.2
CB 7	CB 8	.52	2.21	.88		6.8	13.18	.012	.018	36'	18"	7.7
CB 8	CB 9	.79	3.0	.52		6.8	15.97	.012	.024	20'	18"	9.2
CB 9	FES 10	.29	3.29	.95		6.8	17.84	.012	.021	20'	24"	7.0
Det. Outlet						5.44	.021	.004	.004	50'	12"	7.0
DI 11	CB 13		0.44	.95		6.8	2.84	.012	.059	220'	8"	- 8" Schedule 40 PVC
CB 12	CB 13		.91	.88		6.8	5.45	.012	.009	70'	15"	4.8
CB 13	FES 14	.22	1.57	.90		6.8	9.64	.012	.024	12'	15"	8.2
DET. OUTLET	CB 15					2.14	.021	.005	.005	180'	10"	3.6 - DETENTION OUTLET
CB 15	MH 16					6.8	4.89	.012	.010	120'	15"	6.5
MH 16	Exist 17					4.85	.012	.010	.010	120'	15"	6.5
Exist 17												


## SCHEDULE OF DRAWINGS

- L 1. TITLE SHEET
- L 2. EXISTING CONDITIONS
- L 3. SITE PLAN
- L 12 PLANTING PLAN
- L 13 PLANTING PLAN
- L 14 PLANTING SCHEDULE & DETAILS
- L 3A. DRAINAGE AREA MAP
- L 4. CLEARING & TREE PROTECTION PLAN
- L 5. STAKING PLAN
- L 6. SEDIMENTATION & EROSION CONTROL PLAN
- L 7. PROVIDENCE ROAD IMPROVEMENTS
- L 8. SITE DETAILS
- L 9. SITE DETAILS
- L 10. SITE DETAILS
- L 11. SITE DETAILS

ATTACHED to Administrative  
APPROVAL DATE 11/13/90 by  
MARTIN R. CRANSTON, Jr., P.E.

\*Also see administrative  
Approval DATE 9/10/90  
For further information


CHARLOTTE TREE ORDINANCE  
SITE/LANDSCAPE PLAN APPROVED  
REVIEWER: Joe Cochran  
DATE: 9/10/90

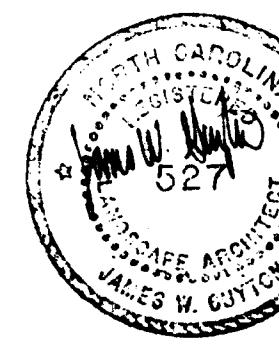

## STORM DRAINAGE SCHEDULE

STRUCTURE	RIM	INV. IN	INV. OUT	LENGTH	SIZE	SLOPE
TD 1	708.51	-----	706.71	106'	8"	PVC
DI 2	711.80	706.18	705.98	48'	15"	RCP
LI 3	711.90	708.65	708.65	41'	15"	RCP
DI 4	711.90	708.31	708.11	36'	15"	RCP
CB 5	710.45	(DI 2) 205.60	-----	-----	2.6%	
(DI 4)	707.17	705.40	204'	-----	1.0%	
CB 6	709.90	703.36	703.16	114'	15"	RCP
CB 7	707.24	700.92	700.92	40'	15"	RCP
CB 8	706.27	699.40	699.40	24'	18"	RCP
CB 9	706.27	698.82	698.82	24'	24"	RCP
FES 10	-----	698.38	-----	-----	1.0%	
Detention	-----	694.00	691.00	50'	12"	CMP
Outlet	-----	-----	-----	4"	-----	4.0% HGL
DI 11	712.18	-----	709.51	220'	8"	PVC
CB 12	699.80	696.51	696.51	70'	15"	RCP
CB 13	699.20	(DI 11) 696.55	695.95	12'	15"	RCP
FES 14	-----	695.66	695.66	-----	2.4%	
Detention NEW	-----	693.00	693.00	152'	15"	CMP
CB 15	693.42	690.67	690.67	120'	15"	RCP
MH 16	692.20	689.15	688.75	18'	15"	RCP
EX CB	691.70	688.75	688.75	-----	1.2%	

ALL STORM DRAINAGE PIPE TO BE CLASS III RCP EXCEPT AS NOTED  
ALL CMP TO BE FULLY ASPHALT COATED WITH PAVED INVERT

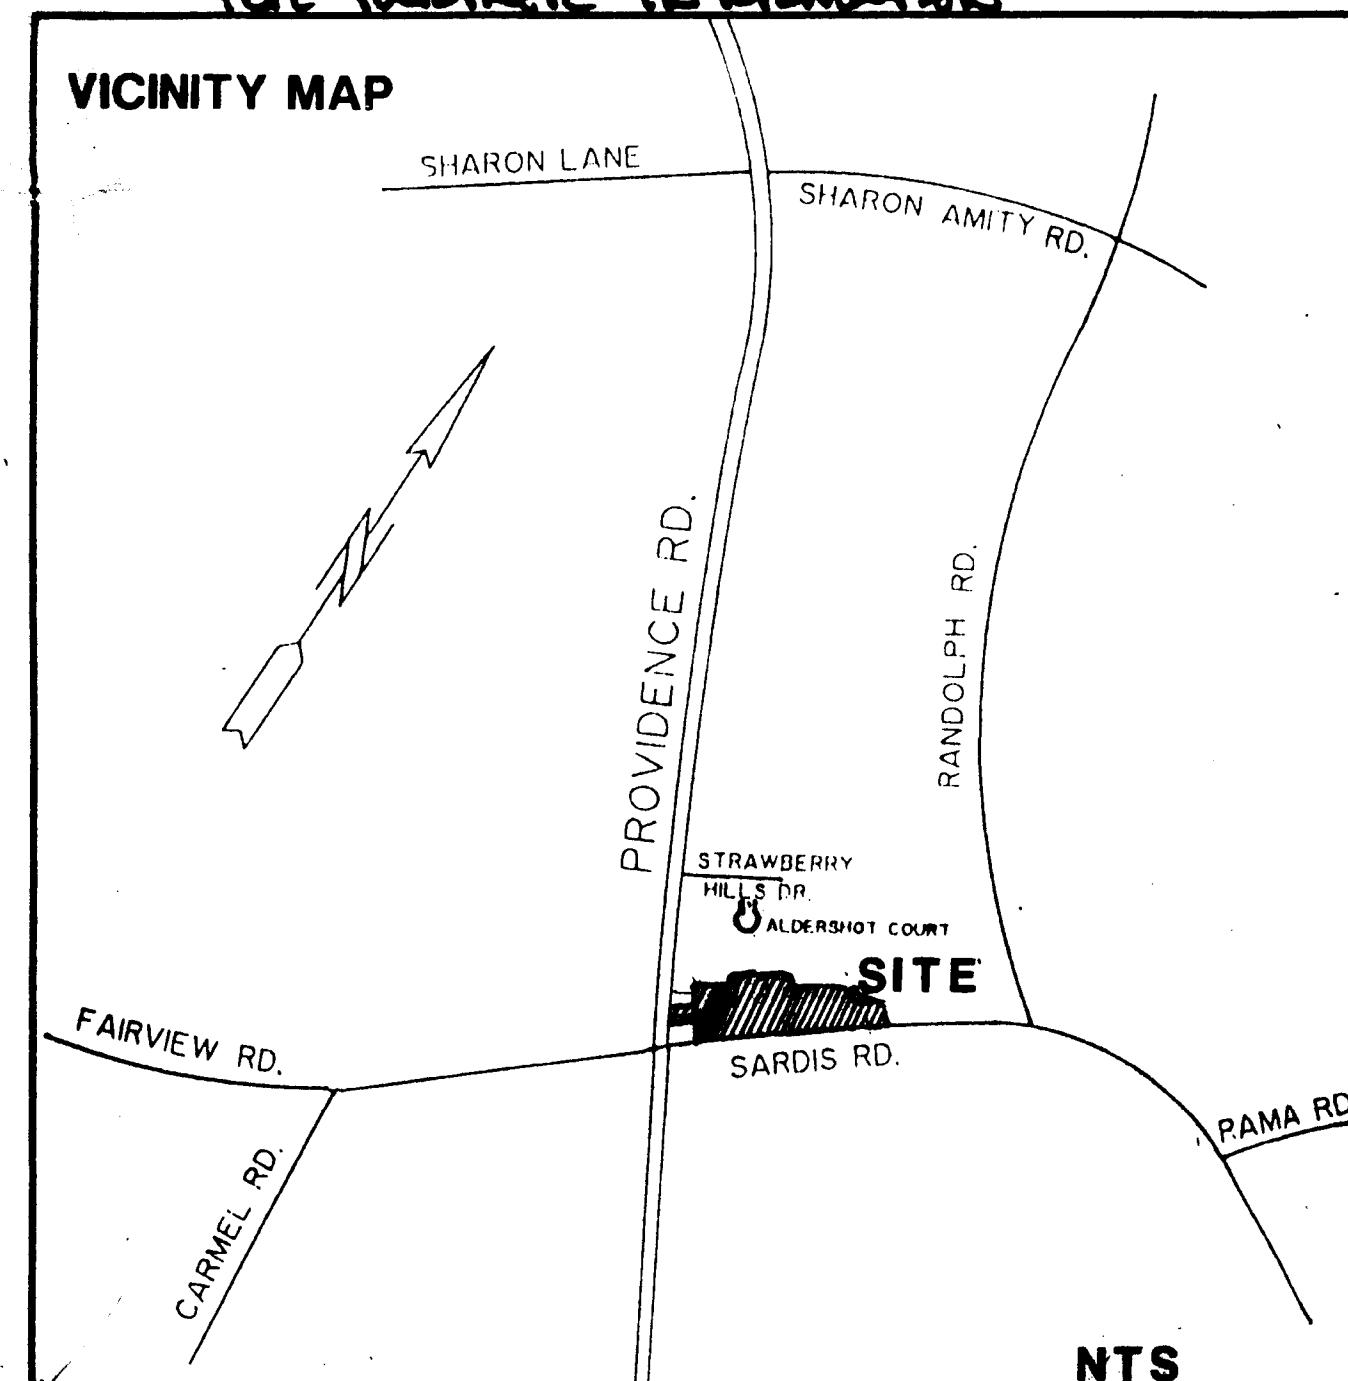

## COVER SHEET

Land Design  
DATE APRIL 30, 1990  
PROJECT NO 90551

1. 5/3/90 REVISED PER CITY  
2. CHARLOTTE REVIEW  
3. 5/7/90 SHOW PARKING TAB  
4. 5/7/90 IML WITI REVIEW  
4. 6/1/90 PER CITY REVIEW  
5. 7/10/90 PER CITY REVIEW

• 1701 East Boulevard, Charlotte, NC 28203 704-331-0325  
1216 Prince Street, Alexandria, VA 22311 703-549-7784  
225 Hillsborough Street, Raleigh, NC 919-834-8127

Land Design  
Landscape Architecture Land Planning  
Urban Design Civil Engineering

SHEET NO L 1  
OF \_\_\_\_\_

## CHARLOTTE-MECKLENBURG PLANNING COMMISSION INTER-OFFICE COMMUNICATION

DATE: November 13, 1990

TO: Robert Brandon  
Zoning Administrator

FROM: Martin R. Cranston, Jr.  
Planning Director

SUBJECT: Approved Landscape Plan for Petition No. 88-34 by Strawberry Hill Associates, Tax Parcel No. 185-121-29, 17

Attached is the construction documentation for the Strawberry Hill Shopping Center Landscape plan. This plan provides further detail of how administrative approval dated 9/10/90 is to be implemented. Joe Cochran and Keith MacVeau will be working with the contractor during construction to work out any unexpected problems and/or revisions to the approved plan. Pursuant to the authority granted to me by the Zoning Ordinance I am administratively approving this plan. Please use this plan when evaluating requests for building permits.


MRCjr/KHM/cln

Attachment

# STRAWBERRY HILL CENTER

MARSH REALTY COMPANY  
P.O. BOX 3529 CHARLOTTE, NC 28217


## CLEARING & TREE PROTECTION PLAN

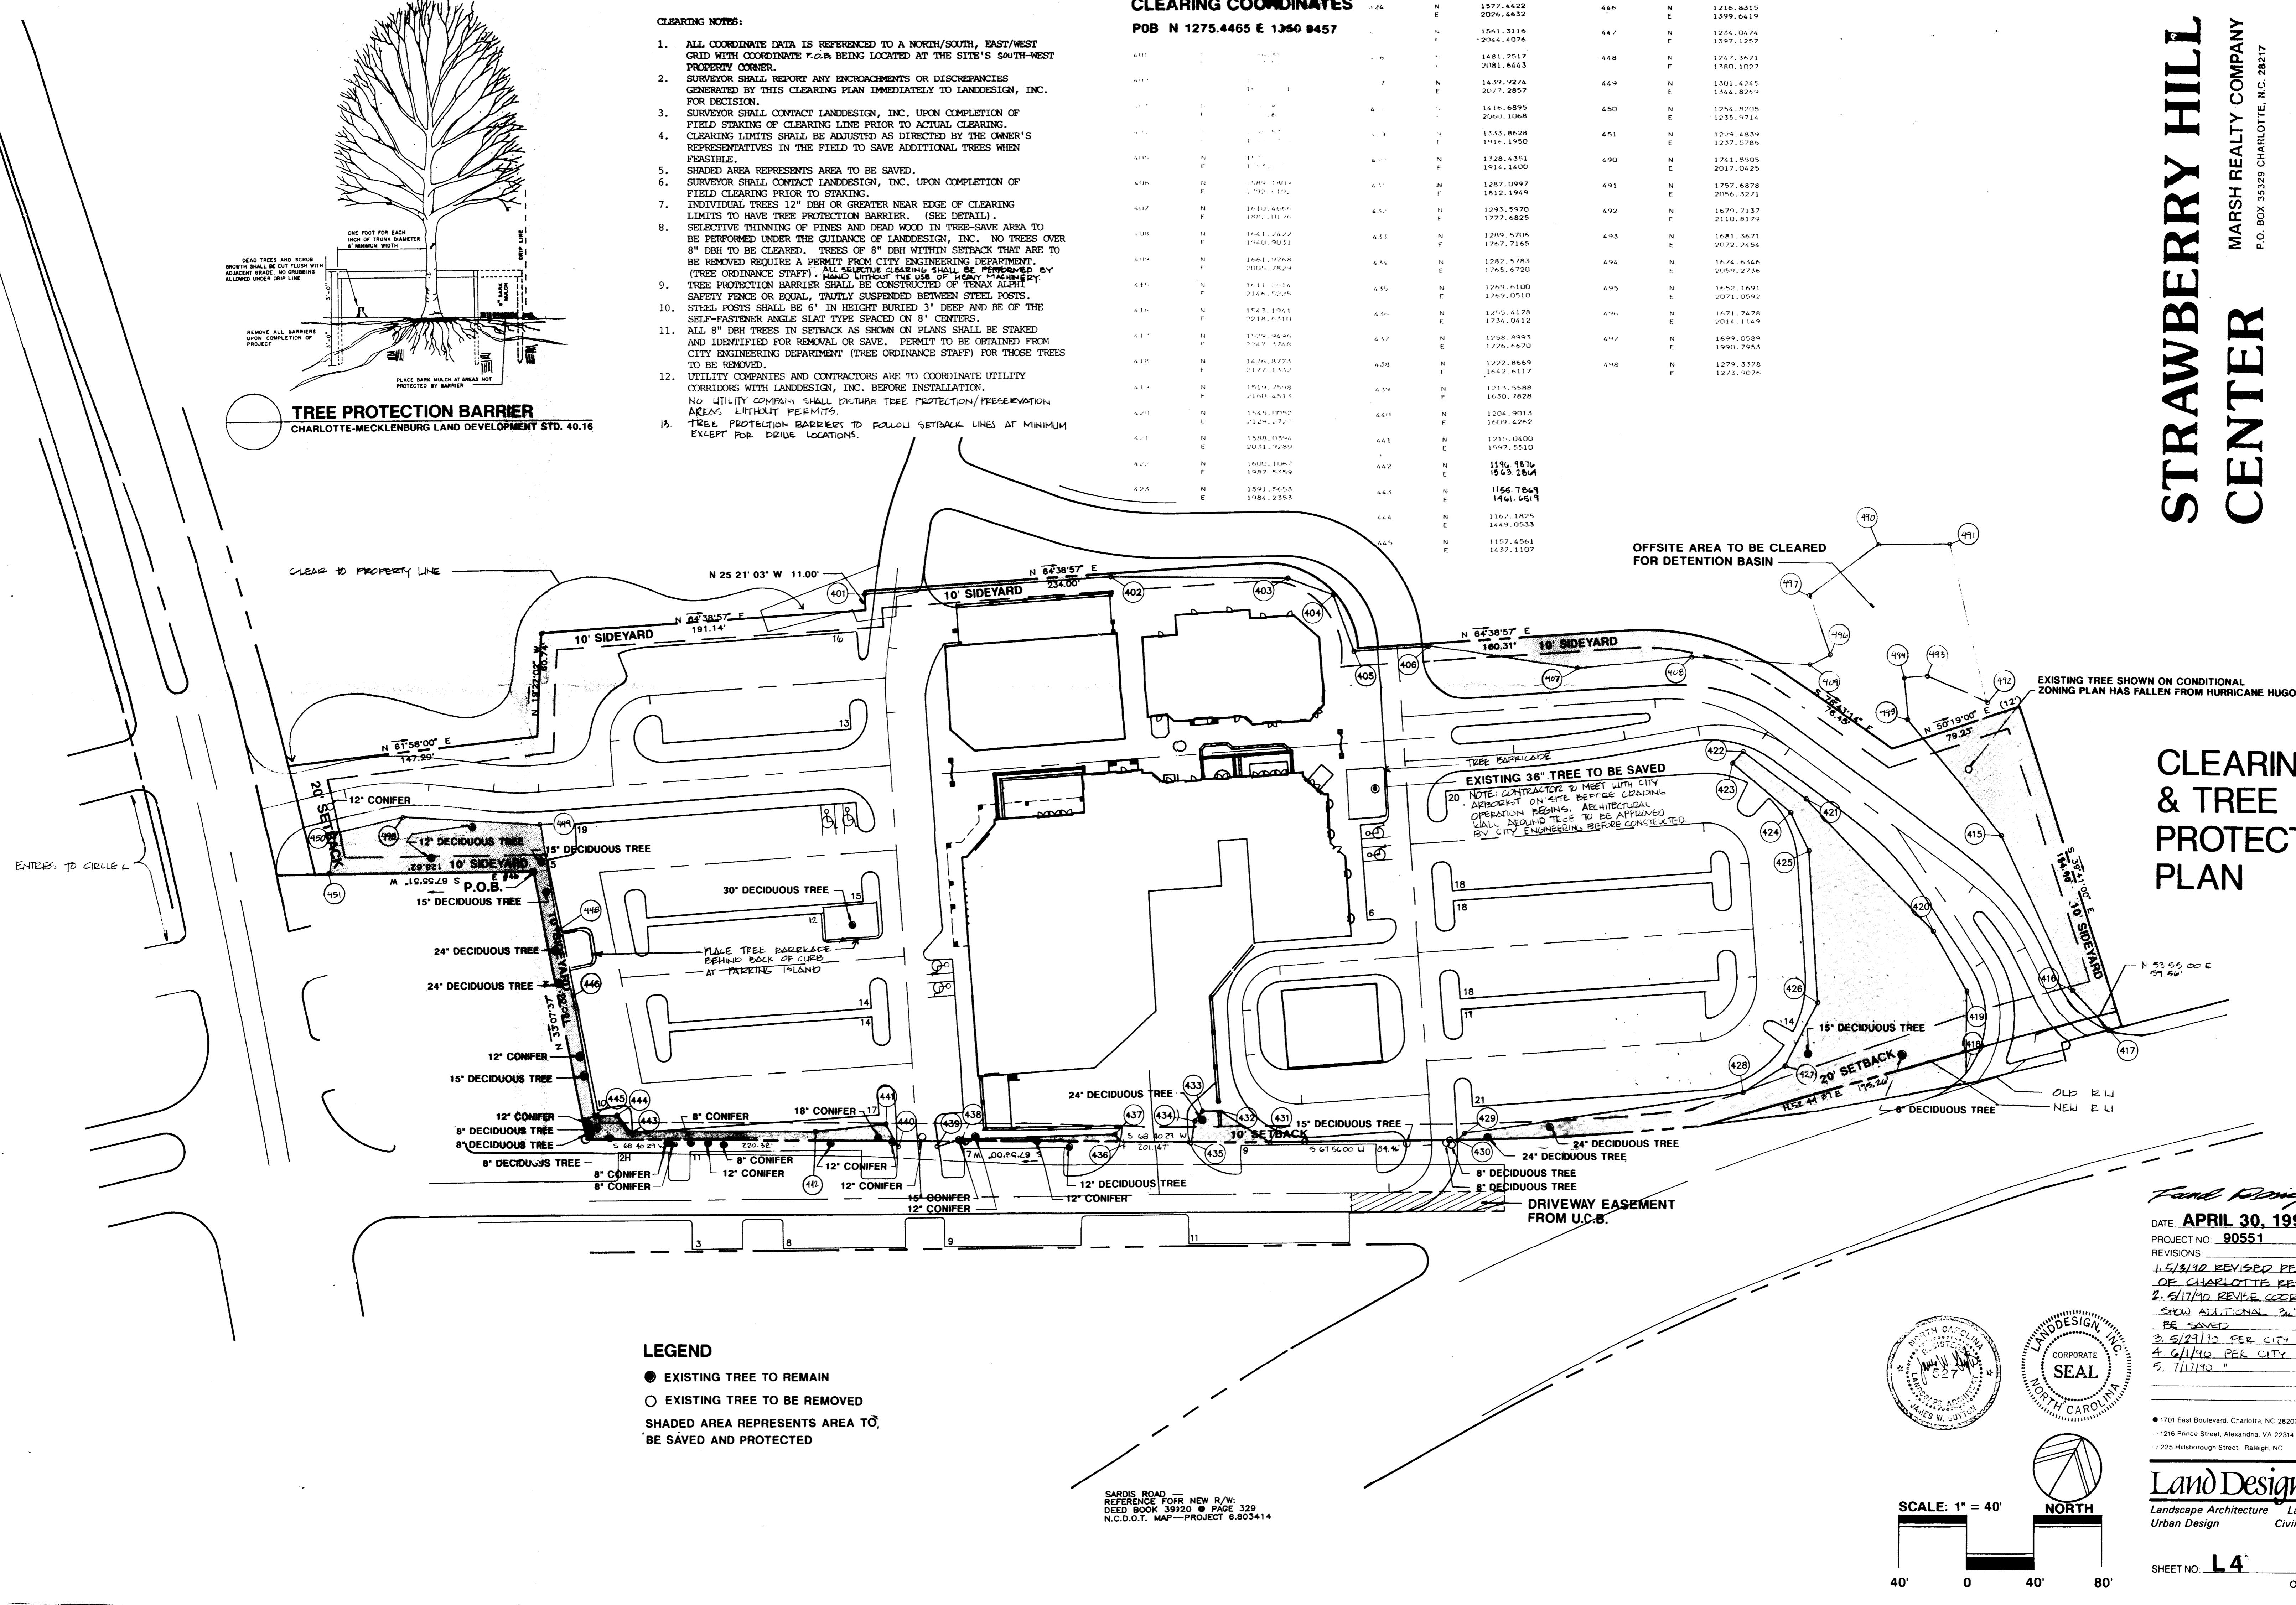

# STRAWBERRY HILL CENTER


MARSH REALTY COMPANY  
P.O. BOX 3529 CHARLOTTE, NC 28217

## STAKING PLAN

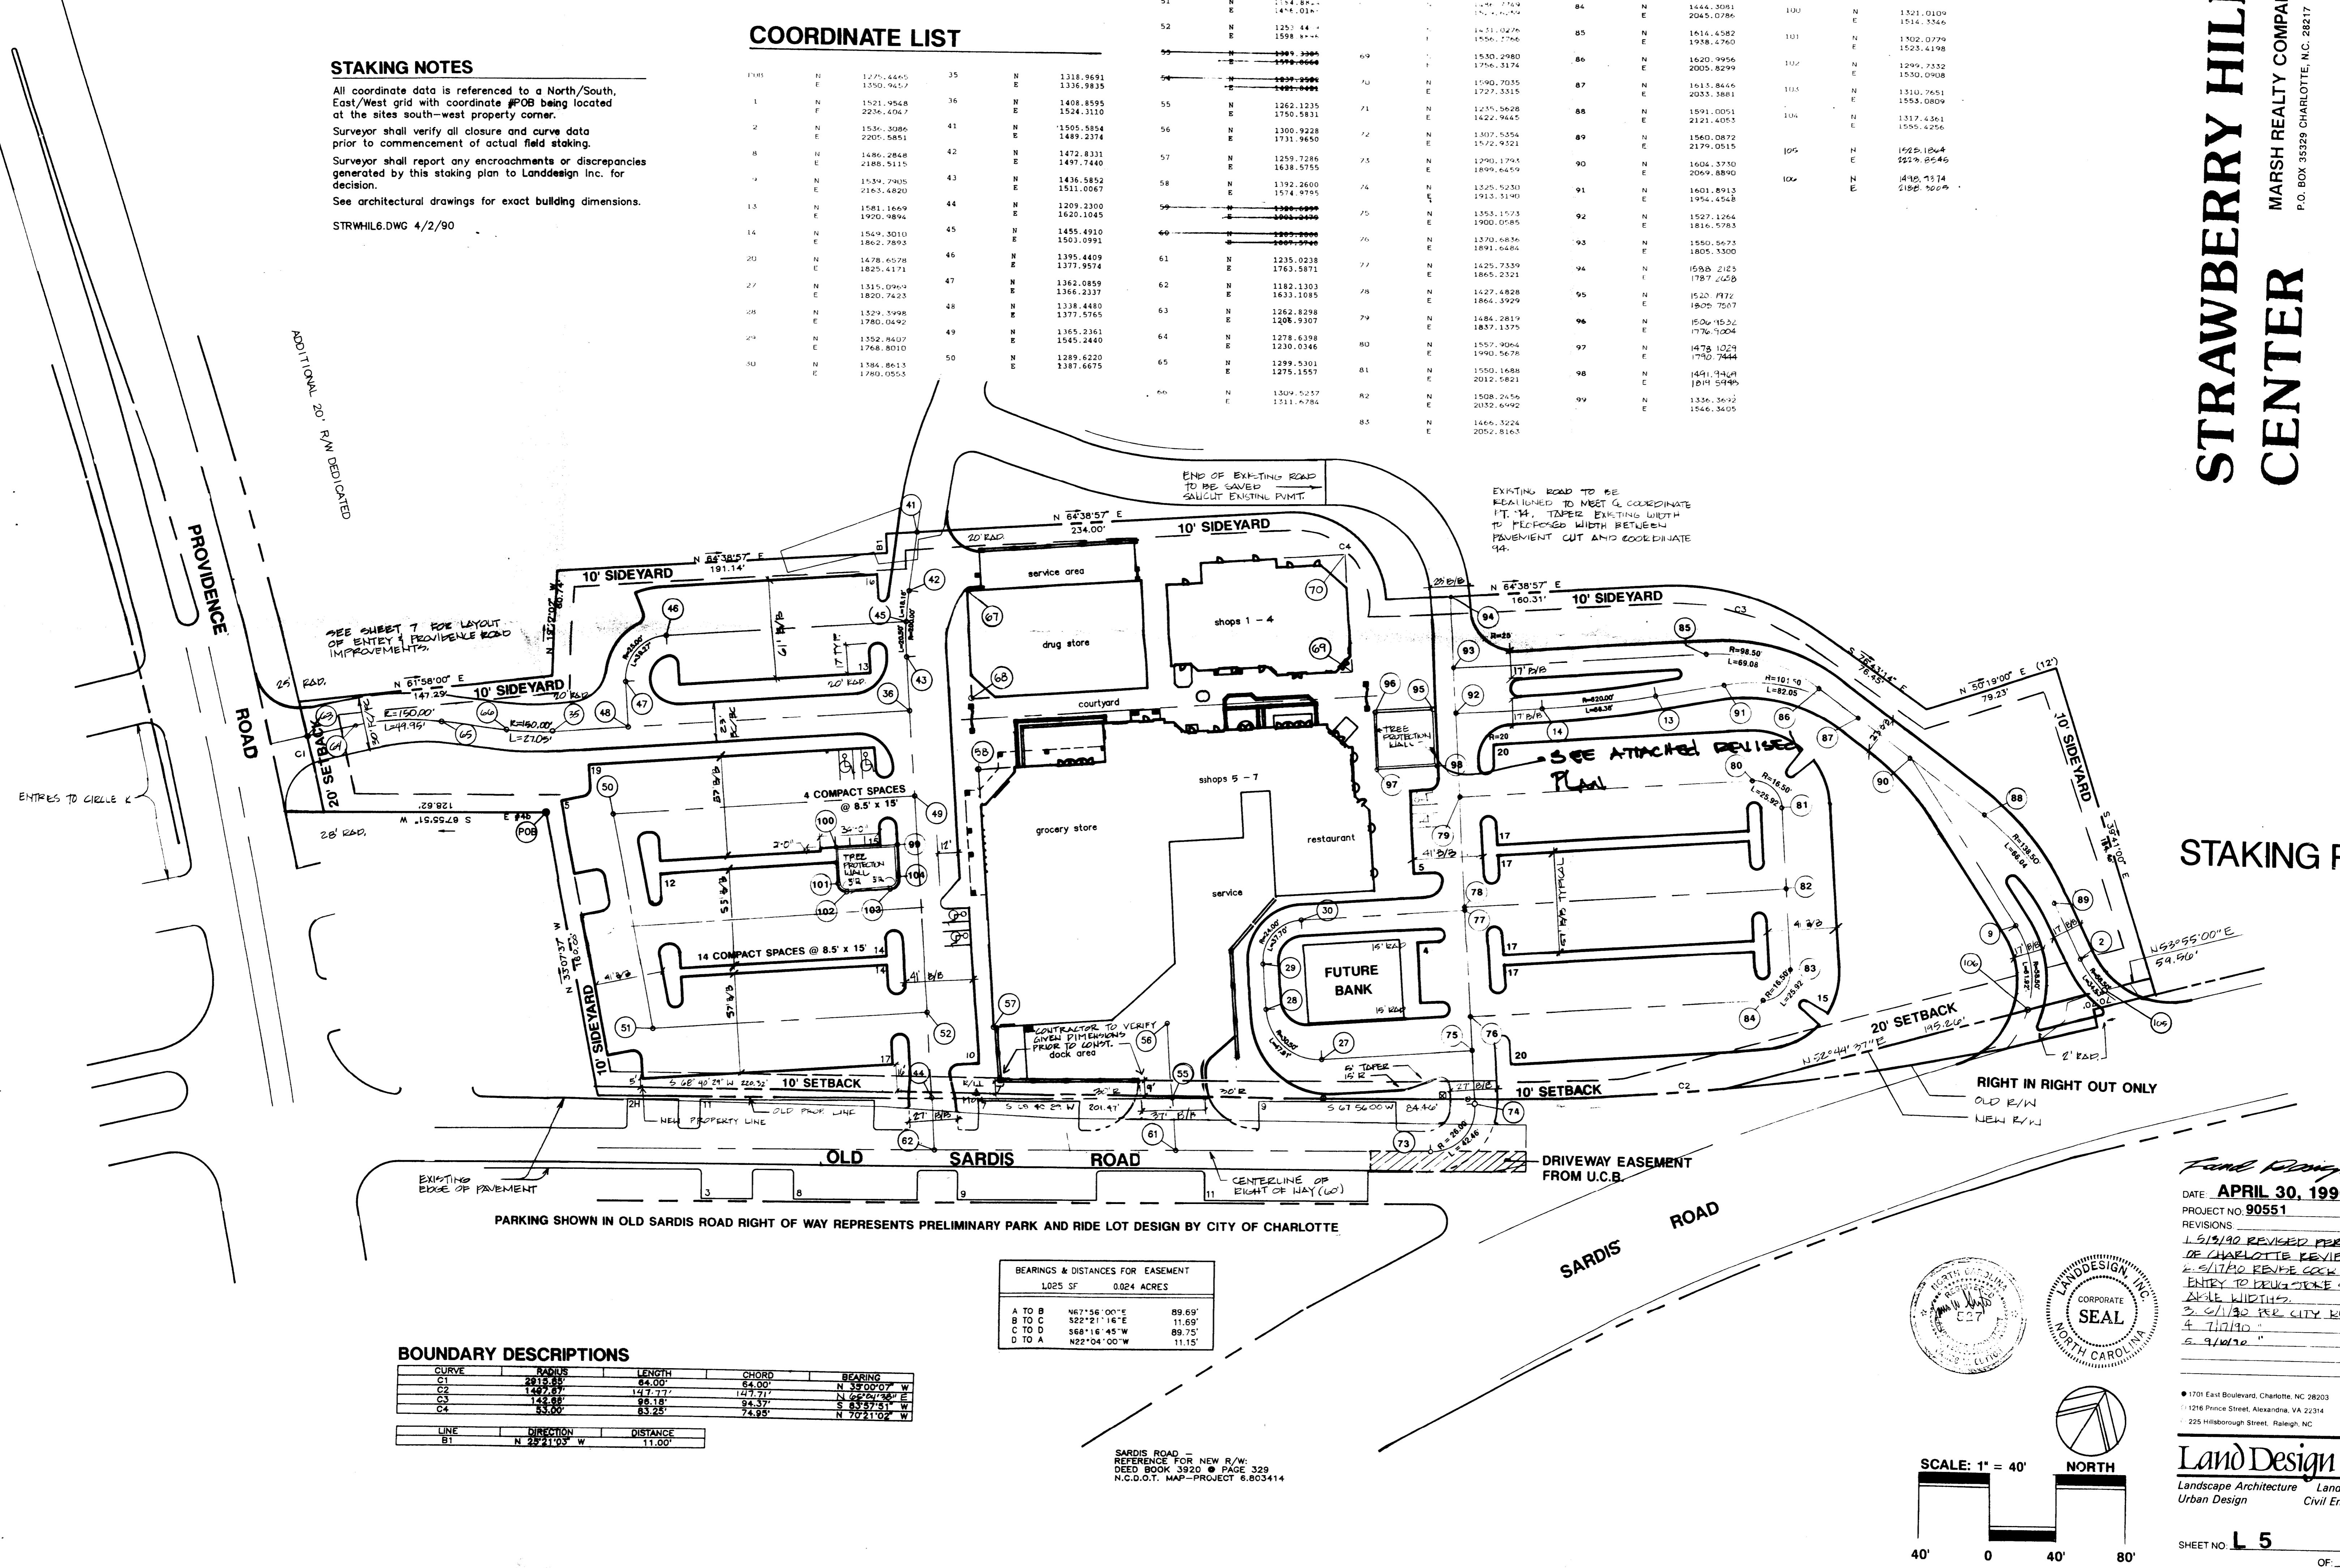

**STRAWBERRY HILL  
CENTER**

MARSH REALTY COMPANY  
P.O. BOX 35320 CHARLOTTE, NC 28217

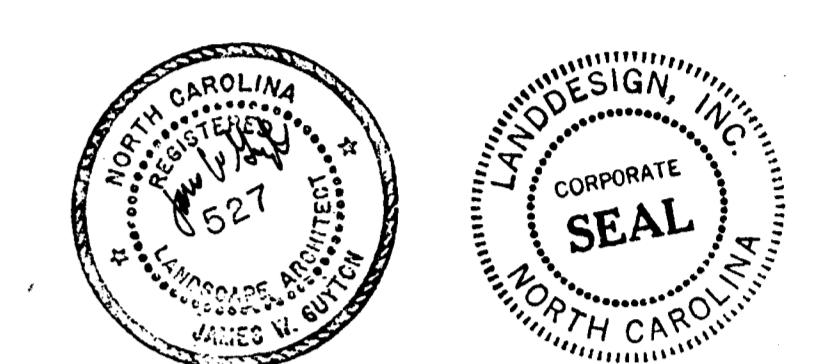

**PLANTING PLAN**

CHARTERED TREE COMMISSION  
SITE ALLOCATION PLAN APPROVED  
REVIEWED: *Jay G.*  
DATE: *4/30/90*

SCALE 1'=20'  
NORTH

*Floyd Ringer*  
DATE: APRIL 30, 1990  
PROJECT NO. 90551  
REVISIONS:  
1. 5/3/90 REVISED PER CITY  
OF CHARLOTTE REVIEW  
2. 5/10/90 REVISIONS  
3. 5/18/90 PLANT COURTYARD  
4. 5/23/90 PER CITY REVIEW  
5. 6/1/90 PER CITY REVIEW  
6. 7/17/90  
7. 7/10/90 PER CITY REVIEW

• 1701 East Boulevard, Charlotte, NC 28203 704/333-0325  
• 1716 Prince Street, Alexandria, VA 22314 703/539-7784  
225 Hillsborough Street, Raleigh, NC 919/834-6977

**Land Design**

Landscape Architecture Land Planning  
Urban Design Civil Engineering

SHEET NO. L12 OF \_\_\_\_\_

**STRAWBERRY HILL  
CENTER**

MARSH REALTY COMPANY  
P.O. BOX 35320 CHARLOTTE, NC 28217

NOTE: COURTYARD AND PLANTING PLANS  
TO BE PLANTED AT A LATER DATE.



**PLANTING PLAN**

CHARTERED TREE COMMISSION  
SITE ALLOCATION PLAN APPROVED  
REVIEWED: *Jay G.*  
DATE: *4/30/90*

SCALE 1'=20'  
NORTH

*Floyd Ringer*  
DATE: APRIL 30, 1990  
PROJECT NO. 90551  
REVISIONS:  
1. 5/3/90 REVISED PER CITY  
OF CHARLOTTE REVIEW  
2. 5/10/90 REVISIONS  
3. 5/18/90 PLANT COURTYARD  
4. 5/23/90 PER CITY REVIEW  
5. 7/17/90

• 1701 East Boulevard, Charlotte, NC 28203 704/333-0325  
• 1716 Prince Street, Alexandria, VA 22314 703/539-7784  
225 Hillsborough Street, Raleigh, NC 919/834-6977

**Land Design**

Landscape Architecture Land Planning  
Urban Design Civil Engineering


SHEET NO. L13 OF \_\_\_\_\_

# STRAWBERRY HILL CENTER

MARSH REALTY COMPANY  
P.O. BOX 35320 CHARLOTTE, NC 28217



## PLANTING SCHEDULE & DETAILS

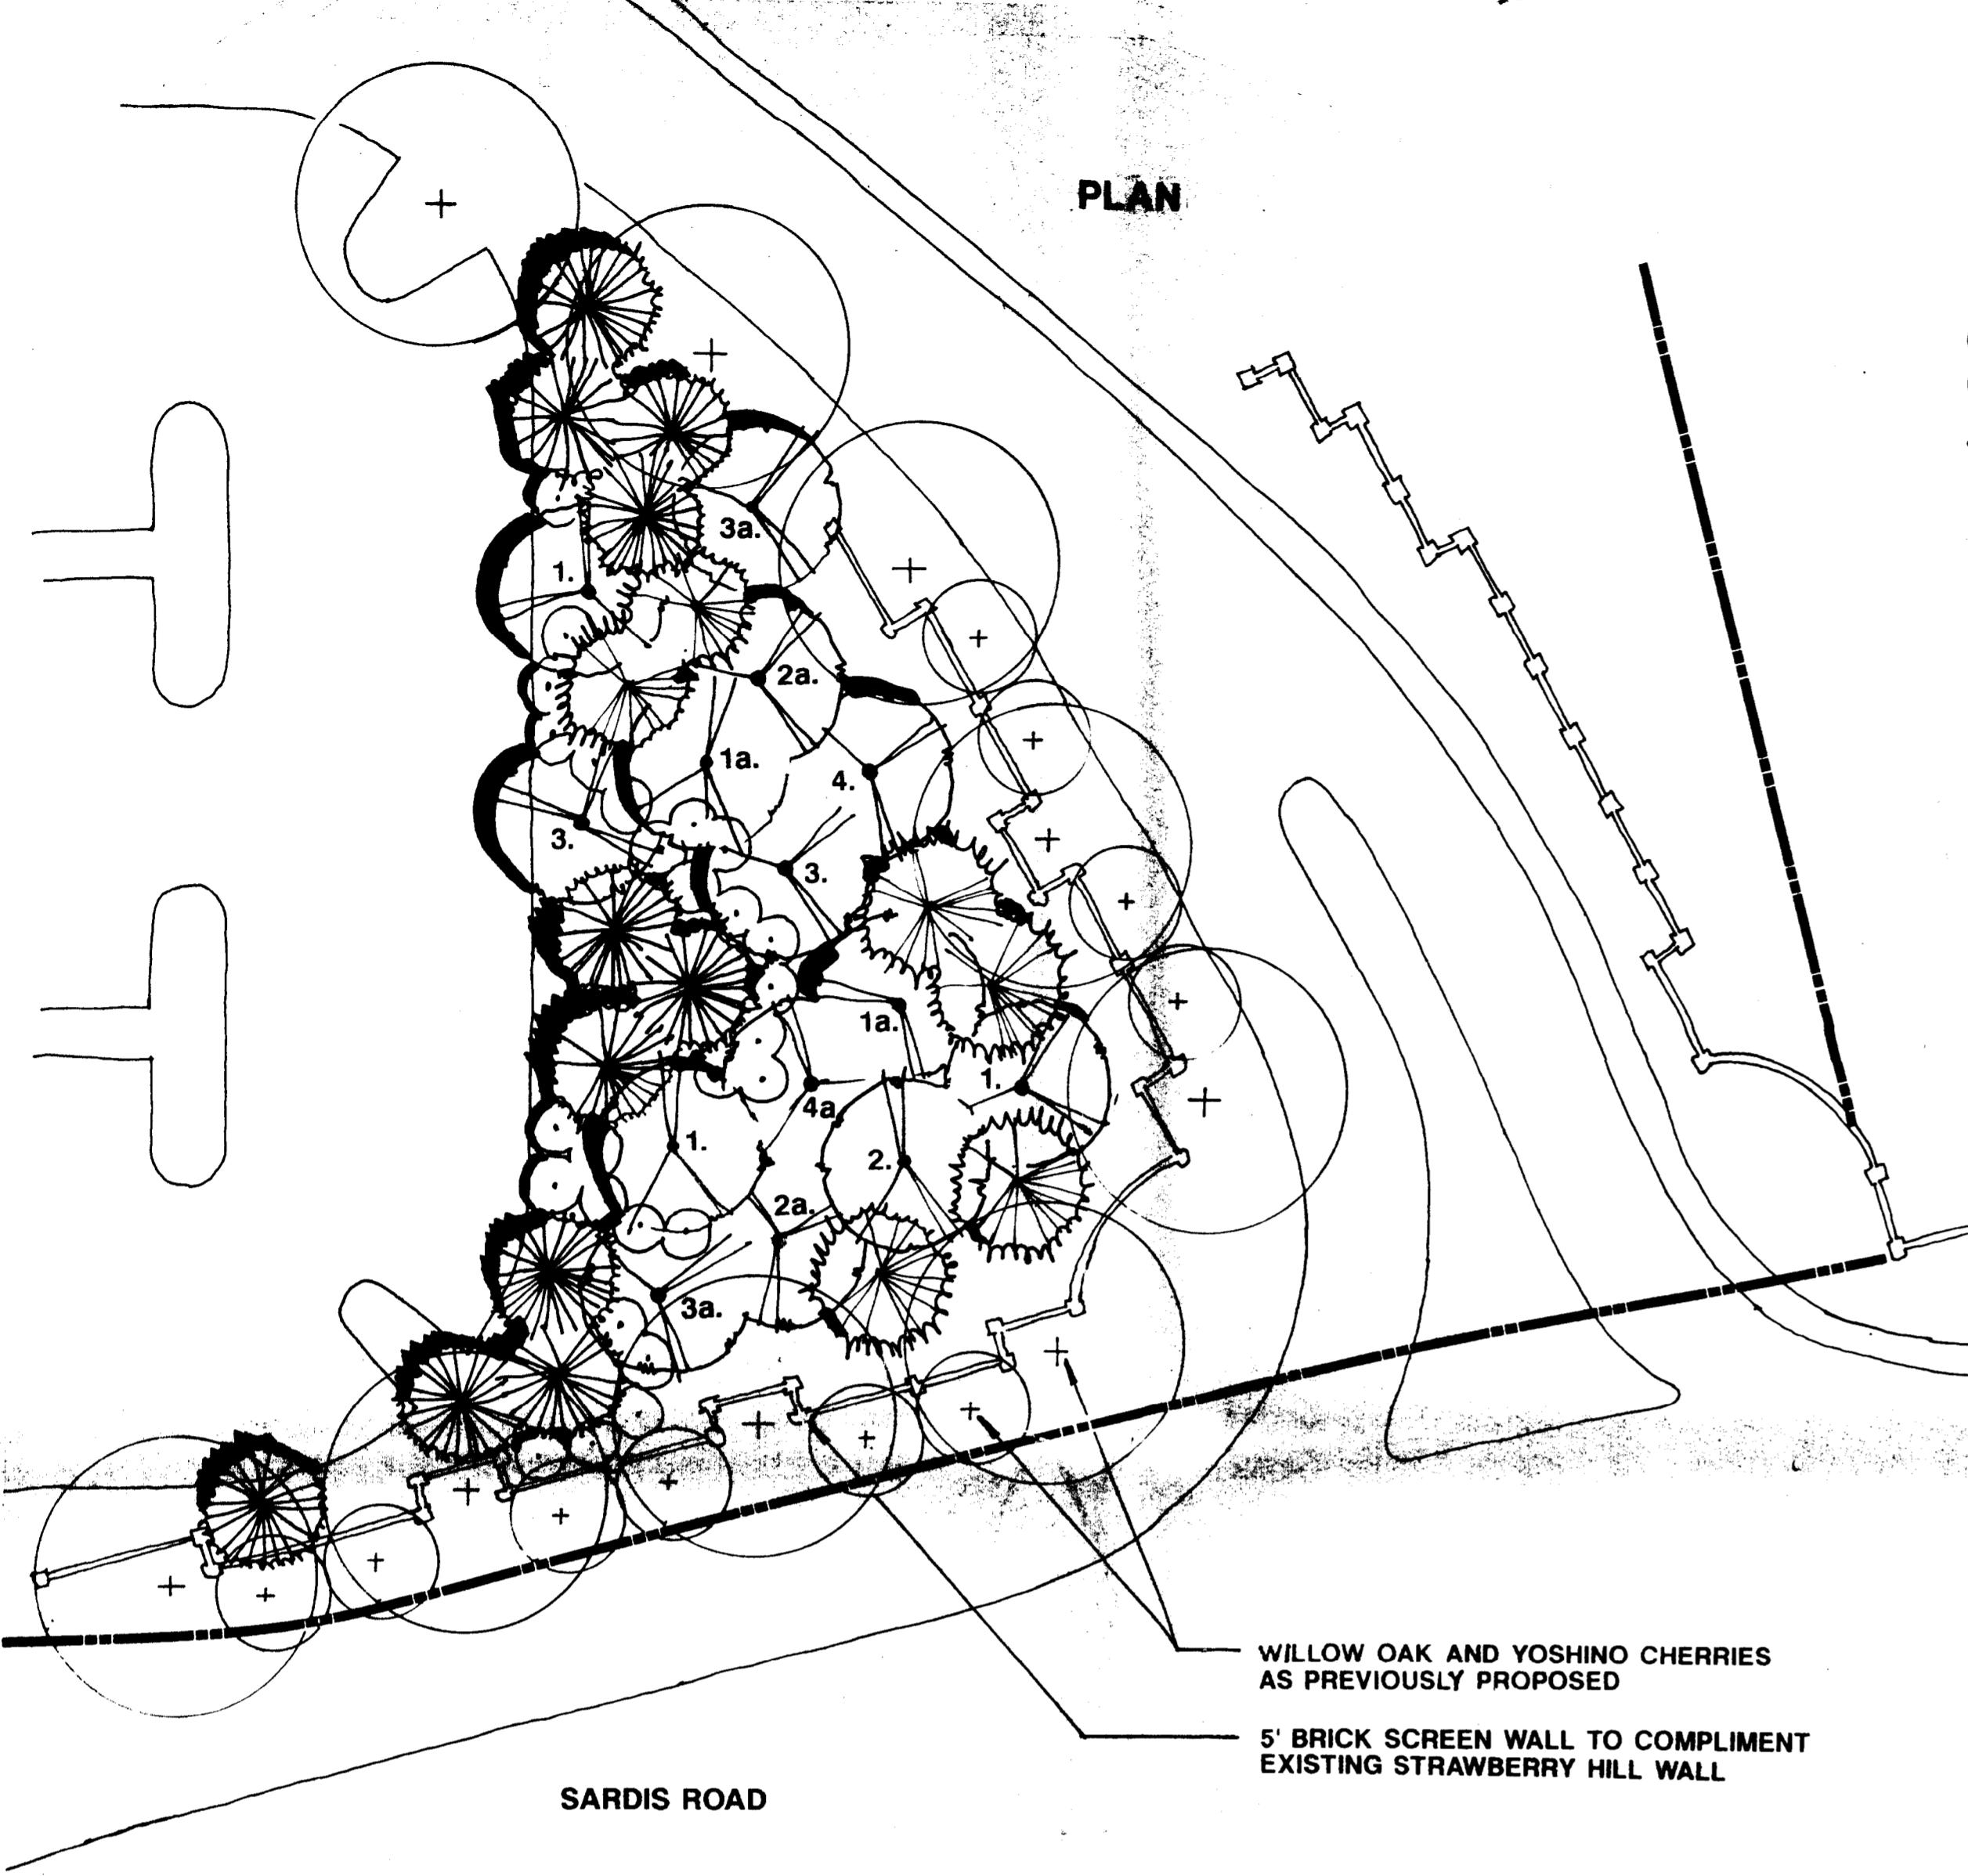

### PLANT SCHEDULE

SYMBOL	QTY.	SCIENTIFIC NAME COMMON NAME	CAL.	HGT.	COND.	NOTES
1.	3	Celtis occidentalis Hackberry	3 1/2"-4"	B&B		
1a.	2	Celtis occidentalis Hackberry	4 1/2"-5"			
2.	1	Carya spp. Hickory	3 1/2"-4"	B&B		
2a.	2	Carya spp. Hickory	4 1/2"-5"			
3.	2	Quercus rubra Red Oak	3 1/2"-4"	B&B		
3a.	2	Quercus rubra Red Oak	4 1/2"-5"			
4.	1	Quercus alba White Oak	3 1/2"-4"	B&B		
4a.	1	Quercus alba White Oak	4 1/2"-5"			
27	Myrica cerifera Wax Myrtle		6-7'	B&B		
11	Cupressaceae Eastern Redcedar		16'-10"	B&B	Field Grown Locally	
6	Pinus virginiana Virginia Pine		8-10'	B&B		

#### General Notes:

1. Buffer area to be mulched with 4" of pine needle mulch.

### 1 PLANTING PLAN, SCHEDULE & NOTES @ DISTURBED BUFFER AREA 14 SCALE: 1"=20'

### CONSTRUCTION SEQUENCE CONTACT SCHEDULE

- The Planning Commission staff, the Urban Forestry staff, and the Zoning Administrators office must be contacted before and during the following construction events.
    - Before trenching begins at base of Hackberry and post oak. Areas beyond trench to be clearly marked and tree protection devices installed. Before and during this operation.
    - Before and during retaining wall construction.
    - Before arborist begins work and once work is completed. If any structural pruning is required, the reason is to occur for either root loss mitigation or aesthetic reasons. Only structural pruning should occur.
    - After topsoil is redistributed.
    - Before, during, and after new trees are planted.
- Please contact Keith MacVean, Planning 336-2205; Joe Cochran, Urban Forestry 336-4254; and Sherry Williamson, Zoning 336-3571.

### PLANT SCHEDULE

SYMBOL	QTY.	SCIENTIFIC NAME COMMON NAME	CAL.	HGT.	SPD.	COND.	NOTES
<b>TREES</b>							
ACEP	2	Acer palmatum 'Bloodgood'		6'-8"		B&B	Specimen Tree
ACPL	7	Acer platanoides Norway Maple		2"-2 1/2"		B&B	
ARAR	3	Acer rubrum 'Armstrong' Armstrong Red Maple		1 1/2"-2"		B&B	Columnar Specimen
BETN	6	Betula nigra River Birch		1 1/4"-1 1/2"	6'-8"	B&B	
CARC	7	Carpinus caroliniana American Hornbeam		10"-12"		B&B	Specimen Tree
TINS	19	Ilex x 'Nellie Stevens' Nellie Stevens Holly		1 1/4" Min. 9"-11"		B&B	Tree Form
LAGI	19	Lagerstroemia indica Crape Myrtle		6'-7"		B&B	Multi-Stem, Lavendar Flowering, Tree Form
PRUY	45	Prunus yedoensis Yoshino Cherry		1 1/2"-2"		B&B	
QUEP	46	Quercus Phellos Willow Oak		2 1/2"-3"		B&B	
<b>SHRUBS</b>							
ICUN	289	Ilex cornuta 'Burford Nana' Dwarf Burford Holly		36"	30"-36"	5 Gal.	5' o.c.
ICCA	542	Ilex cornuta 'Carissa' Carriera Holly		18"-24"	18"-24"	2 Gal.	3' o.c.
ILVS	41	Ilex vomitoria 'Shillings' Dwarf Yaupon Holly		15"-18"		2 Gal.	
JUDP	324	Juniperus davurica 'Personii' Person's Juniper		18"-24"	2 Gal.	3' o.c.	
LIJR	2	Ligustrum japonicum 'Rotundifolium' Curlyleaf Ligustrum		18"-24"		3 Gal.	
<b>GROUND COVER</b>							
ANNU	446	Annuals - Seasonal Color			4" Pot	8" o.c.	
HEDH	1231	Hedera helix English Ivy			4" Pot	8-12" o.c.	
<b>GENERAL NOTES</b>							
1. Contractor is responsible for verifying all quantities. 2. Mulch all plant beds with 4" of Pine Needle mulch. 3. Apply pre-emergent herbicide to planting beds prior to mulching. 4. Seed all disturbed areas on project site except planting beds with Pescue mix. 5. Plant material may not be substituted without approval of Landscape Architect or Architect.							


### CONDITIONAL NOTES

#### I. Existing Trees (Hackberry & Large White Oak)


- A watering program was initiated Monday, July 1, 1990 as described in the memo from the tree ordinance dept. dated July 1, 1990. This program will continue throughout the duration of construction.
- The undisturbed area for the existing trees will be increased by modifying the road and parking layout as indicated on the proposed plan.
- Prior to the restart of construction, a tree barrier equal to the drip line plus 10' will be constructed around these trees and no construction equipment other than that related to walls, shown on the original layout plan and attached detail, shall be allowed within this area. Rough grading surrounding these trees, shall not be completed until the surrounding structural part of the new wall is in place. The tree protection/retaining wall will be field located and constructed as described in detail. During construction of the walls PVC sleeves will be installed for the irrigation lines to prevent future disturbance of the undisturbed area.
- No utility lines other than noted will be constructed within the undisturbed area defined by tree protection/retaining wall.
- Private arborist services will be obtained as soon as possible to initiate a tree fertilization and maintenance program. The arborist service shall submit the proposal and bid to the city by June 25th for review and approval by the city tree ordinance staff. The program is to continue at a minimum of 12 months after construction completion.
- Maintenance and fertilization program will be initiated with the administrative approval of the buffer replanting plan.

#### II. Graded/Cleared Area at Sardis Road

- All large stumps preventing the spreading of top soil will be removed from the cleared area. A minimum of 8" of top soil will be evenly spread over the cleared area by a rubber tired tractor and box blade. Any rubber tired equipment will be allowed in this area to minimize compaction.

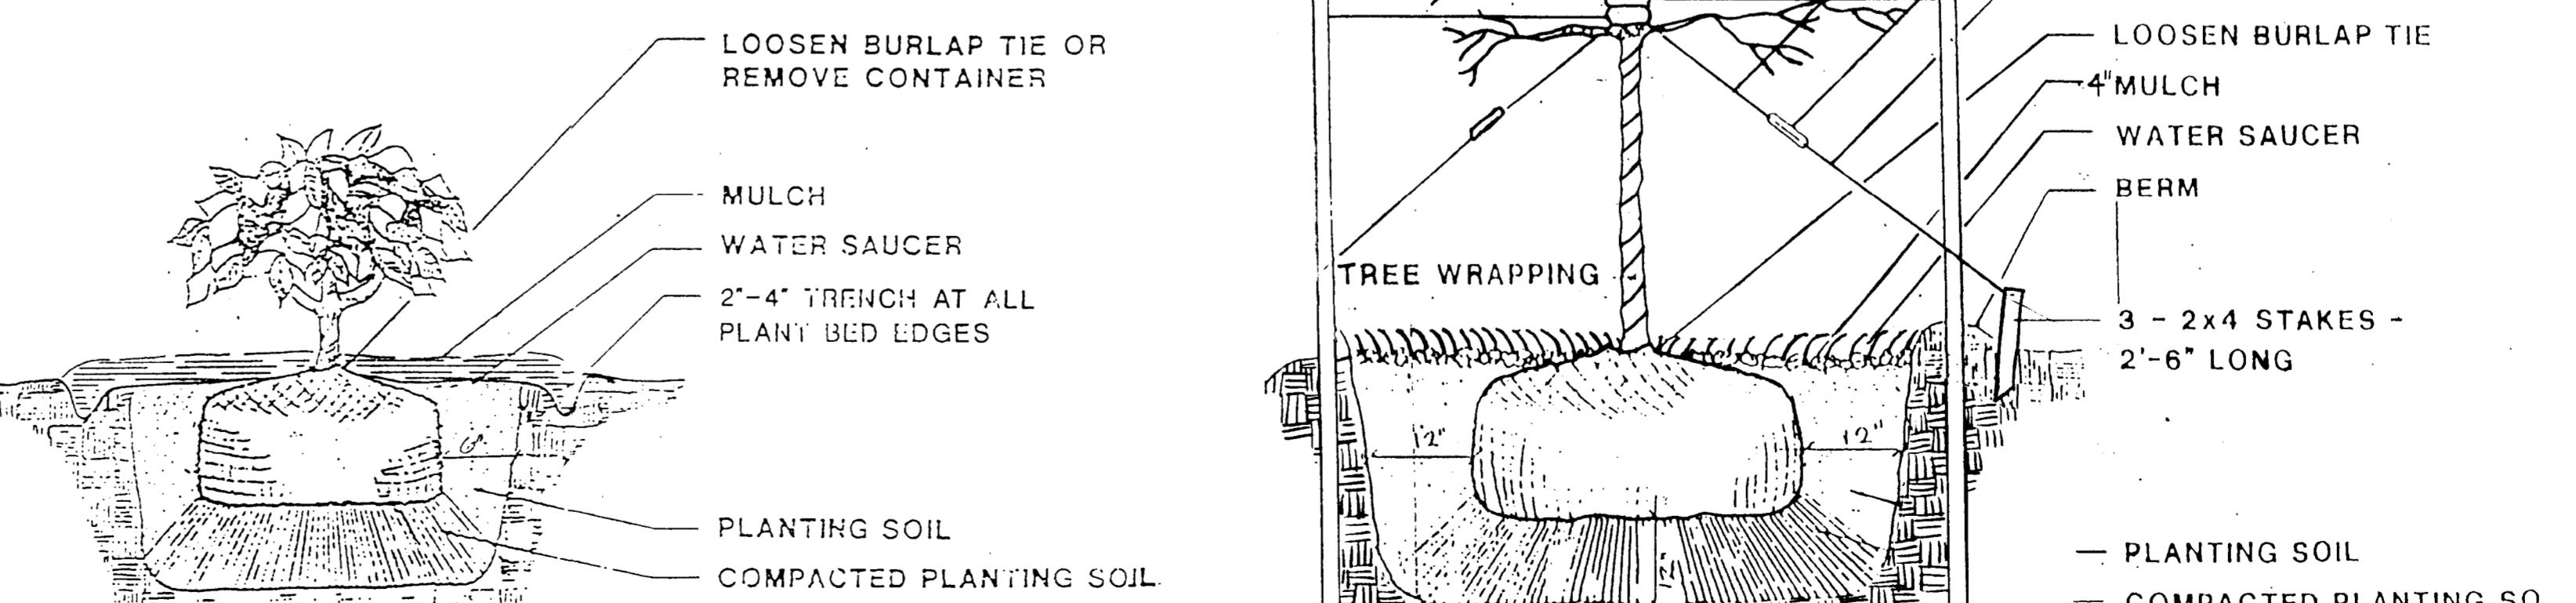

### 2 SHRUB PLANTING NTS 14

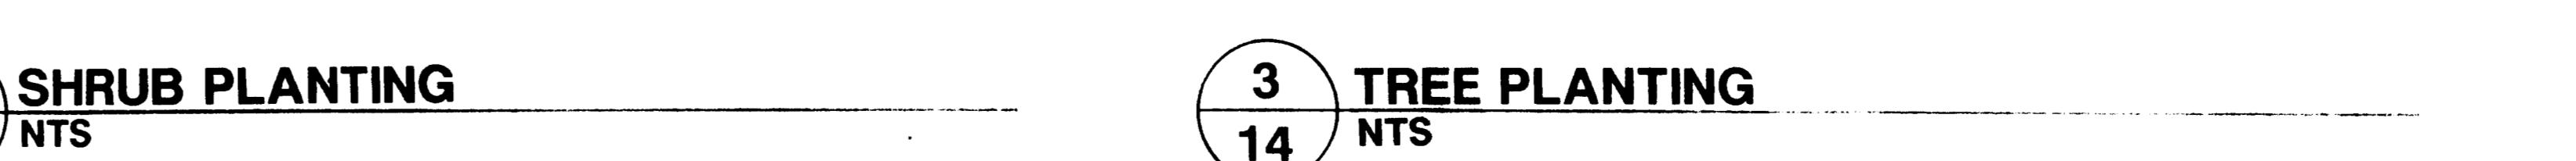

*Land Design*  
APRIL 30, 1990

PROJECT NO. 90551

REVISIONS

LS/3/90 REVISED PER CITY

OF CHARLOTTE REVIEW

2/5/90 REVISED "LAGI" CITY

3/5/90 PLANT LIST

4/6/90 PER CITY REVIEW

5/6/90 PER CITY REVIEW

6/1/90 "

1701 East Boulevard, Charlotte, NC 28203 704/333-0325



1216 Prince Street, Alexandria, VA 22314 703/549-7784

225 Hillsborough Street, Raleigh, NC 919/834-6177

**Land Design**  
Landscape Architecture Land Planning  
Urban Design Civil Engineering

SHEET NO. L14

**STRAWBERRY HILL**  
AERATION DETAIL FOR ADDITIONAL TREE TO BE SAVED

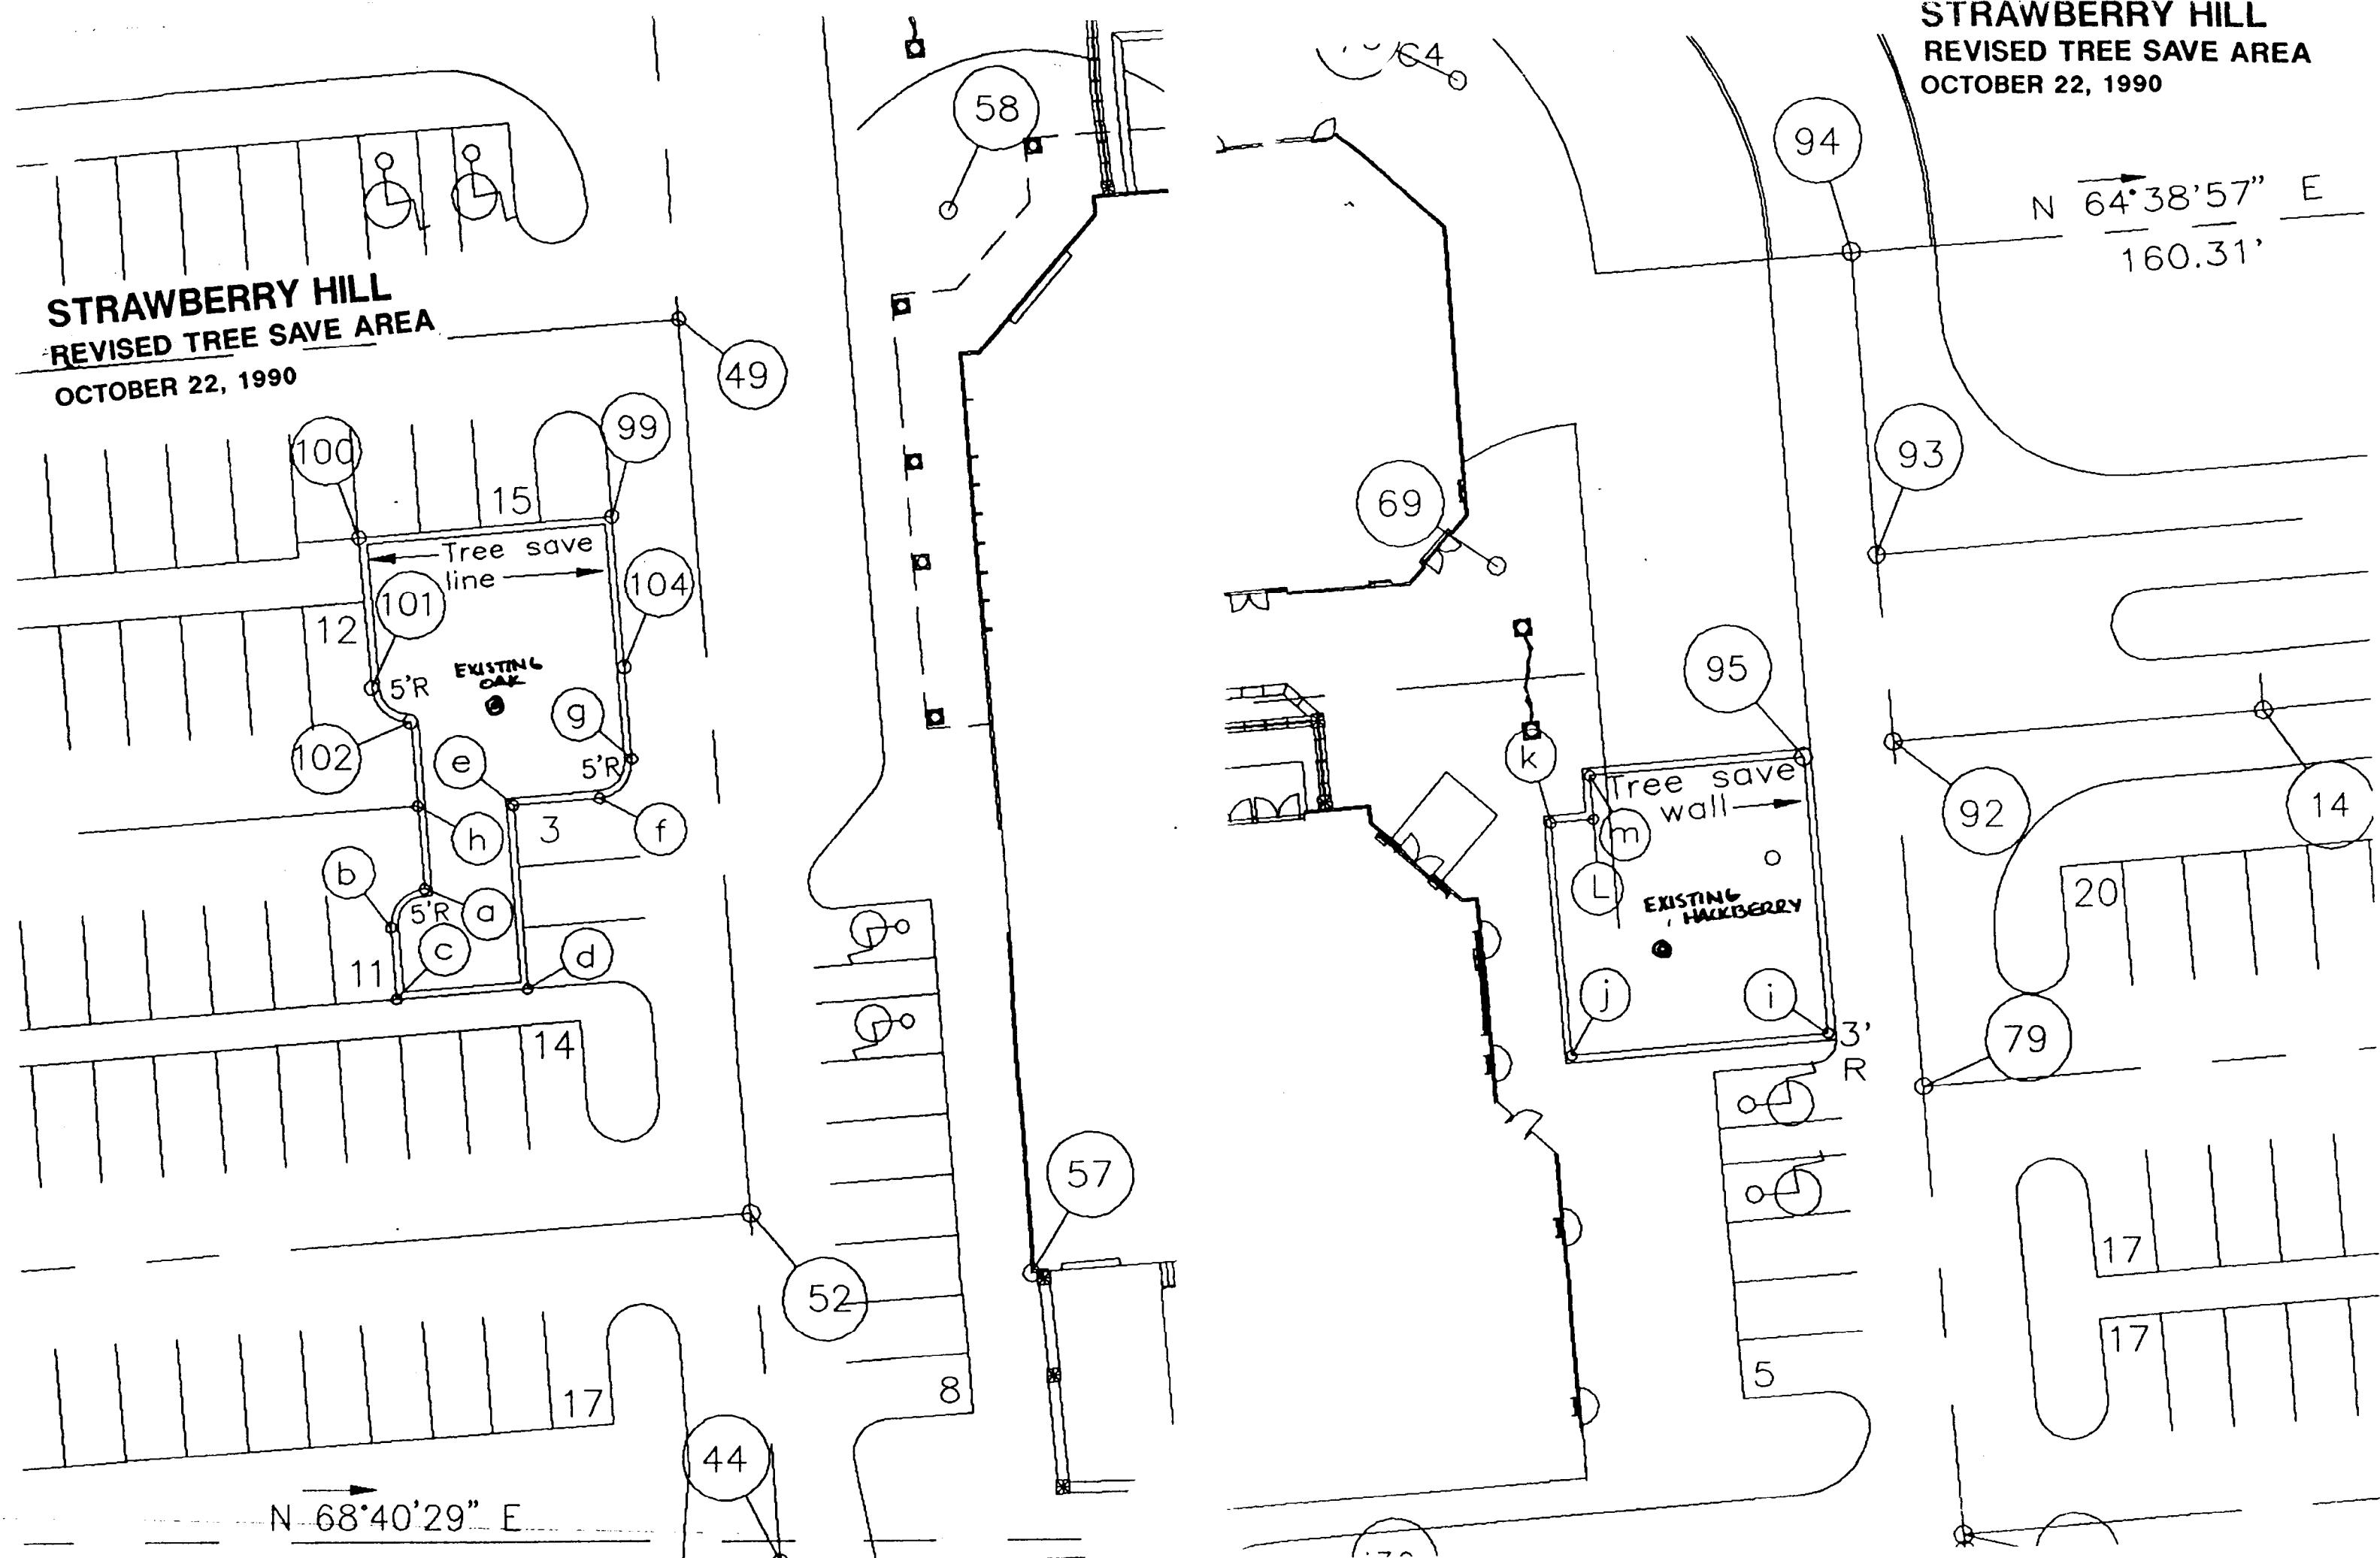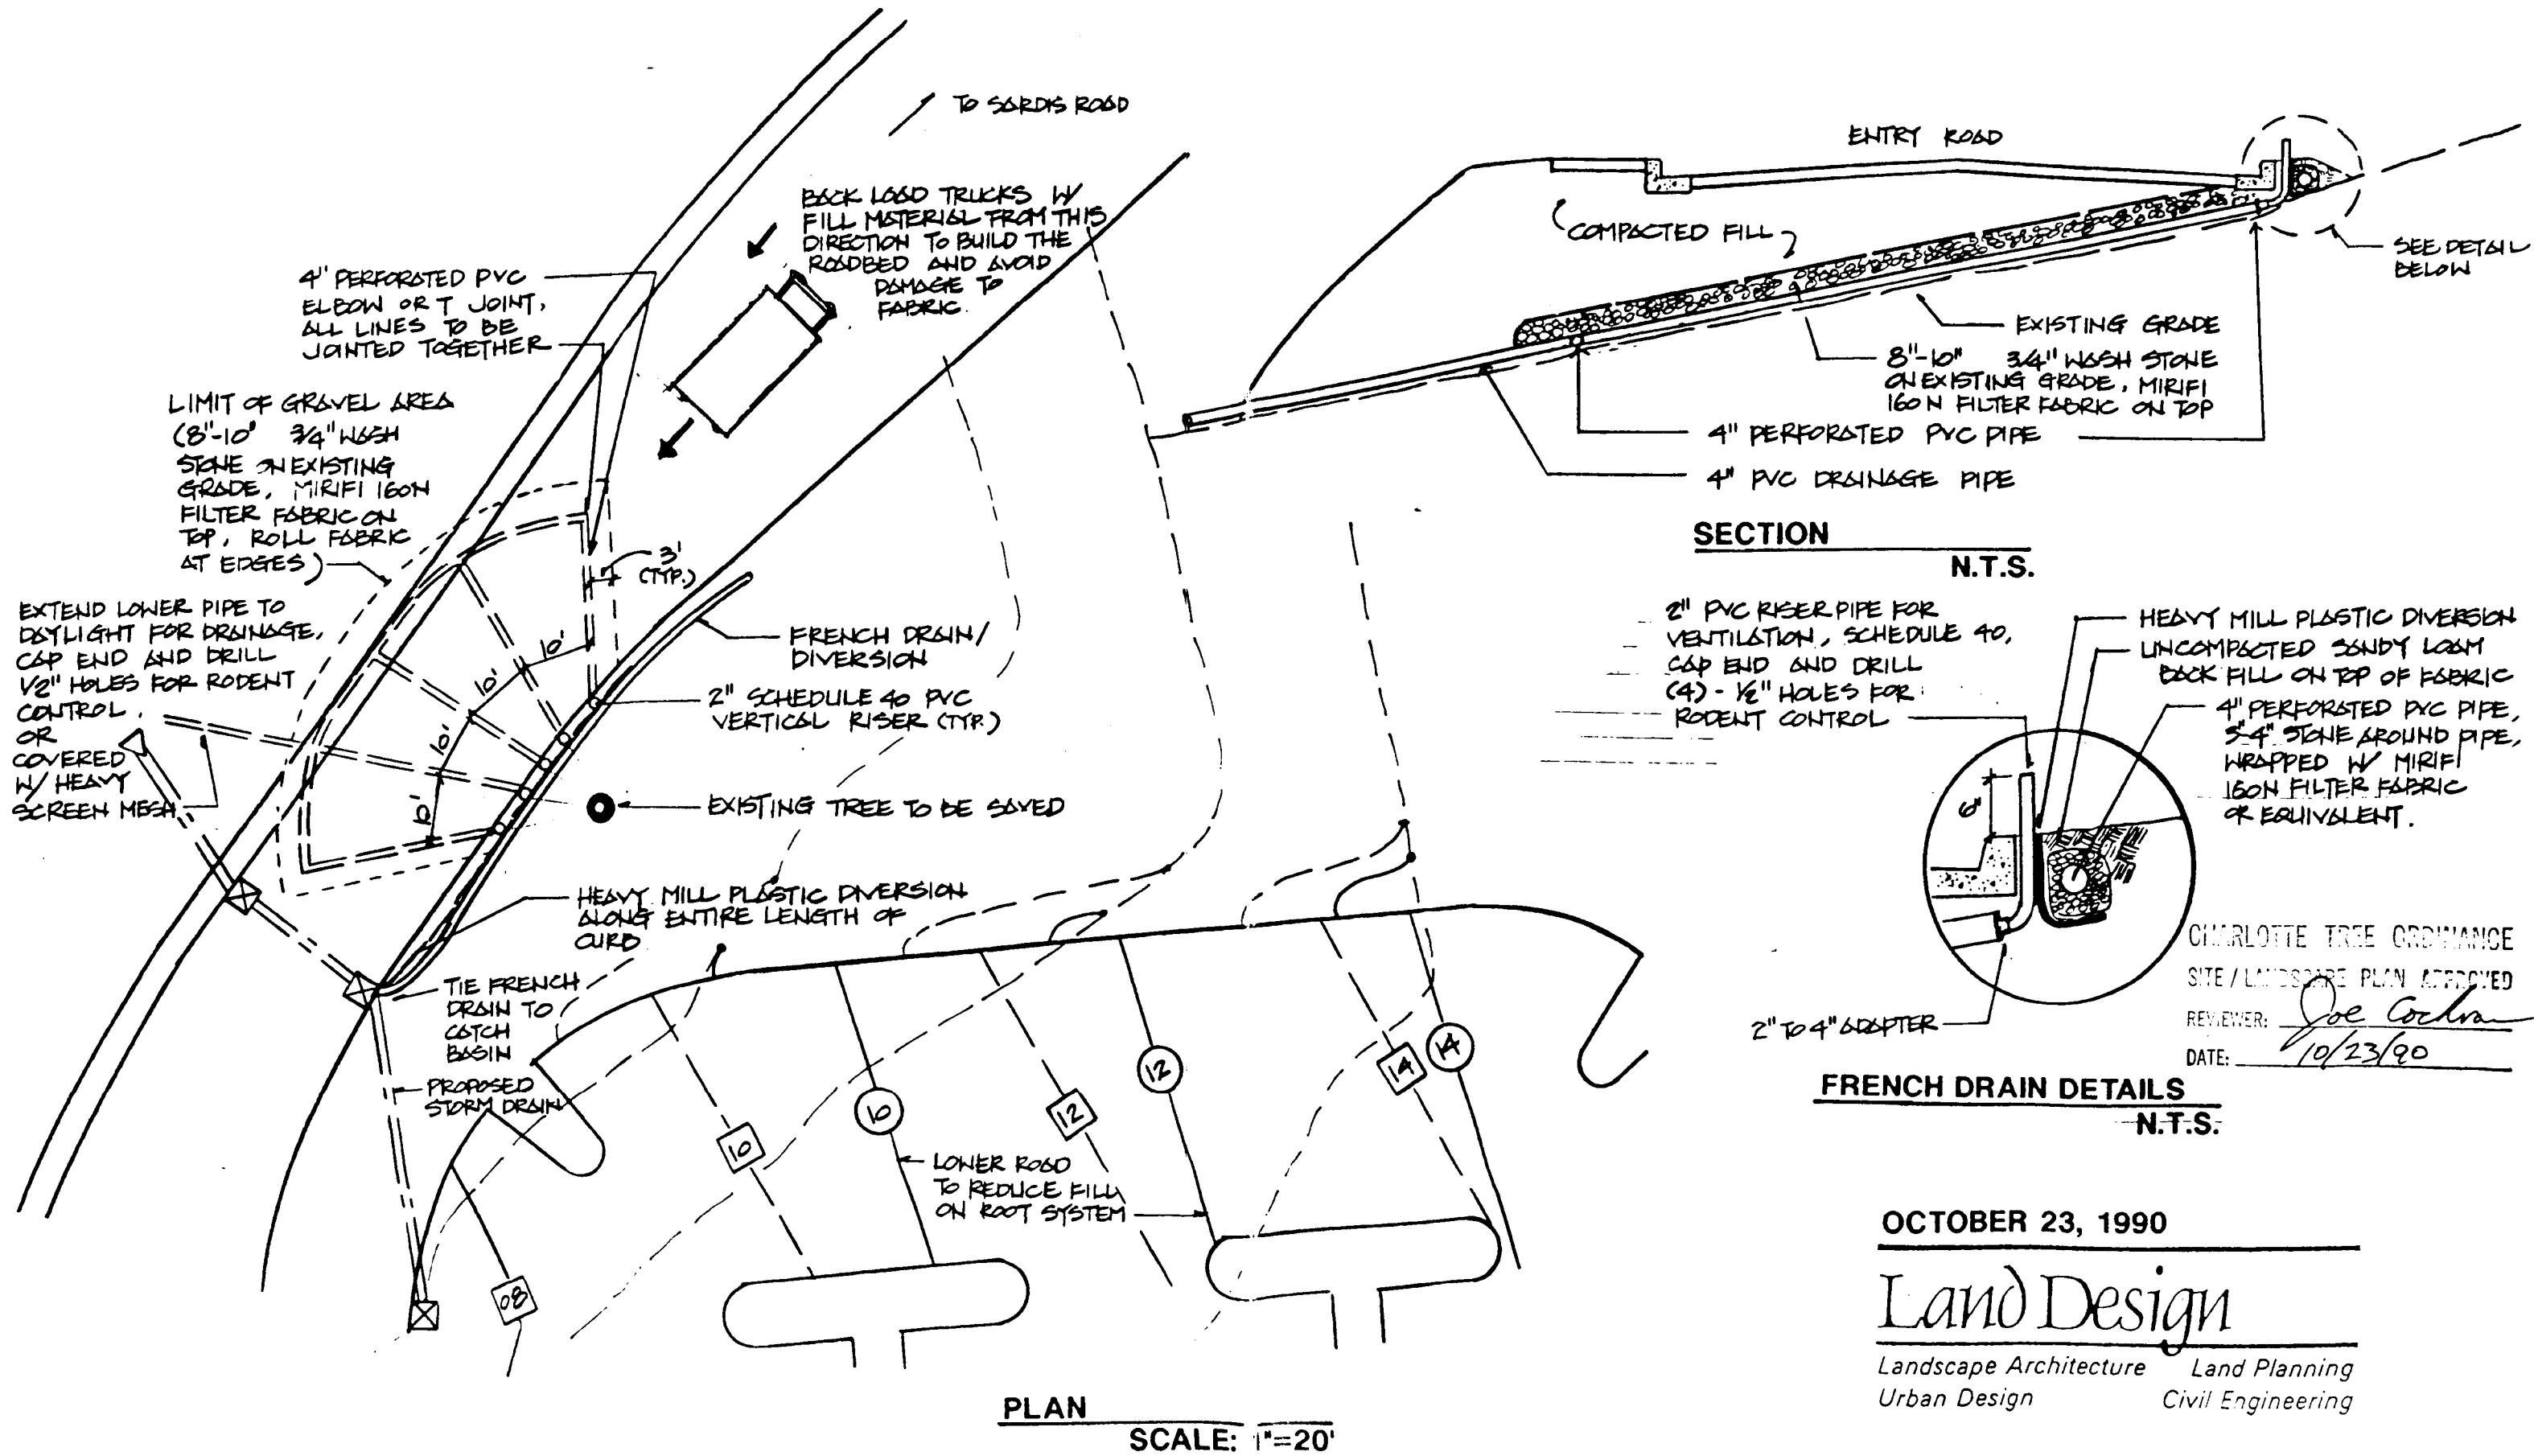

**STRAWBERRY HILL  
CENTER**

MARSH REALTY COMPANY  
P.O. BOX 35329 CHARLOTTE, NC 28217

NOTE: SHADeD AREAS REPRESENT  
AREAS TO BE IRRIGATED.  
IRRIGATION CONTRACTOR TO  
PROVIDE IRRIGATION SHOP  
DRAWINGS FOR REVIEW BY  
LANDSCAPE ARCHITECT.



**PLANTING PLAN**

SCALE 1=20' NORTH  
*attached to administrative approval dated 06/10/91 by Martin P. Brandon*  
DATE: APRIL 30, 1990  
PROJECT NO: 90551  
REVISIONS:  
1. 5/13/90 KEPT FOR CITY OF CHARLOTTE REVIEW  
2. 5/16/90 REVISIONS  
3. 5/16/90 PLANT COURTYARD  
4. 5/27/90 PER CITY REVIEW  
5. 6/1/90 PER CITY REVIEW  
6. 7/17/90  
7. 7/10/90 PER CITY REVIEW  
8. 10/20/90  
10. 11/27/90 APPROVED PLAN LAYOUT  
• 1701 East Boulevard, Charlotte, NC 28203 704/333-0355  
• 1216 Prince Street, Alexandria, VA 22314 703/549-7784  
• 225 Hillsborough Street, Raleigh, NC 919/834-6127

**Land Design**

Landscape Architecture Land Planning  
Urban Design Civil Engineering

RELEASED FOR CONSTRUCTION  
DATE: 11-27-90

SHEET NO. 12 OF 12

CHARLOTTE-MECKLENBURG  
PLANNING COMMISSION

INTER-OFFICE COMMUNICATION

DATE: June 11, 1991


TO: Robert Brandon  
Zoning Administrator

FROM: Martin P. Brandon, Jr.  
Planning Director

SUBJECT: Administrative Approval for Petition No. 88-34 by Strawberry Hill  
Associates - Tax Parcel No. 183-121-29, 17

Attached is a revised landscape plan for the Strawberry Hill Shopping Center. The plan has been revised to add a service area behind shops 1-4. This service area will not be accessible by vehicles. The service area will be screened from the adjoining apartments by a brick wall and landscaping as shown on the attached plan. Pursuant to the authority granted to me by the zoning ordinance I am administratively approving this plan. Please use this plan when evaluating requests for building permits.


MBCjr/KHN/cln  
Attachment

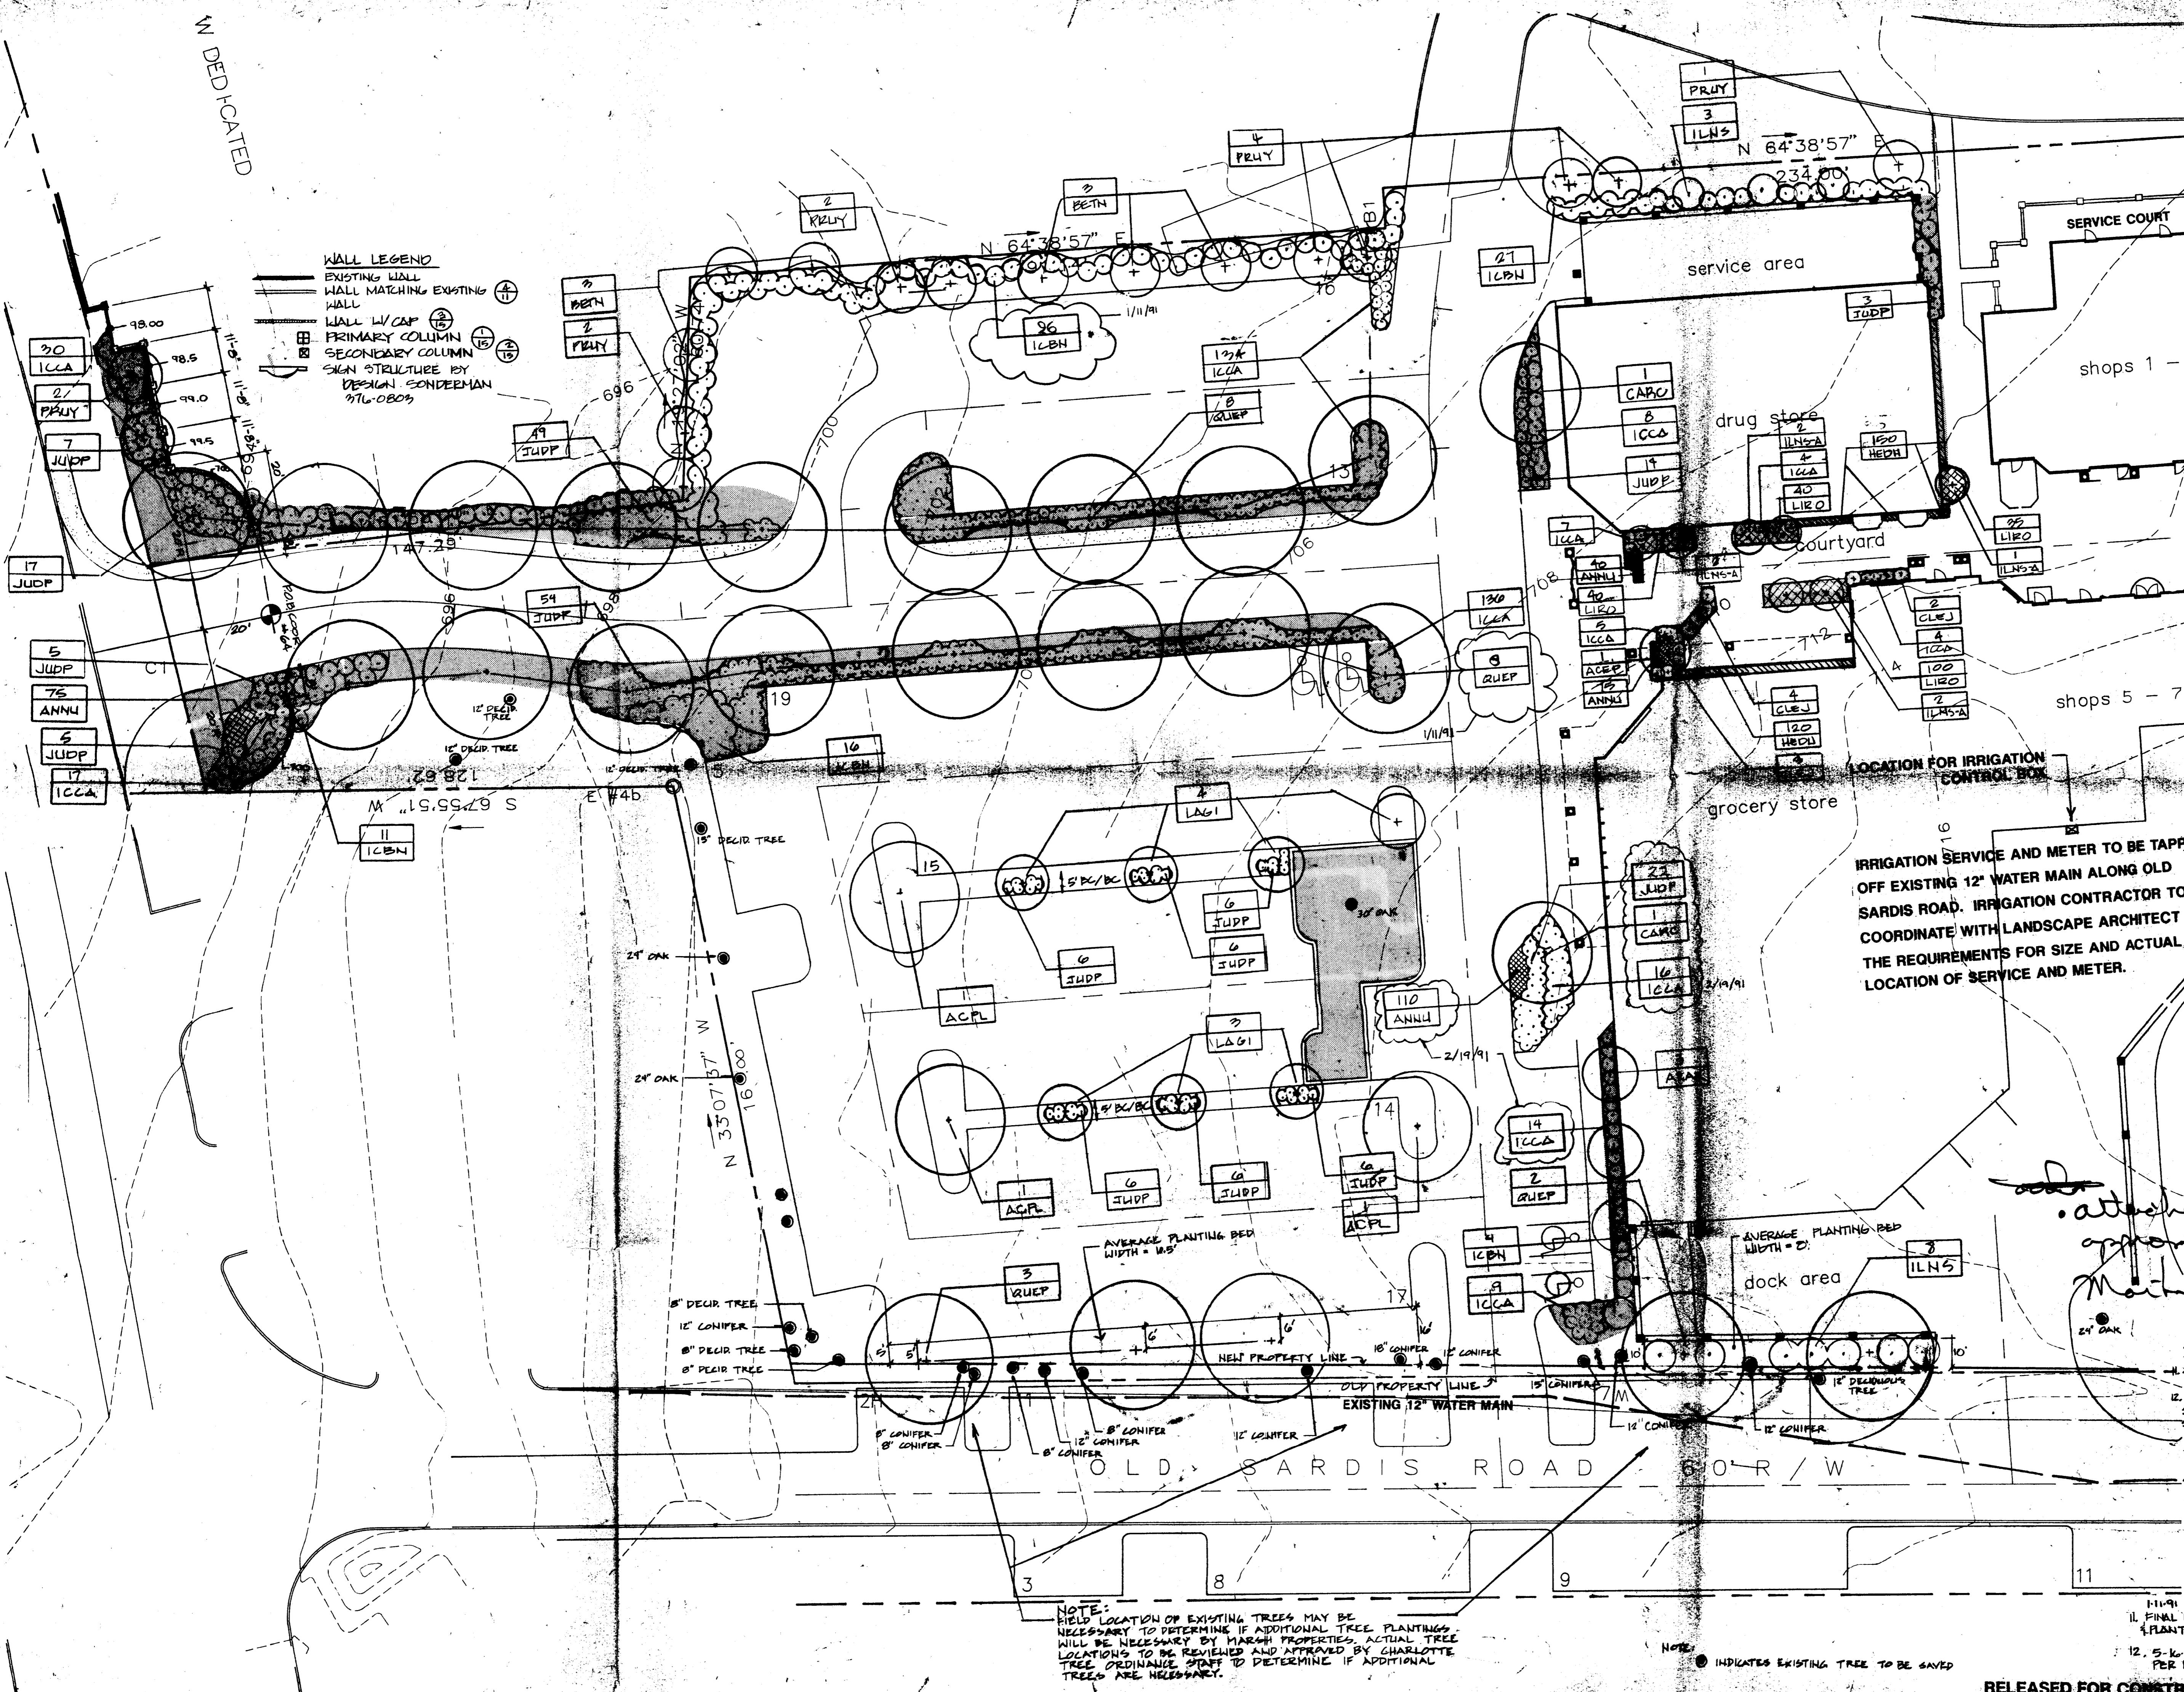

# STRAWBERRY HILL CENTER

MARSH REALTY COMPANY  
P.O. BOX 5329 CHARLOTTE, NC 28217

NOTE: SHADeD AREAS REPRESENT AREAS TO BE IRRIGATED.  
IRRIGATION CONTRACTOR TO PROVIDE IRRIGATION SHOP DRAWINGS FOR REVIEW BY LANDSCAPE ARCHITECT.

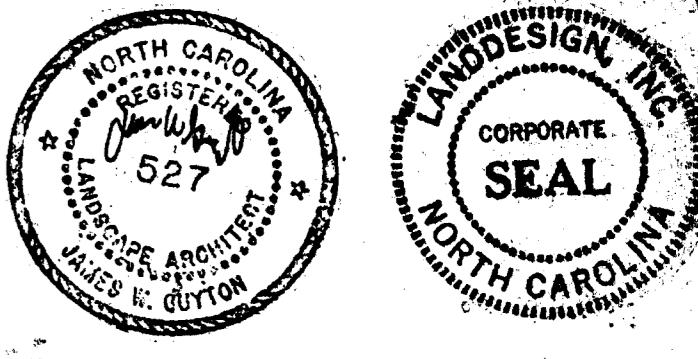

## PLANTING PLAN

SCALE 1"-20'-0"

NORTH

APRIL 30, 1990

PROJECT # 90551

REVISIONS:

1. 6/19/90 REVISED PER CITY OF CHARLOTTE REVIEW

2. 8/16/90 REVISIONS

3. 8/16/90 PLANT COURTYARD

+ 8/19/90 PER CITY REVISE

4. 7/17/90

5. 8/19/90 LAYOUT FOR WALL PROTECTION AND SCREENING

6. 8/20/90 LAYOUT FOR WALL PROTECTION AND SCREENING

7. 8/20/90 LAYOUT FOR WALL PROTECTION AND SCREENING

8. 8/20/90 REVISE PLANTING PER NEW WALL LAYOUT

9. 8/20/90 EXTEND WALL ALONG ENTER. ROAD

10. 8/21/90 PLANTING SERVICE COURT

11. 8/21/90 PLANTING 1-4

12. 8/21/90 PLANTING 5-7

13. 8/21/90 PLANTING 8-11

14. 8/21/90 PLANTING 12-14

15. 8/21/90 PLANTING 15-17

16. 8/21/90 PLANTING 18-20

17. 8/21/90 PLANTING 21-23

18. 8/21/90 PLANTING 24-26

19. 8/21/90 PLANTING 27-29

20. 8/21/90 PLANTING 30-32

21. 8/21/90 PLANTING 33-35

22. 8/21/90 PLANTING 36-38

23. 8/21/90 PLANTING 39-41

24. 8/21/90 PLANTING 42-44

25. 8/21/90 PLANTING 45-47

26. 8/21/90 PLANTING 48-50

27. 8/21/90 PLANTING 51-53

28. 8/21/90 PLANTING 54-56

29. 8/21/90 PLANTING 57-59

30. 8/21/90 PLANTING 60-62

31. 8/21/90 PLANTING 63-65

32. 8/21/90 PLANTING 66-68

33. 8/21/90 PLANTING 69-71

34. 8/21/90 PLANTING 72-74

35. 8/21/90 PLANTING 75-77

36. 8/21/90 PLANTING 78-80

37. 8/21/90 PLANTING 81-83

38. 8/21/90 PLANTING 84-86

39. 8/21/90 PLANTING 87-89

40. 8/21/90 PLANTING 90-92

41. 8/21/90 PLANTING 93-95

42. 8/21/90 PLANTING 96-98

43. 8/21/90 PLANTING 99-101

44. 8/21/90 PLANTING 102-104

45. 8/21/90 PLANTING 105-107

46. 8/21/90 PLANTING 108-110

47. 8/21/90 PLANTING 111-113

48. 8/21/90 PLANTING 114-116

49. 8/21/90 PLANTING 117-119

50. 8/21/90 PLANTING 120-122

51. 8/21/90 PLANTING 123-125

52. 8/21/90 PLANTING 126-128

53. 8/21/90 PLANTING 129-131

54. 8/21/90 PLANTING 132-134

55. 8/21/90 PLANTING 135-137

56. 8/21/90 PLANTING 138-140

57. 8/21/90 PLANTING 141-143

58. 8/21/90 PLANTING 144-146

59. 8/21/90 PLANTING 147-149

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61. 8/21/90 PLANTING 153-155

62. 8/21/90 PLANTING 156-158

63. 8/21/90 PLANTING 159-161

64. 8/21/90 PLANTING 162-164

128. 8/21/90 PLANTING 354-356

# STRAWBERRY HILL CENTER

MARSH REALTY COMPANY  
P.O. BOX 35329 CHARLOTTE, N.C. 28217

REZONED AS THE VILLAGE AT STRAWBERRY HILL  
ZONING PETITION # 88-34

## SITE TABULATIONS

TOTAL SITE AREA: 6.2 ACRES

CURRENT ZONING: B1-CD

BUILDING SQ. FT.: 38,800

## PARKING TABULATION

Occupancy	Grocery	Drug Store, Shops	Mercantile	23,447SF/200 = 117
Restaurant			Assembly	150 Persons/3 = 50
Bank			Business	2481SF/100 = 25

Employees	Grocery	15
Restaurant	10	
Shops	20	
Total	45/2	= 23

Park & Ride		= 62
Total Parking Required		277

Total parking Provided (6 Handicap Spaces) 277

LANDSCAPE AREA ACREAGE: 18,900 S.F.  
(PER TREE ORDINANCE REQUIREMENTS)

## SCHEDULE OF DRAWINGS

### SITE PLANNING DRAWINGS

L 1. TITLE SHEET

L 2. EXISTING CONDITIONS

L 3. SITE PLAN

L 3A. DRAINAGE AREA MAP

L 4. CLEARING & TREE PROTECTION PLAN

L 5. STAKING PLAN

L 6. SEDIMENTATION & EROSION CONTROL PLAN


L 7. PROVIDENCE ROAD IMPROVEMENTS

L 8. SITE DETAILS

L 9. SITE DETAILS

L 10. SITE DETAILS

L 11. SITE DETAILS

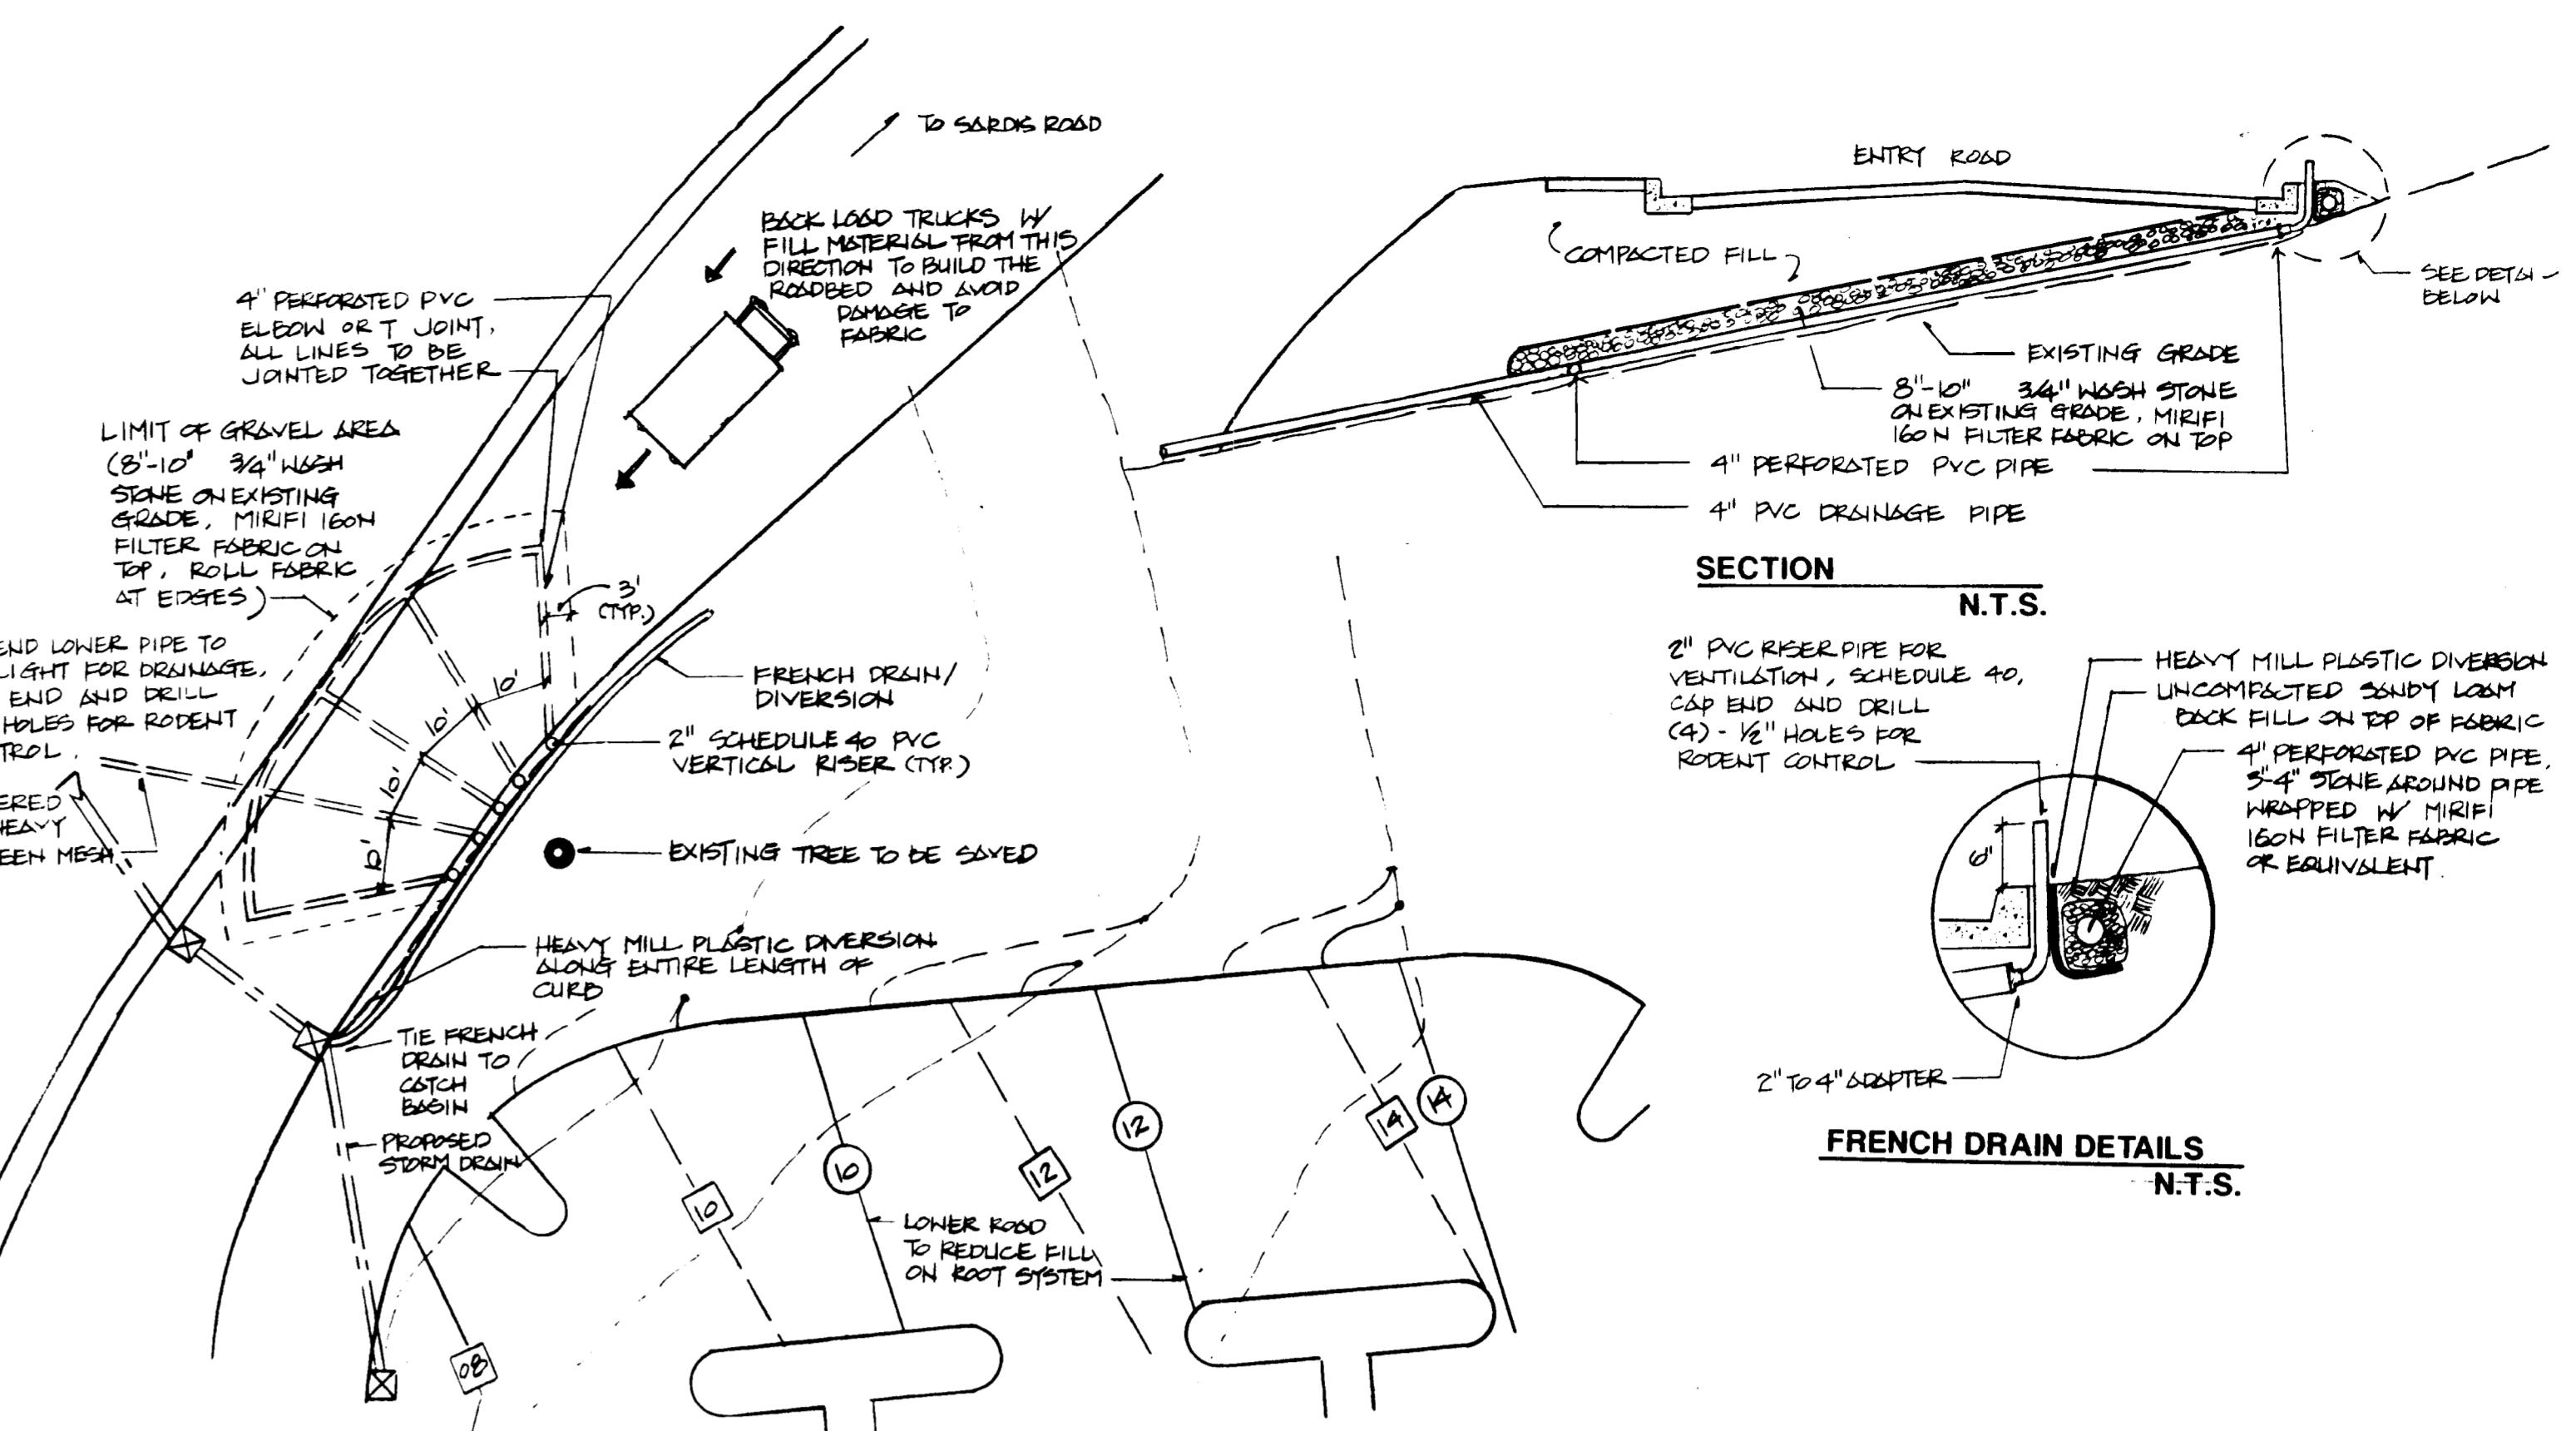


## STORM DRAINAGE DESIGN DATA

PROJECT: Strawberry Hill Center		COMPUTED BY: MSA	DATE: 4/3 1990						
LOCATION: Charlotte		CHECKED BY: JMG	SHEET 1 OF 1						
STORM FREQUENCY: 10 YEAR									
LOCATION	AREA	C	INTENSITY						
M	TO	HILL	I	CFS	N	SLOPE	BASE LEVEL	REMARKS	
TD 1	DI 1		0.13	.81		6.8	.72	.011.005 [106]	8" - 18" Schedule 40 PVC
DI 2	CB 5	.05	0.18	.95		6.8	1.04	.012.008 [48]	15" 3.2
DI 3	DI 4		0.02	.95		6.8	0.13	.012.008 [42]	15" 3.0
DI 4	CB 5	.62	0.64	.95		6.8	4.13	.012.026 [35]	15" 5.6
CB 5	CB 6	.29	1.11	.77		6.8	6.68	.012.01 [204]	15" 5.4
CB 6	CR 7	.59	1.69	.86		6.8	10.07	.012.028 [114]	15" 3.1
CB 7	CB 8	.52	2.21	.88		6.8	13.18	.012.018 [26]	15" 3.7
CB 8	CB 9	.79	3.0	.52		6.8	15.97	.012.024 [20]	15" 3.2
CR 9	FES 10	.29	3.29	.95		6.8	17.84	.012.01 [20]	24" 7.0
Det. Outlet						5.44	.021.00 [50]	15"	7.0
DI 11	CB 13	0.44	.95			6.8	2.84	.012.059 [220]	8" - 18" Schedule 40 PVC
CB 12	CB 13	.91	.88			6.8	5.45	.012.008 [70]	15" 4.8
CB 13	FES 14	.22	1.57	.90		6.8	9.64	.012.024 [12]	15" 8.2
Det. CB 15							2.14	.021.019 [162]	15" 3.6 DETENTION OUTLET
CB 15	MW 16							.021.010 [162]	15" 3.6
MW 16	Ext 17							.021.012 [162]	15" 5.5
Ext 17								.021.012 [162]	15" 8.7

## STORM DRAINAGE SCHEDULE

STRUCTURE	RIM	INV. IN	INV. OUT	LENGTH	SIZE	SLOPE
TD 1	708.51	-----	706.71	106'	8" PVC	0.5%
DI 2	711.80	706.18	705.98	48'	15" RCP	0.8%
DI 3	711.80	706.18	705.98	48'	15" RCP	0.8%
DI 4	711.80	706.31	708.11	36'	15" RCP	2.5%
CB 5	710.45	(DI 2)	705.60	-----	-----	-----
CB 6	709.90	703.36	703.36	204'	15" RCP	1.0%
CB 7	707.24	700.82	700.82	114'	15" RCP	2.3%
CB 8	706.27	699.40	699.40	24'	15" RCP	1.8%
CB 9	706.27	698.82	698.82	24'	24" RCP	2.4%
CB 10	-----	698.00	698.00	-----	-----	-----
Detention	-----	694.00	691.00	50'	12" CMP	0.0% MIN
Outlet	-----	-----	-----	-----	-----	-----
DI 11	712.18	-----	709.51	220'	8" PVC	5.9%
CB 12	699.80	-----	696.51	70'	15" RCP	0.8%
CB 13	699.20	(DI 11)	696.55	-----	-----	-----
FES 14	-----	693.00	695.95	12'	15" RCP	2.4%
Detention	-----	693.00	695.66	152'	15" CMP	1.5%
Outlet NW	CB 15	693.42	690.67	120'	15" RCP	1.1%
MW 16	692.20	688.15	688.15	18'	15" RCP	0.2%
Ex CB	691.70	688.75	688.75	-----	-----	-----

ALL STORM DRAINAGE PIPE TO BE CLASS III RCP EXCEPT AS NOTED  
ALL CMP TO BE FULLY ASPHALT COATED WITH PAVED INVERT

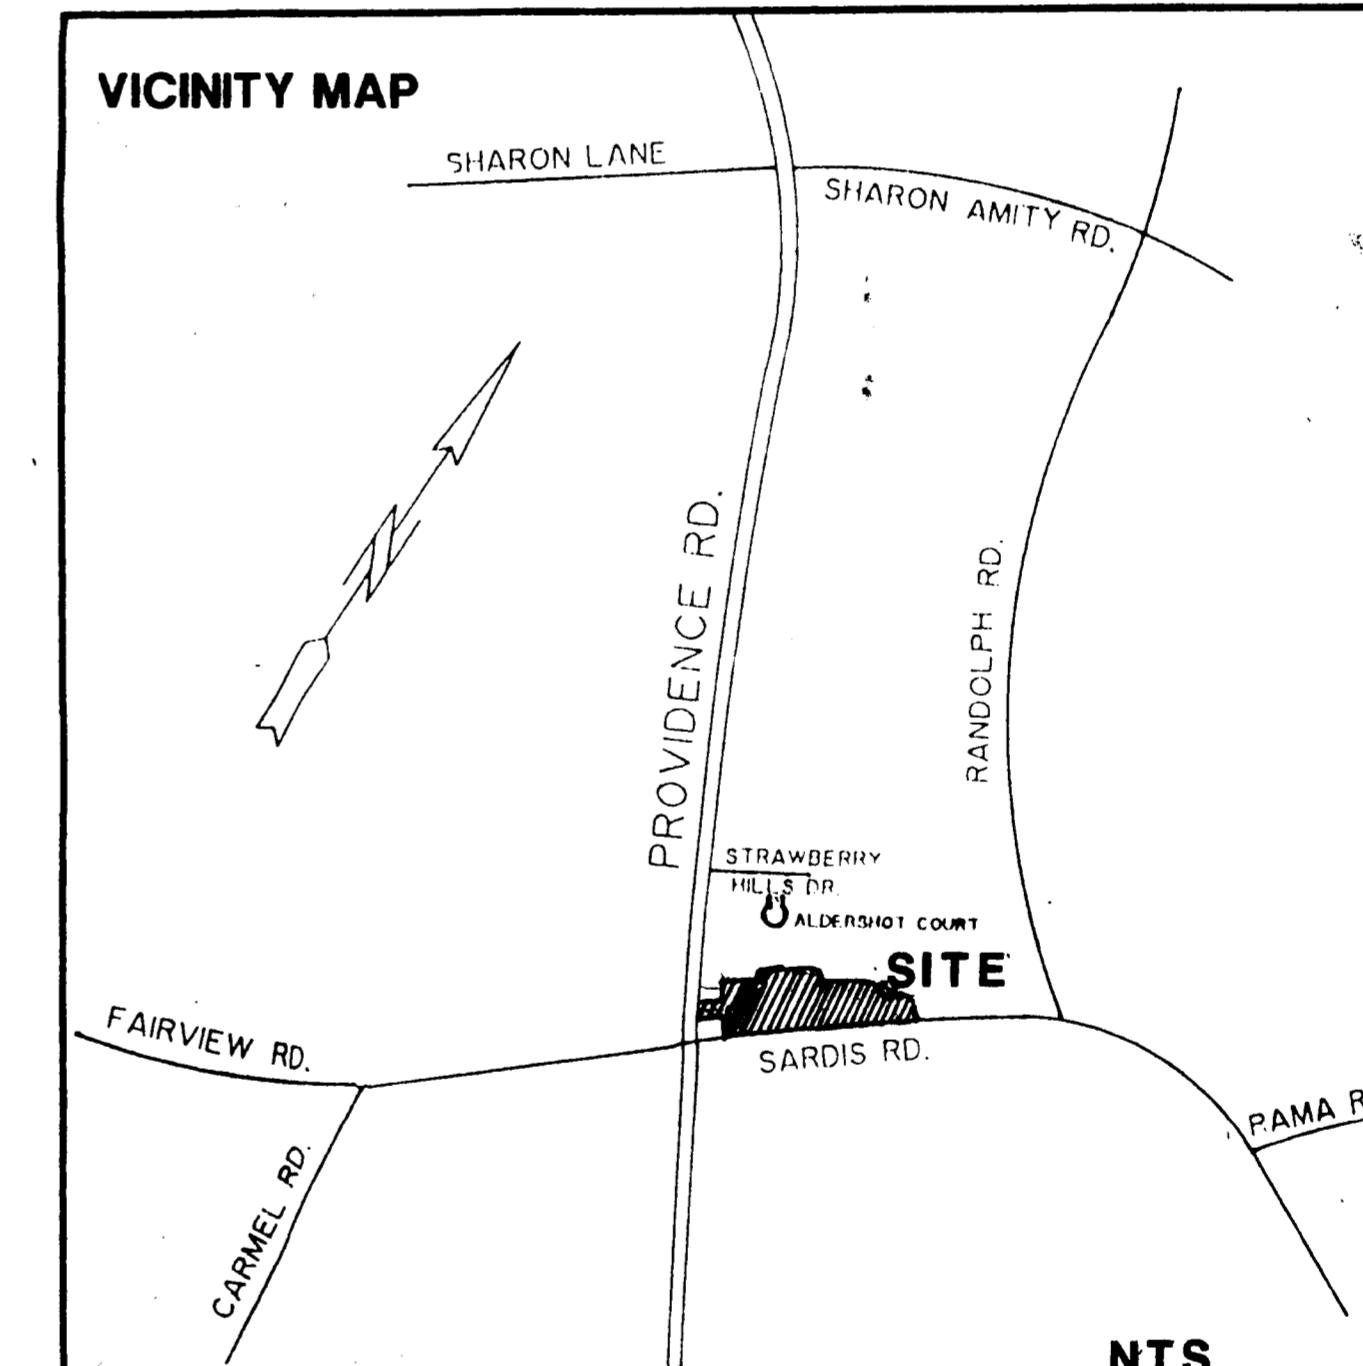

## COVER SHEET

DATE: APRIL 30, 1990

PROJECT NO: 90551

REVISIONS:  
1-5/3/90 REVISED PER CITY OF CHARLOTTE REVIEW  
2-5/10/90 SHOW EASING TAB  
3-5/10/90 PEL W/ KENWELL  
4-6/1/90 PER CITY REVIEW  
5-7/1/90 PER CITY REVIEW  
6-10/25/90 ADD AERATION DETAIL  
7-6/24/90 SITE L12 L13  
8-6/24/90 SITE L12 L13

Land Design

Landscape Architecture Land Planning  
Urban Design Civil Engineering

Sheet No: L 1

OF:

## MARLOTTE-MECKLENBURG PLANNING COMMISSION INTER-OFFICE COMMUNICATION

DATE: July 5, 1991  
TO: Robert Brandon,  
Zoning Administrator  
FROM: Martin K. Cramton, Jr.,  
Planning Director

SUBJECT: Administrative Approval for Petition No. 88-34 by Strawberry Hill Associates, Tax Parcel No. 185-121-29, 17


Attached is a revised landscape plan for the Strawberry Hill Center. The plan has been revised to show the final design and location of a break wall along Providence Road as well as along Sardis Road North. Pursuant to the authority granted to me by the zoning ordinance, I am administratively approving this plan. Please use this plan when evaluating requests for building permits and certificate of occupancy.

MRCJr.:KRM:dmh  
Attachment

# STRAWBERRY HILL CENTER

MARSH REALTY COMPANY  
P.O. BOX 3529 CHARLOTTE, NC 28217

NOTE: SHADeD AREAS REPRESENT AREAS TO BE IRRIGATED.  
IRRIGATION CONTRACTOR TO PROVIDE IRRIGATION SHOP DRAWINGS FOR REVIEW BY LANDSCAPE ARCHITECT.

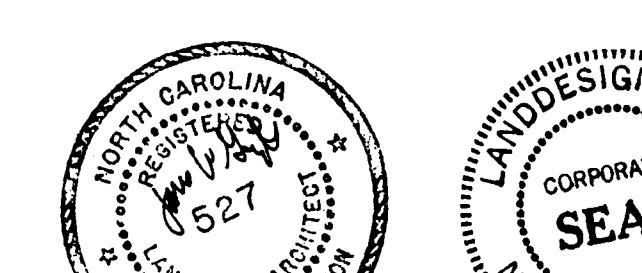

## PLANTING PLAN

SCALE 1"-20'  
NORTH

April 30, 1990

Project No. 90551

1. 5/1/90 REVISED PER CITY OF CHARLOTTE REVIEW
2. 5/10/90 REVISIONS
3. 5/18/90 PLANT COURTYARD
4. 5/23/90 PER CITY REVIEW
5. 6/1/90 PER CITY REVIEW
6. 7/17/90
7. 7/10/90 PER CITY REVIEW
8. 7/14/90
9. 7/17/90
10. 7/24/90 APPROVED WALL LAYOUT

• 1216 Prince Street Alexandria, VA 22314 703/549-2784

• 225 Hibernation Street, Highgate, NC 27048 919/662-2727

## Land Design

Landscape Architecture Land Planning Urban Design Civil Engineering

11-1-91

II. FINAL WALL LAYOUT, GRADING & PLANTING FROM RD.

12. 5/16/91 REVISE PLANTING PER NEW WALL LAYOUT.

Sheet No. L12


RELEASED FOR CONSTRUCTION

Date: 11-17-90

# STRAWBERRY HILL CENTER

MARSH REALTY COMPANY  
P.O. BOX 3529 CHARLOTTE, NC 28217

NOTE: SHADeD AREAS REPRESENT AREAS TO BE IRRIGATED.  
IRRIGATION CONTRACTOR TO PROVIDE IRRIGATION SHOP DRAWINGS FOR REVIEW BY LANDSCAPE ARCHITECT.

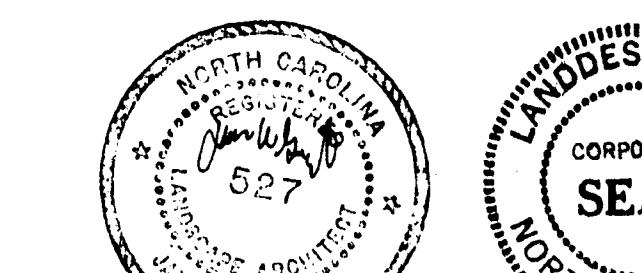

## PLANTING PLAN

SCALE 1"-20'  
NORTH

April 30, 1990

Project No. 90551

1. 5/1/90 REVISED PER CITY OF CHARLOTTE REVIEW
2. 5/10/90 REVISIONS
3. 5/18/90 PLANT COURTYARD
4. 5/23/90 PER CITY REVIEW
5. 6/1/90
6. 7/17/90
7. 7/10/90
8. 7/14/90
9. 7/17/90
10. 7/24/90 APPROVED WALL LAYOUT

• 1216 Prince Street Alexandria, VA 22314 703/549-2784

• 225 Hibernation Street, Highgate, NC 27048 919/662-2727

## Land Design

Landscape Architecture Land Planning Urban Design Civil Engineering

11-1-91

II. FINAL WALL LAYOUT, GRADING & PLANTING FROM RD.

12. 5/16/91 REVISE PLANTING PER NEW WALL LAYOUT.

Sheet No. L13

RELEASED FOR CONSTRUCTION

Date: 11-27-90

# STRAWBERRY HILL CENTER

MARSH REALTY COMPANY  
P.O. BOX 35329 CHARLOTTE, NC 28217



## PLANT SCHEDULE

SYMBOL	QTY.	SCIENTIFIC NAME COMMON NAME	CAL.	HGT.	COND.	NOTES
1.	3	Celtis occidentalis Hackberry	3 1/2"-4"	B&B		
1a.	2		4 1/2"-5"			
2.	1	Carya spp. Hickory	3 1/2"-4"	B&B		
2a.	2		4 1/2"-5"			
3.	2	Quercus rubra Red Oak	3 1/2"-4"	B&B		
3a.	2		4 1/2"-5"			
4.	1	Quercus alba White Oak	3 1/2"-4"	B&B		
4a.	1		4 1/2"-5"			
5.	27	Myrica cerifera Wax Myrtle	6-7'	B&B		
6.	1	Cupressaceae Eastern Redcedar	16'-18'	B&B	Field Grown Locally	
7.	6	Pinus virginiana Virginia Pine	8-10'	B&B		

General Notes:

1. Buffer area to be mulched with 4" of pine needle mulch.

## 1 PLANTING PLAN, SCHEDULE & NOTES @ DISTURBED BUFFER AREA

14 SCALE: 1"=20'

## CONSTRUCTION SEQUENCE CONTACT SCHEDULE

- The Planning Commission staff, the Urban Forestry staff, and the Zoning Administrators office must be contacted before and during the following construction events.
  - Before trenching begins at base of Hackberry and post oak. Areas beyond trench to be clearly marked and tree protection devices installed. Before and during this operation.
  - Before and during retaining wall construction.
  - Before arborist begins work and once work is completed. It should be understood that no canopy reduction is to occur for either root loss mitigation or aesthetic reasons. Only structural pruning should occur.
  - After topsoil is redistributed.
  - Before, during, and after new trees are planted.
- Please contact Keith MacLean, Planning 336-2205; Joe Corcoran, Urban Forestry 336-4254; and Sherry Williamson, Zoning 336-3571.

## PLANT SCHEDULE

SYMBOL	QTY.	SCIENTIFIC NAME COMMON NAME	CAL.	HGT.	SPD.	COND.	NOTES
<b>TREES</b>							
ACEP	3	Acer palmatum 'Bloodgood'		6'-8"		B&B	Specimen Tree
ACPL	7	Acer platanoides Norway Maple		2"-2 1/2"		B&B	
ARAR	3	Acer rubrum 'Armstrong' Armstrong Red Maple		1 1/2"-2"		B&B	Columnar Specimen
BETN	6	Betula nigra River Birch		1 1/4"-1 1/2"	6'-8"	B&B	
CARC	7	Carpinus caroliniana American Hornbeam			10'-12'	B&B	Specimen Tree
IIHS	19	Ilex x 'Nellie Stevens' Nellie Stevens Holly		1 1/4" Min.	9"-11"	B&B	Tree Form
LAGI	19	Lagerstroemia indica Crape Myrtle			6'-7"	B&B	Multi-Stem, Lavendar Flowering, Tree Form
PRUY	12	Prunus yedoensis Yoshino Cherry		1 1/2"-2"		B&B	
QUEP	45	Quercus Phellos Willow Oak		2 1/2"-3"		B&B	
TLNDRA	7	Ilex x 'Nellie Stevens' Nellie Stevens Holly			7'-8'	B&B	Tree Form
<b>SHRUBS</b>							
ICBN	277	Ilex cornuta 'Burfordi Nana' Dwarf Burford Holly		36"	30"-36"	5 Gal.	5" o.c.
ICCA	4...	Ilex cornuta 'Carrissa' Carrissa Holly		18"-24"	18"-24"	2 Gal.	3" o.c.
ILWE		Ilex vomitoria 'Chilling'			15"-18"	2 Gal.	
JUDP	344	Juniperus davurica 'Parsonii' Parson's Juniper		18"-24"	2 Gal.	3" o.c.	
CLEJ	26	Cleome gynandra Cleome		18"-24"		3 Gal.	
<b>GROUND COVER</b>							
ANNU	555	Annuals - Seasonal Color				4" Pot	8" o.c.
HEDM	1290	Hedera helix English Ivy				4" Pot	8-12" o.c.
LIRP	345	Liriope muscari Liriope				1 Gal.	12" o.c.
<b>GENERAL NOTES</b>							
1.	Contractor is responsible for verifying all quantities.						
2.	Mulch all plant beds with 4" of Pine Needle mulch.						
3.	Apply pre-emergent herbicide to planting beds prior to mulching.						
4.	Seed all disturbed areas on project site except planting beds with Pescue mix.						
5.	Plant material may not be substituted without approval of Landscape Architect or Architect.						

## CONDITIONAL NOTES


### I. Existing Trees (Hackberry & Large White Oak)

- A watering program was initiated Monday, July 1, 1990 as described in the memo from the tree ordinance dept. dated July 1, 1990. This watering program will continue throughout the duration of construction.
- The undisturbed area for the existing trees will be increased by modifying the road and parking layout as indicated on the proposed site plan.
- Prior to the start of construction, a tree barrier equal to the drip line plus 10' will be constructed around these trees and no construction equipment other than a backhoe or total excavator on proposed layout plan and attached detail shall be allowed within this area. Rough grading surrounding these trees, shall not be completed until the surrounding structural part of the retaining wall has been completed. The tree protection/retaining wall will be field located and constructed as described in detail. During construction of the walls PVC sleeves will be installed for future re-planting of irrigation lines to prevent future disturbance of the undisturbed area.
- No utility lines other than noted will be constructed within the undisturbed area defined by tree protection/retaining wall.
- Pruning arborist services will be obtained as soon as possible to initiate a tree fertilization and maintenance program. The arborist service shall submit the fertilizer and maintenance plan by June 25th for review and approval by the city tree ordinance staff. The program is to continue at a minimum of 12 months after construction completion.
- Manual tree fertilization program will be initiated with the administrative approval of the buffer replanting plan.

### II. Graded/Cleared Area at Sardis Road

- All large stumps preventing the spreading of top soil will be removed from the cleared area. A minimum of 8" of topsoil will evenly spread over the cleared area by a rubber tired tractor and box spreader. Only rubber tired equipment will be allowed in this area to minimize compaction.


- After top soil has been replaced the cleared area will be reseeded with a bermuda mixture for stabilization. Construction of the brick screen wall along Sardis Road will begin as soon as possible date after the issuance of building permits.
- The approved buffer replanting plan will be planted this fall (1990) during the acceptable planting season to avoid adverse effects on the proposed layout plan.
- The buffer areas will be mulched with 4" of pine needle mulch after planting is complete.
- Planting of trees shall meet with the Charlotte Tree ordinance staff for review and approval of buffer replanting specifications and methods before installation.

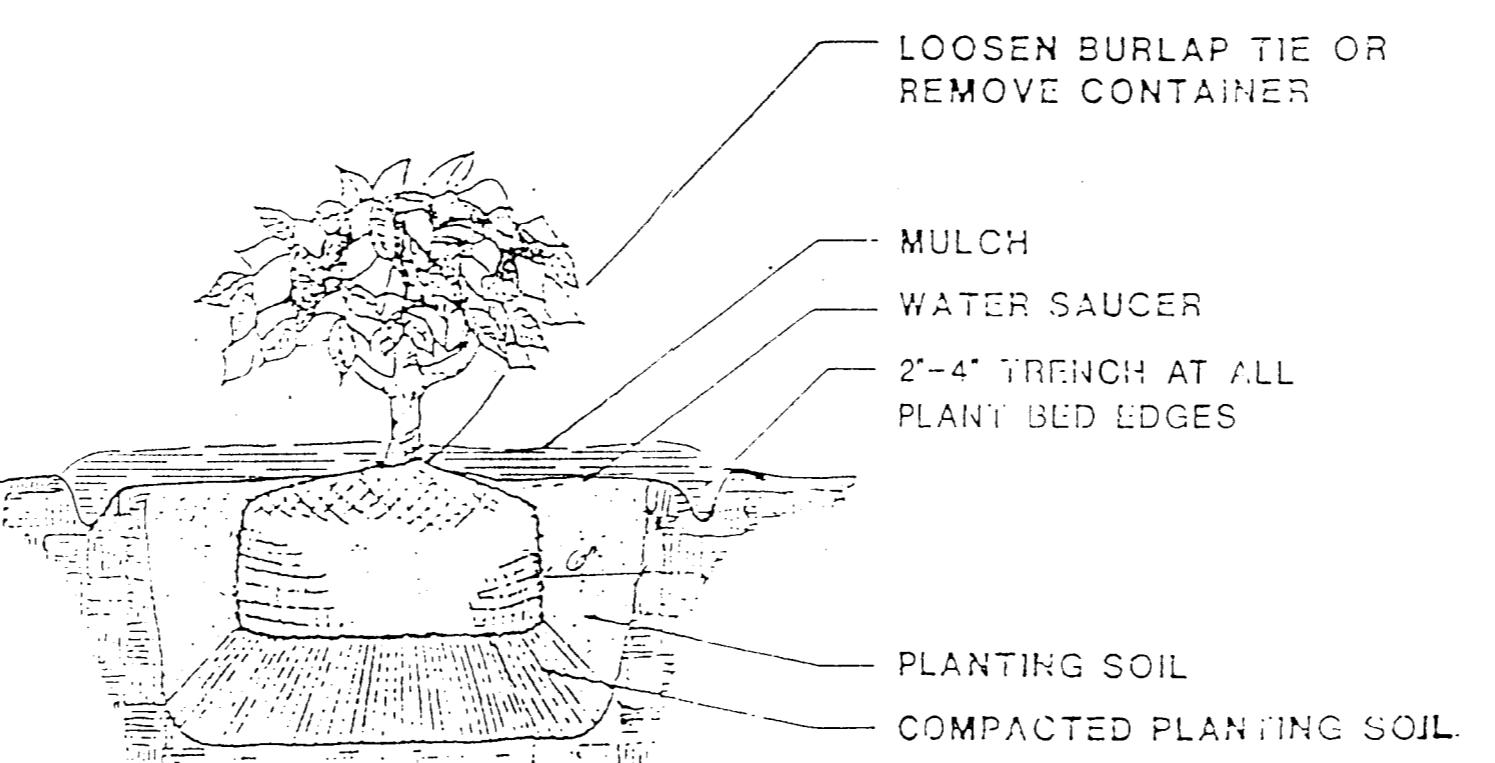

## 2 SHRUB PLANTING


14 NTS

## 3 TREE PLANTING

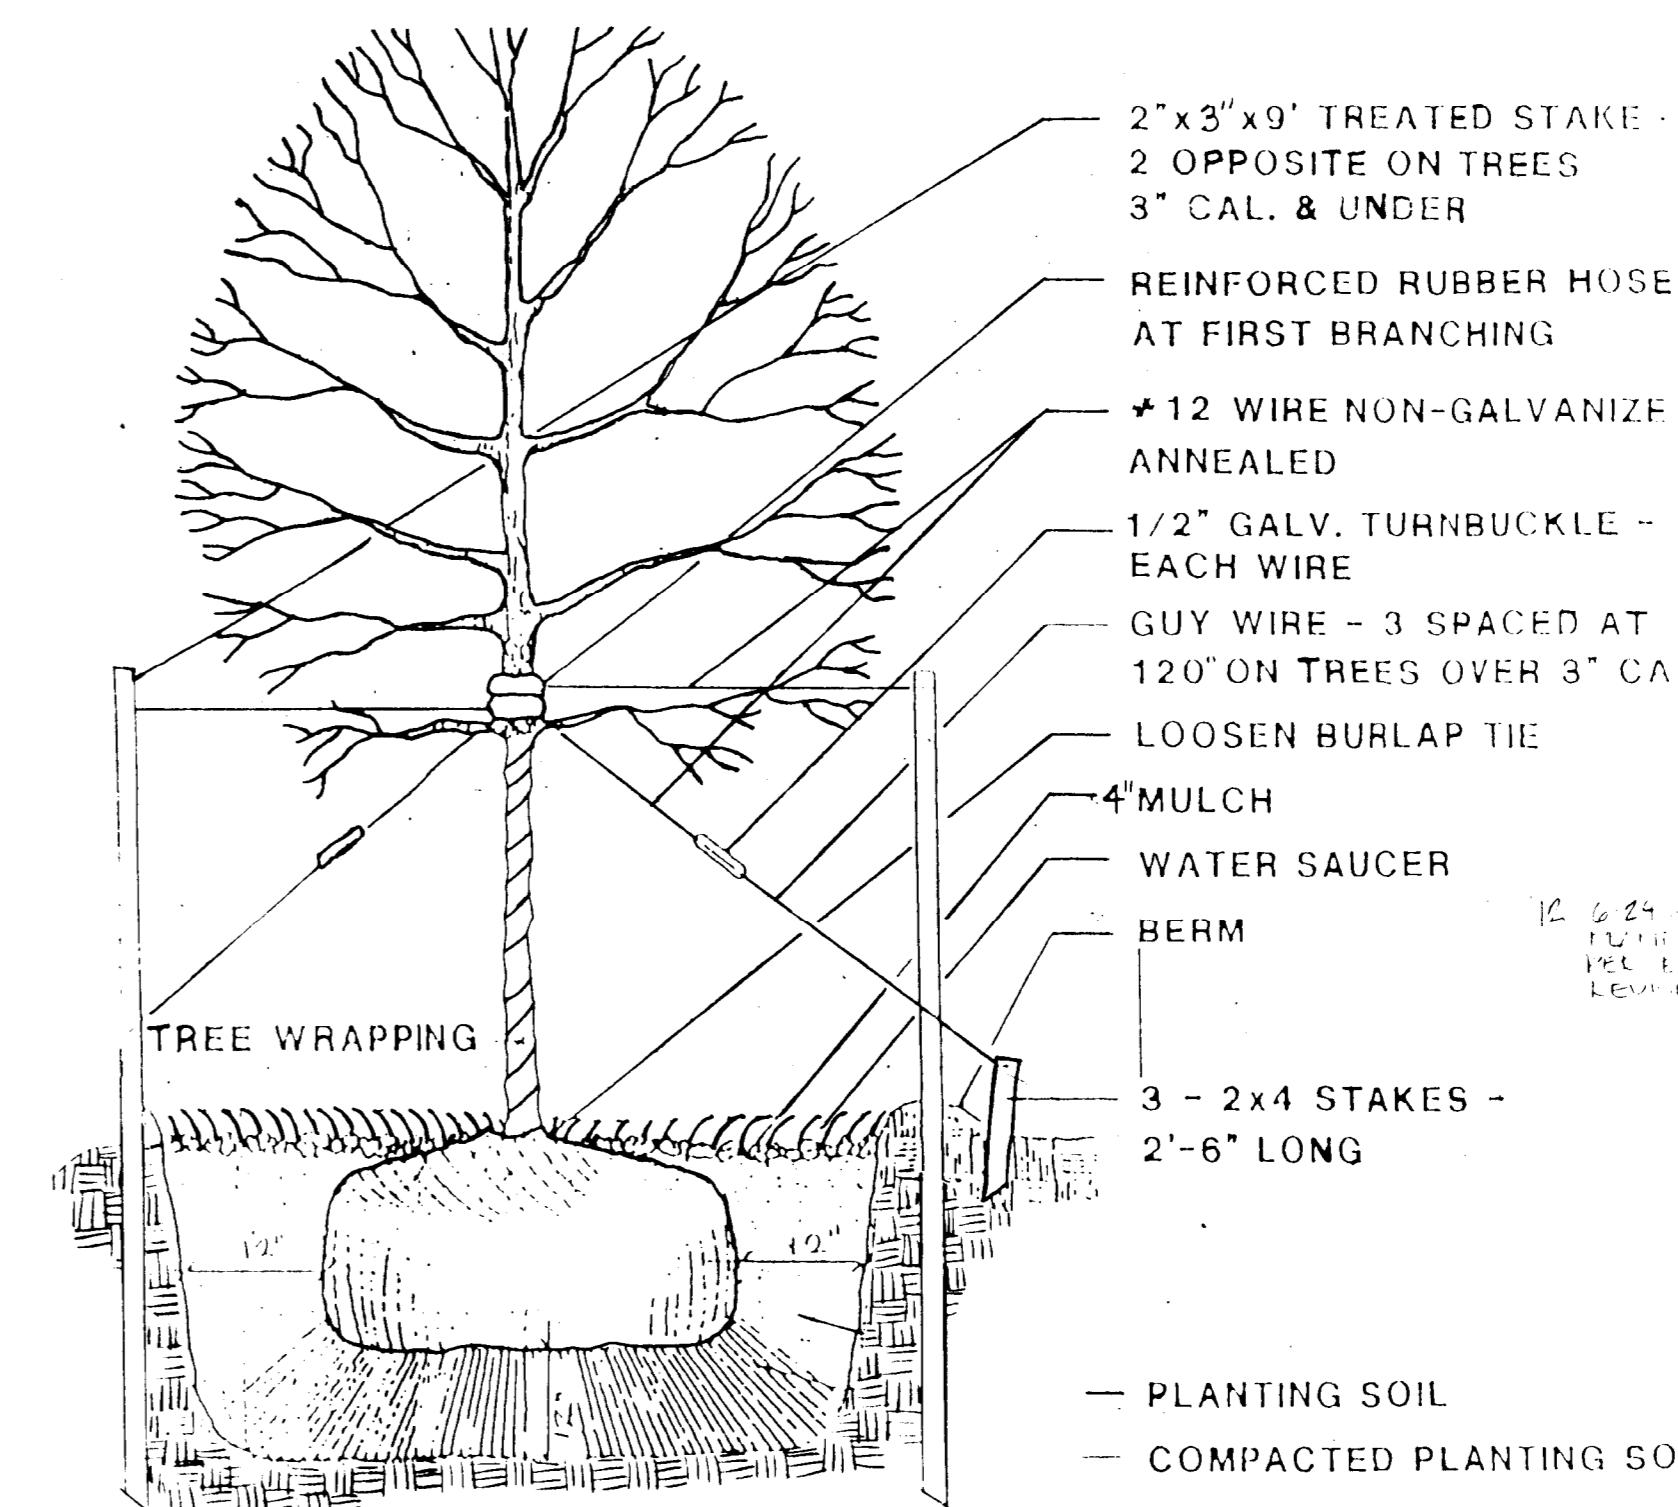

APRIL 30, 1990  
PROJECT NO. 90551  
REVISIONS:  
L 5/3/90 REvised Plan Unit  
OF CHARLOTTE KIZ UNIT  
2/16/90. NVILL UNIT QUIT.  
2/5/90 PLANT UNIT.  
2/5/90 PLANT UNIT.  
2/14/90 PLANT UNIT.  
7. 1/14 PLANT COUNT PER  
FINAL UNIT WALL LAYOUT  
8. 2/14 PLANT UNIT.

Land Design  
Landscape Architecture  
Urban Design  
Civil Engineering



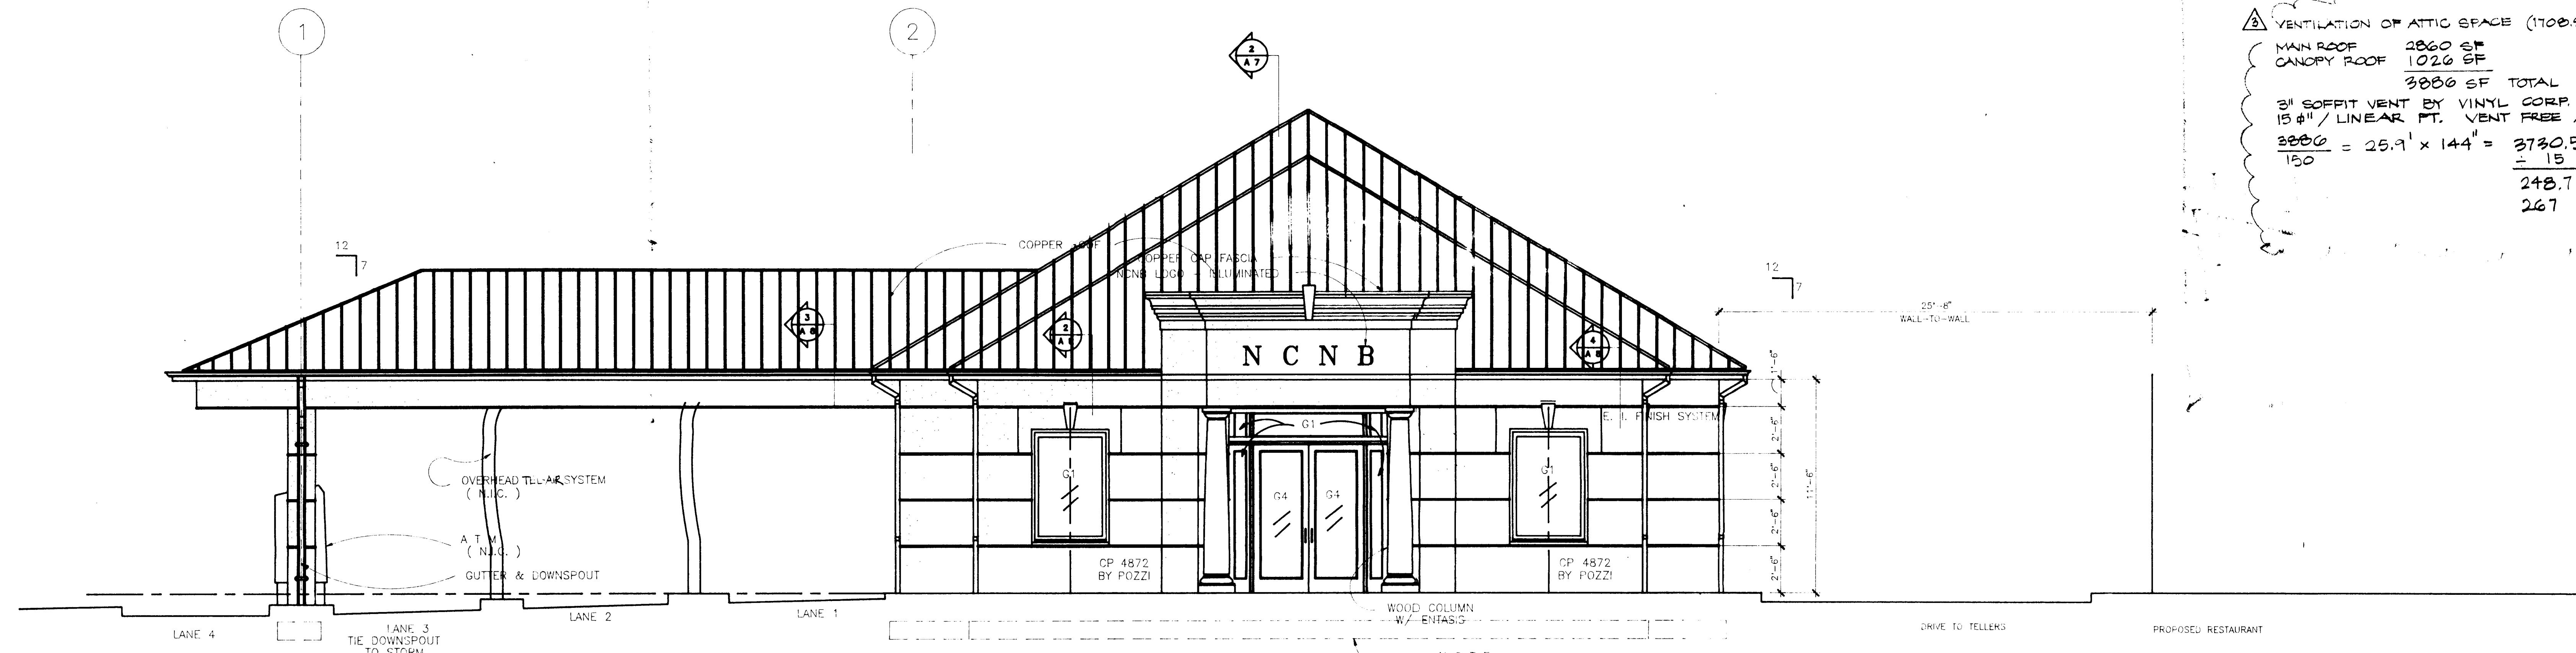


## FRONT ELEVATION

SCALE 1/4" = 1'-0"

NOTE: ALL WINDOWS TO BE CLAD

EXTERIOR FINISH COPPER ROOF  
AND WOOD WINDOWS TO COMPLEMENT  
THOSE USED ON STRAWBERRY HILL  
CENTER CHOPS AS REQUESTED IN  
CITY OF CHARLOTTE.

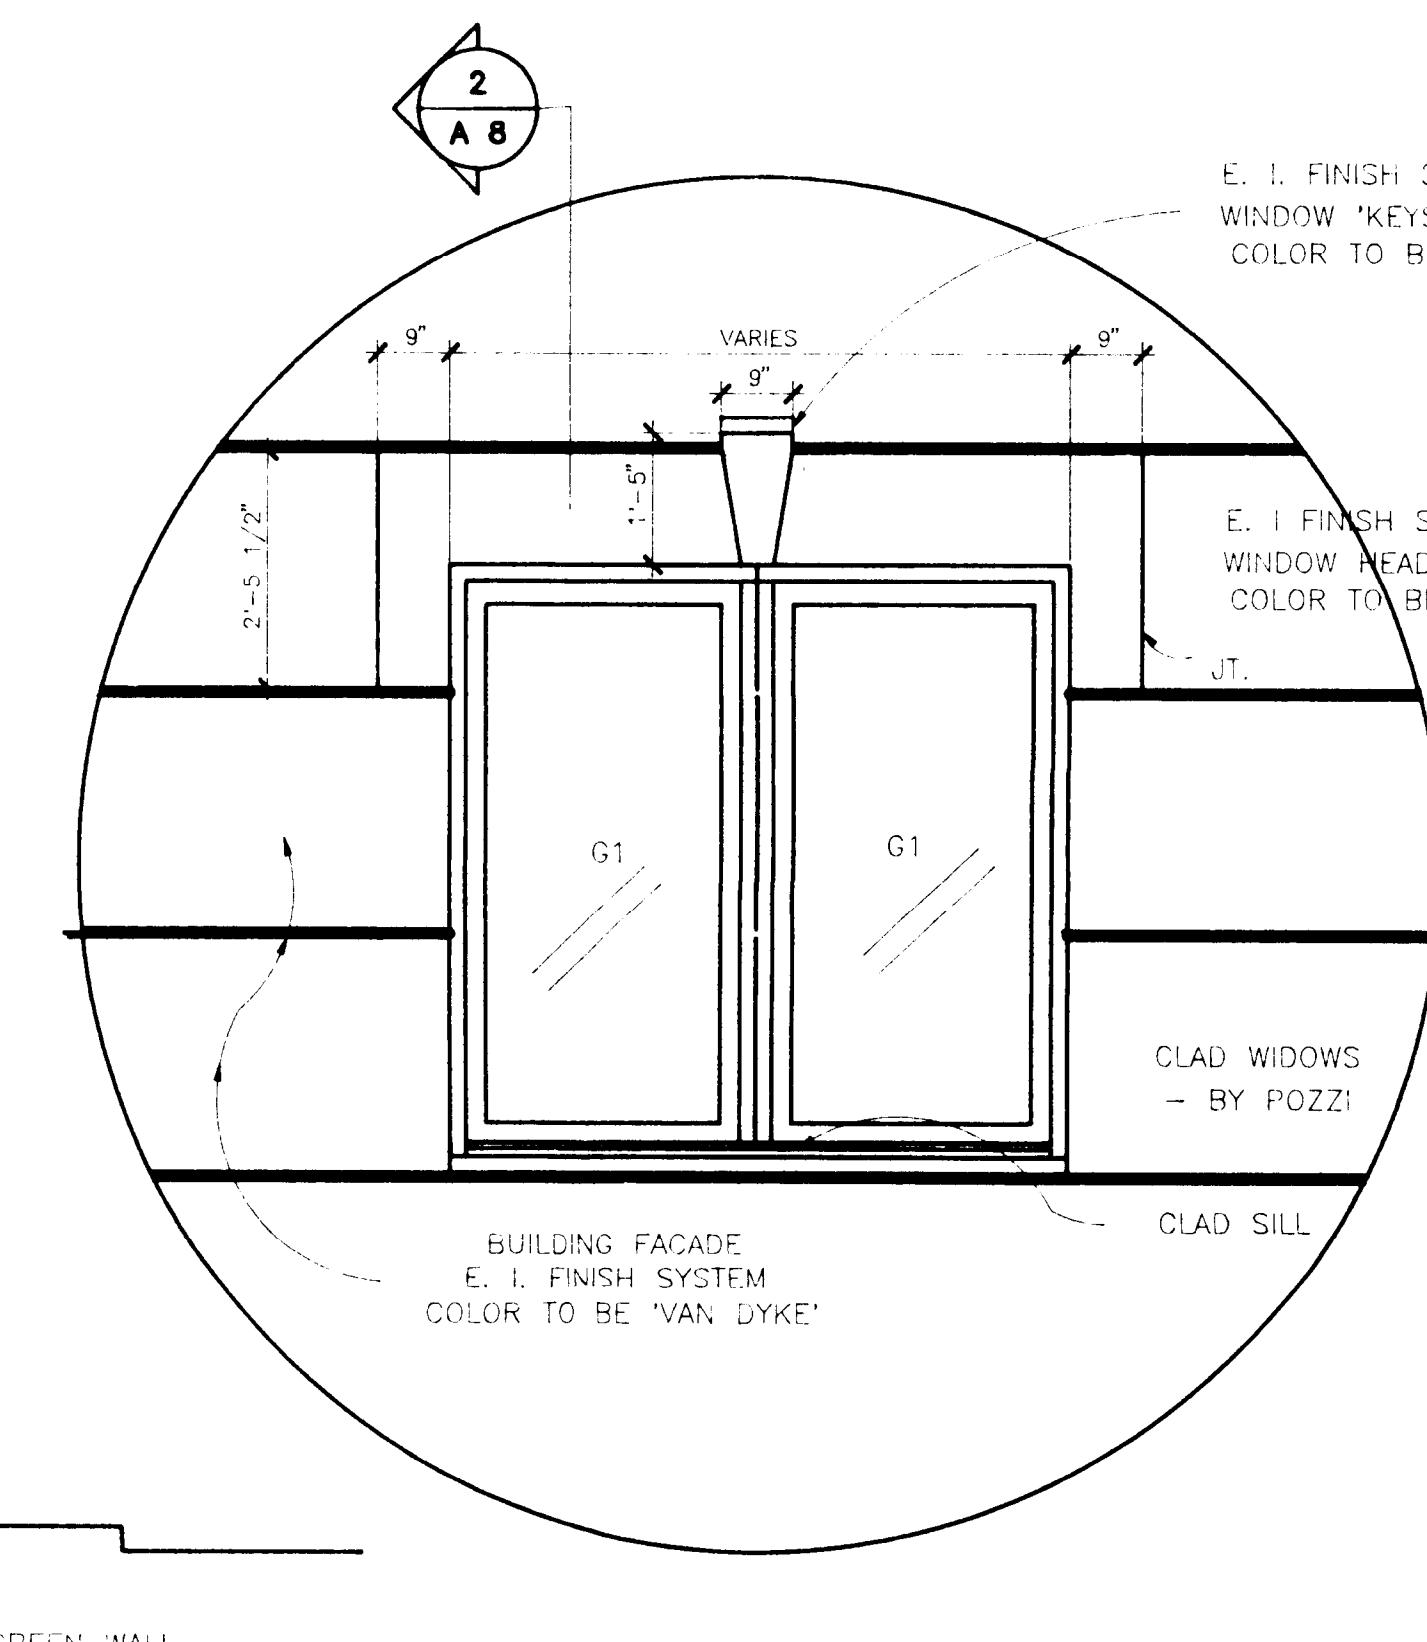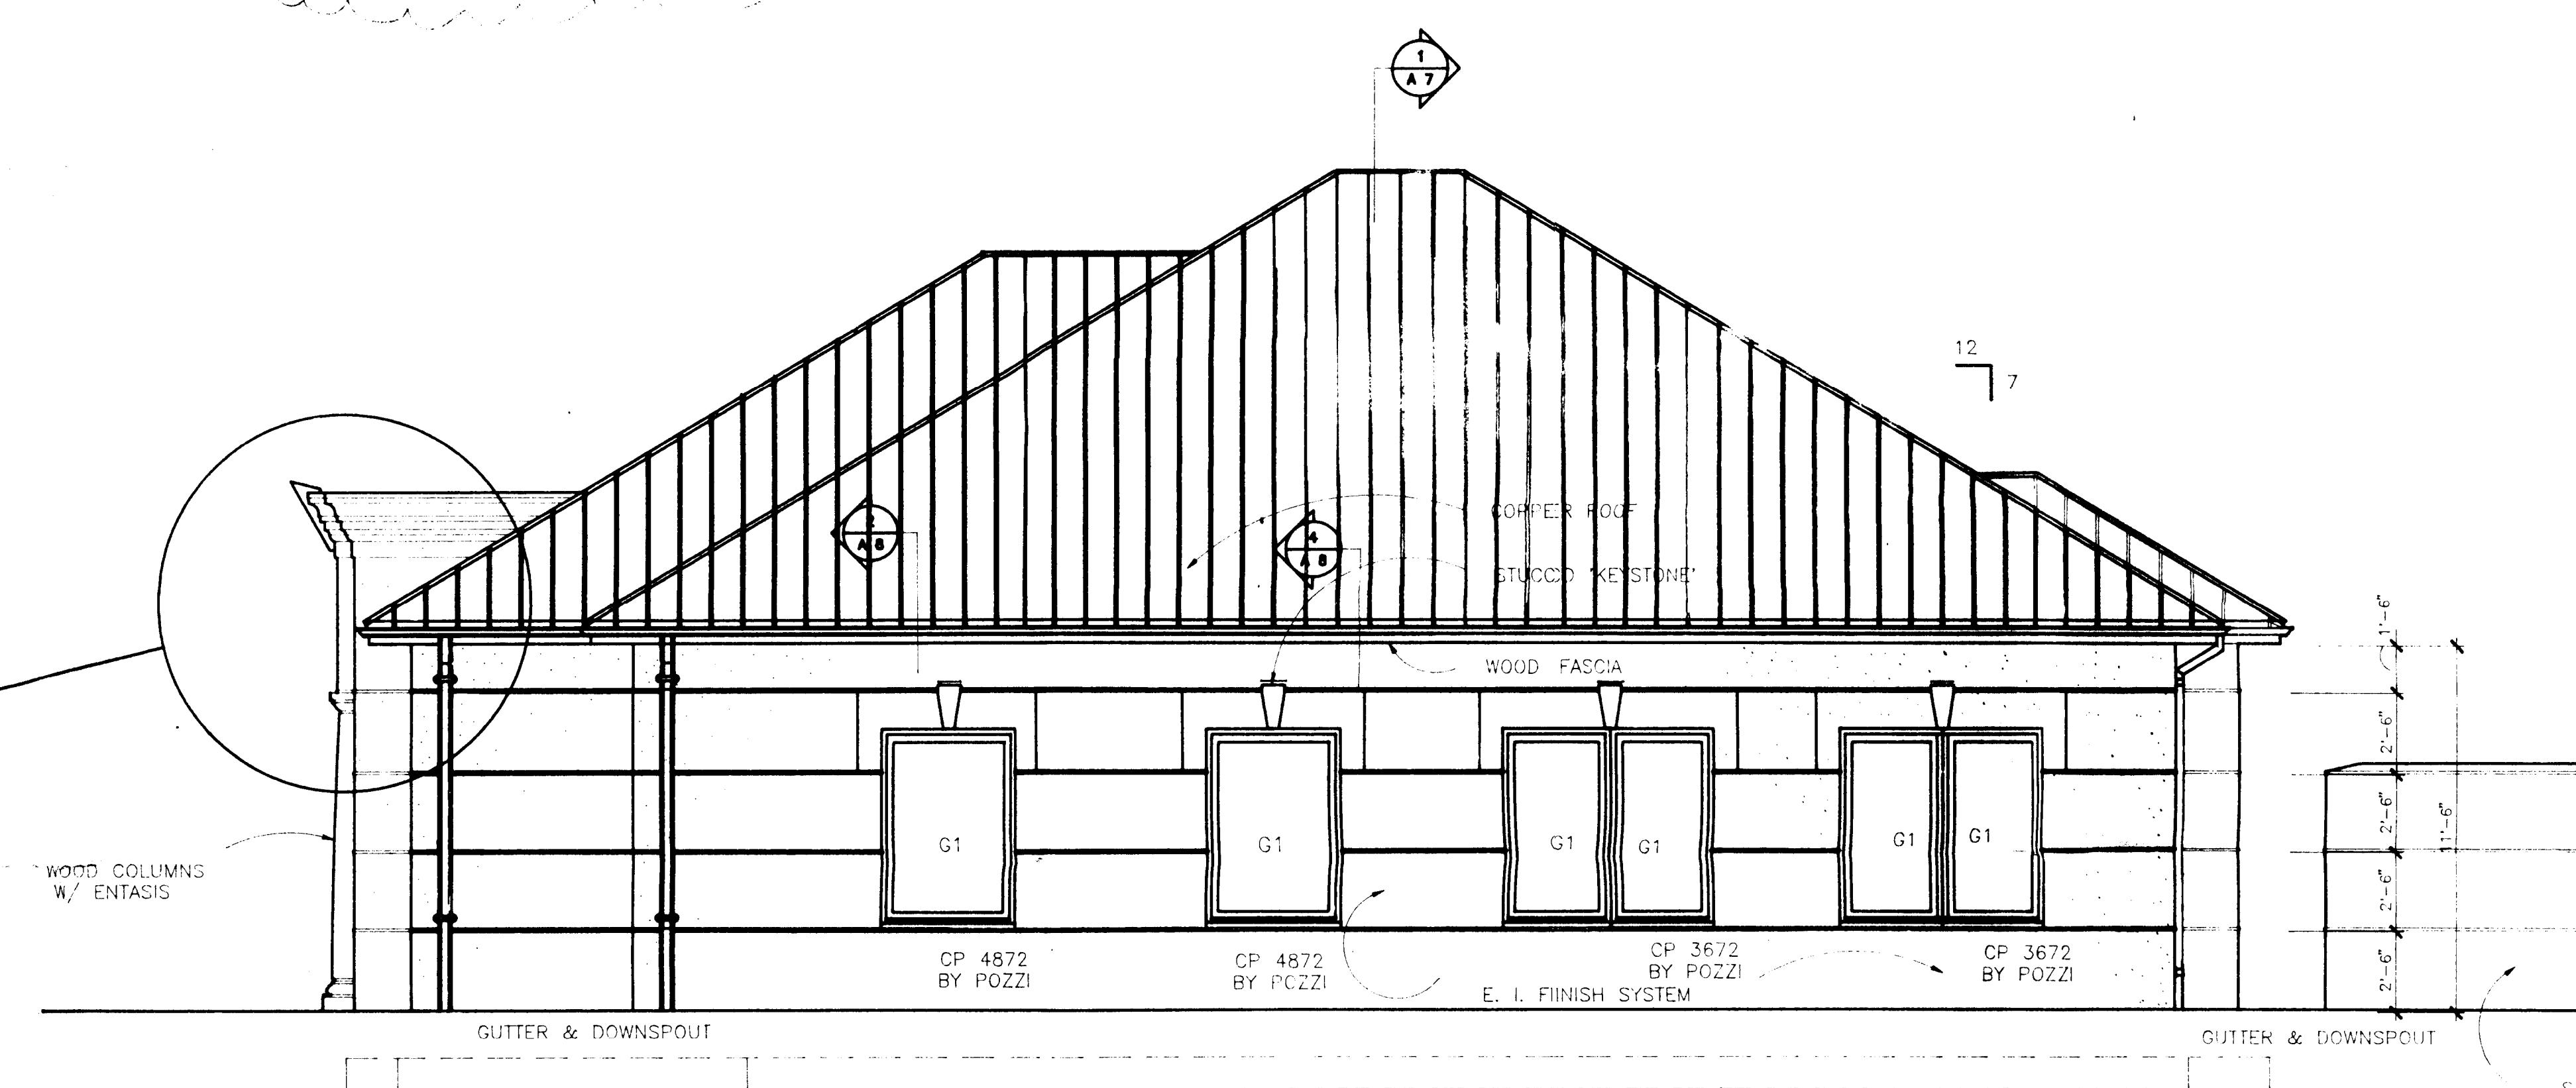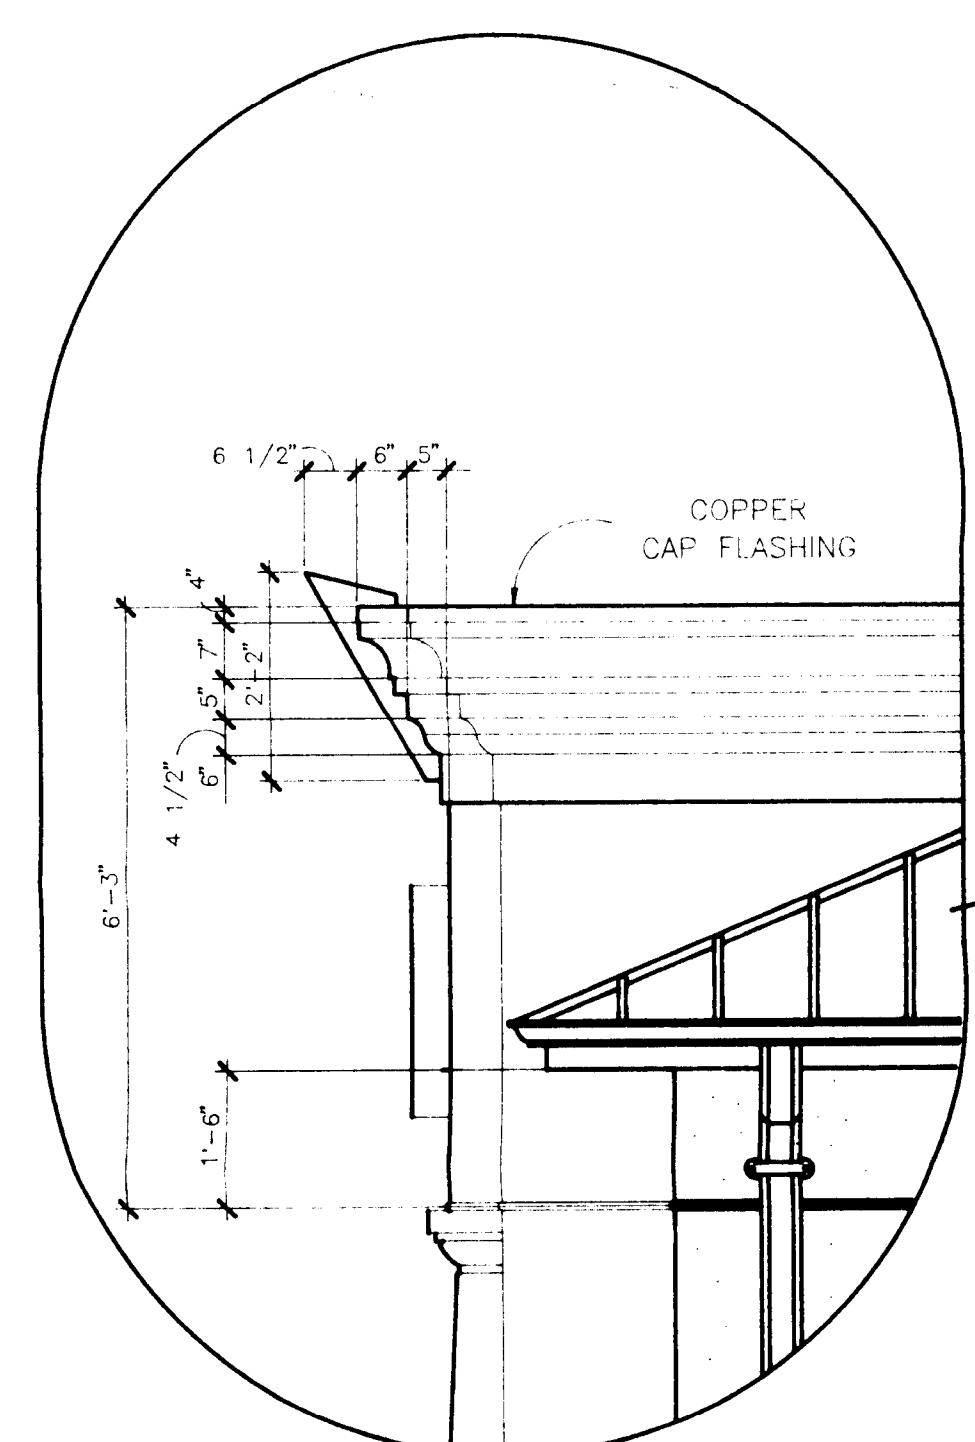

## ENLARGED ENTRY CORNICE

SCALE 1/2" = 1'-0"

## SIDE ELEVATION

SCALE 1/4" = 1'-0"

## ENLARGED WINDOW DETAIL

SCALE 1/2" = 1'-0"

Attached by administration  
approved dated 07/26/91 by  
Martin R. Cranton, Jr.

CHARLOTTE,  
NORTH CAROLINASheet  
Description  
ELEVATIONSCHARLOTTE-MECKLENBURG  
PLANNING COMMISSION  
INTER-OFFICE COMMUNICATION

DATE: July 26, 1991

TO: Robert Brandon  
Zoning AdministratorFROM: Martin R. Cranton, Jr.  
Planning DirectorSUBJECT: Administrative Approval for Petition #98-34 by Strawberry Hill  
Associates, Tax Parcel No. 185-121-29, 17. Revision to Bank Elevations

Attached is a revised building elevation for the NCNB bank at the Strawberry Hill Center. The elevation has been revised to add a pitched roof to the bank's elevation. Due to the bank's use of similar materials on the remainder of the building, the building appears to still fit well with the remainder of the center. Since these changes are minor in nature I am administratively approving this plan. Please use this plan when evaluating requests for building permits.

MRCjr/KRM/sls  
Attachment



