



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Project: **TOUCHSTONE VILLAGE CENTER**  
 for: **CROSLAND GROUP**  
 Sheet Title: **REZONING PLAN**

Partner In Charge: \_\_\_\_\_  
 Project Architect/Job Captain: \_\_\_\_\_  
 Drawn By: \_\_\_\_\_  
 Date Drawn: \_\_\_\_\_  
 Revisions: \_\_\_\_\_  
 1 Date: 1/22/70  
 2 Date: 2/15/70  
 3 Date: 2/25/70  
 4 Date: \_\_\_\_\_  
 5 Date: \_\_\_\_\_  
 6 Date: \_\_\_\_\_  
 7 Date: \_\_\_\_\_

Print Number: **2094-X4**  
 Sheet No.: **SF - 1**

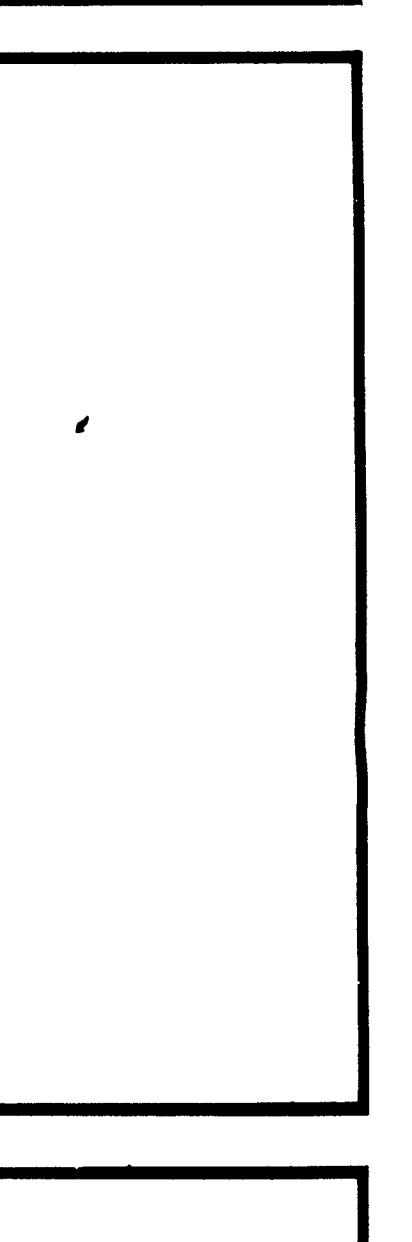

**CHARLOTTE-MECKLENBURG  
PLANNING COMMISSION**  
 INTER-OFFICE COMMUNICATION

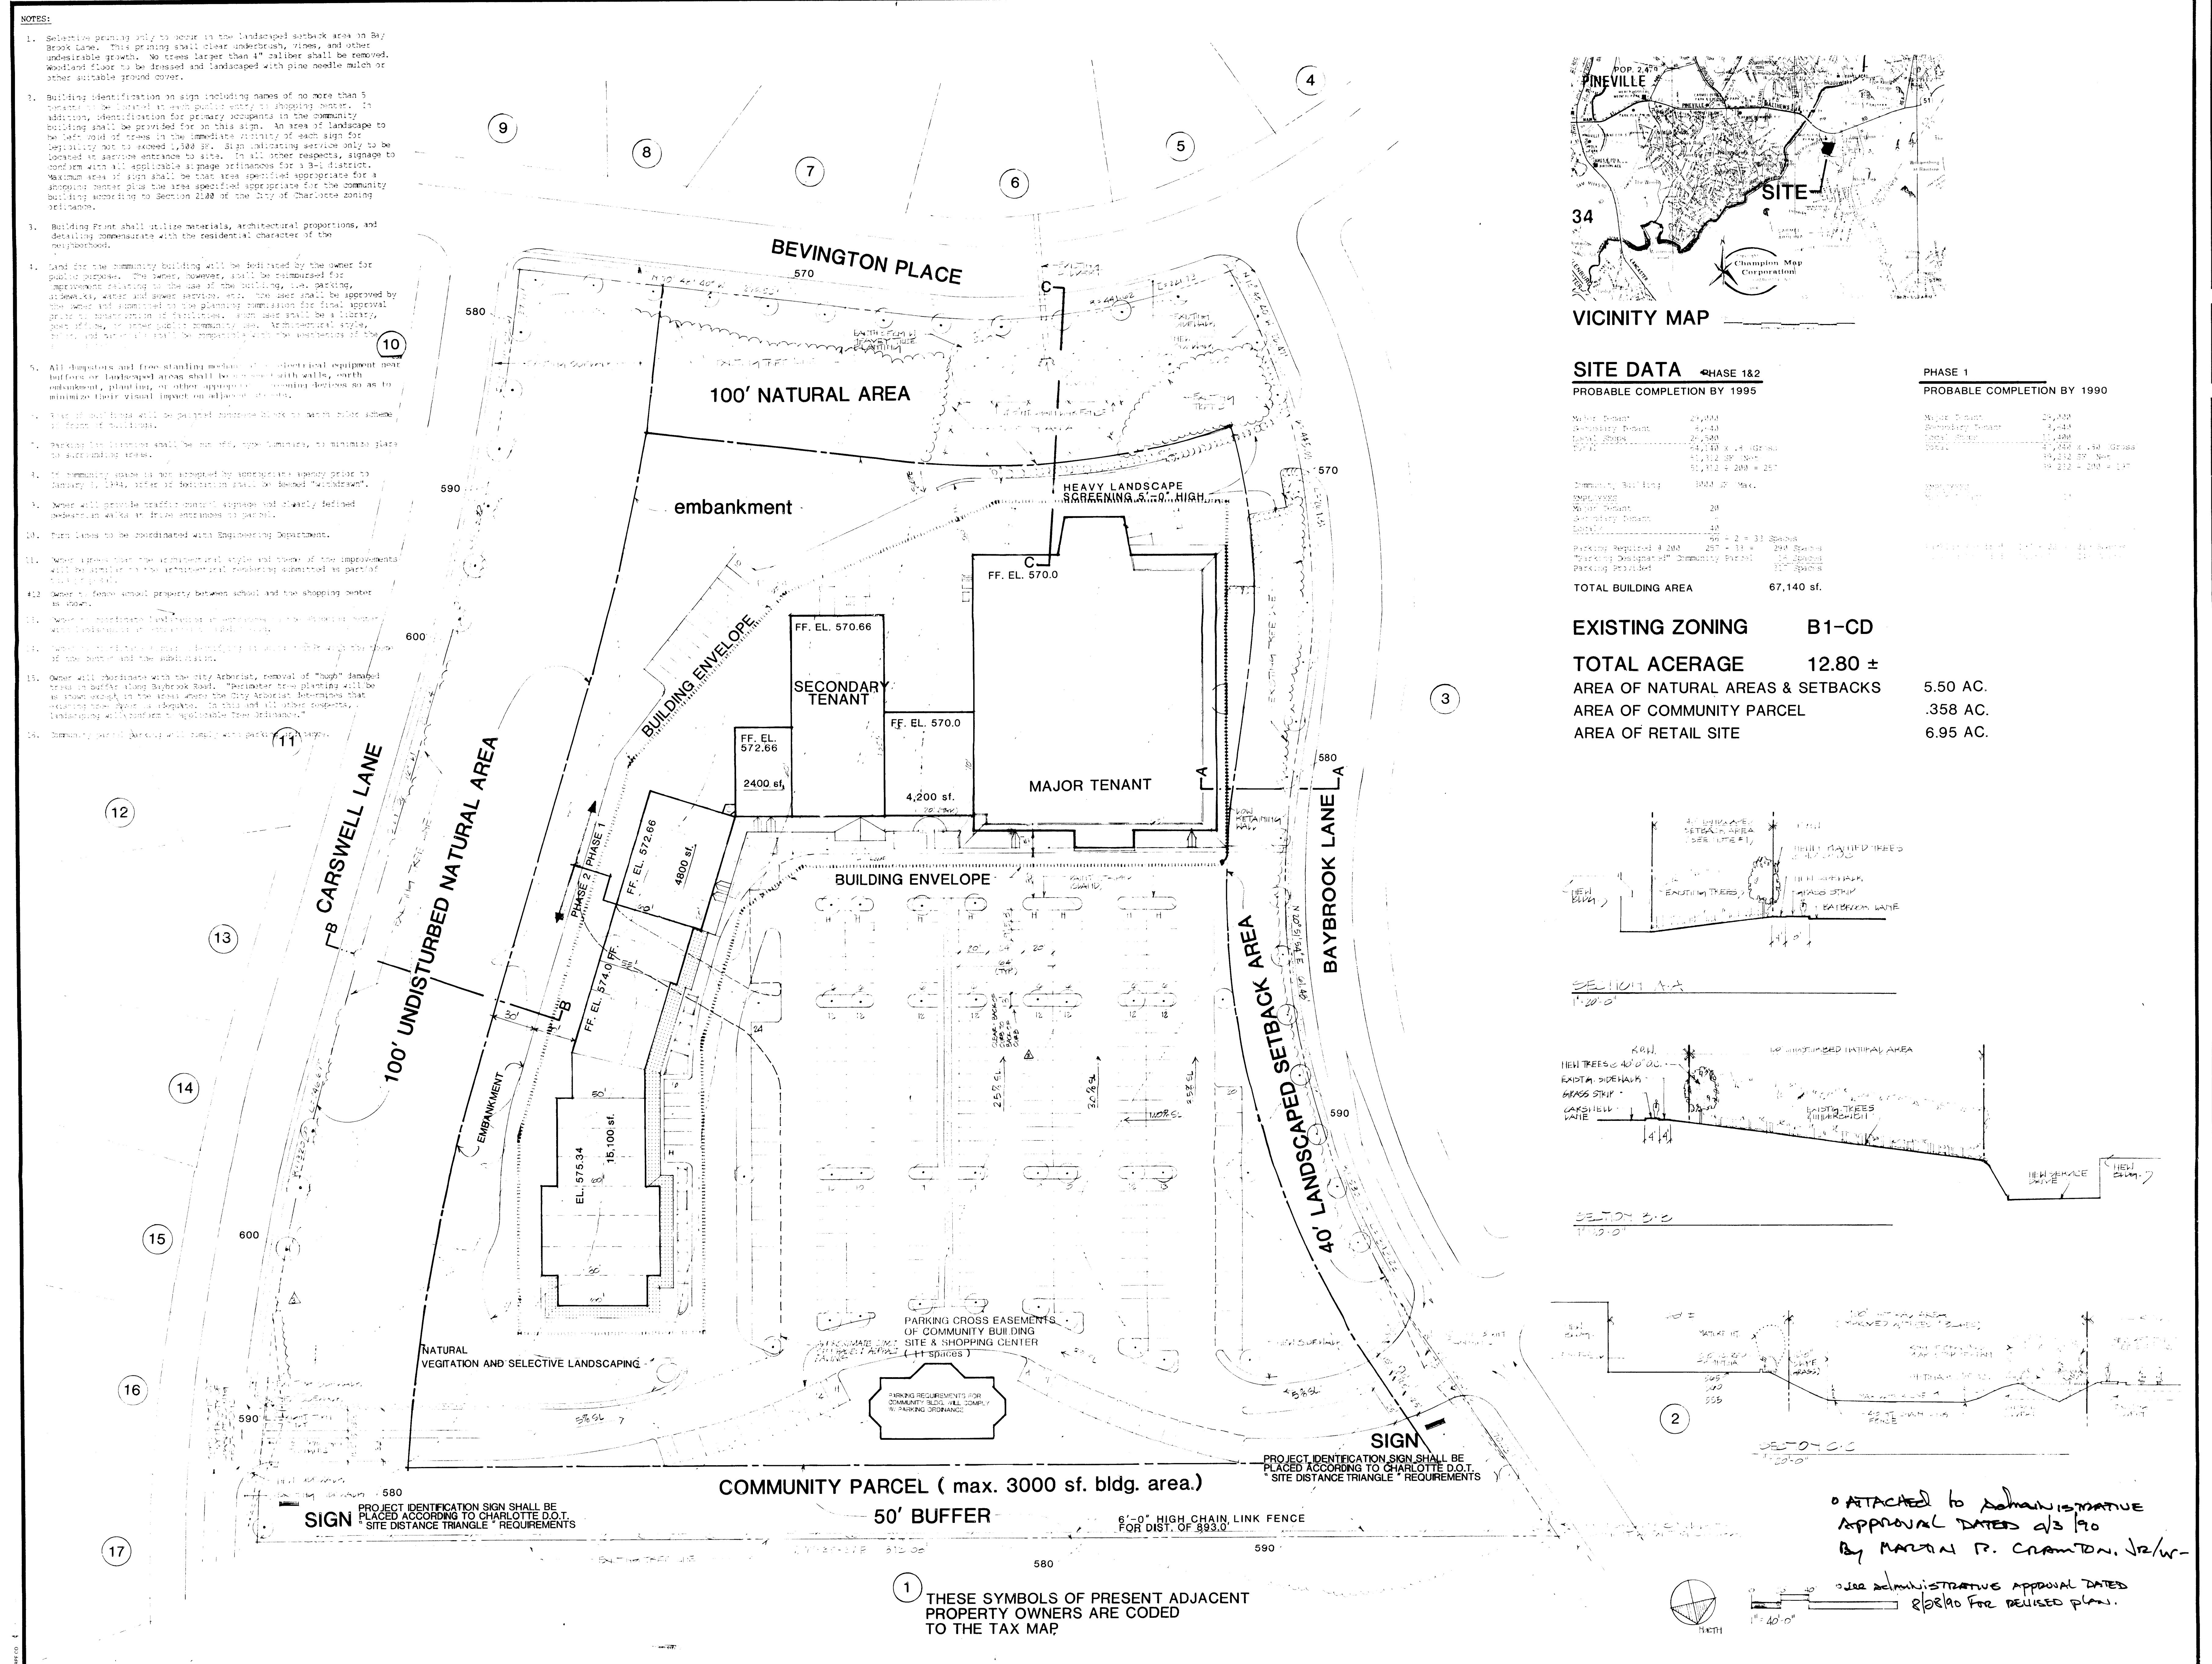DATE: April 3, 1990


TO: Robert Brandon  
 Zoning Administrator

FROM: Martin R. Cranston, Jr.  
 Planning Director

SUBJECT: Administrative Approval for Petition #90-13  
 Tax Parcel #223-025-02

Attached is a revised plan for the above mentioned zoning petition. The petition has been revised to eliminate eight proposed trees along Carswell Lane. These trees are not needed due to the large number of existing trees along portions of Carswell Lane. If these trees were planted existing trees would have to be removed. Since this change is minor in nature I am administratively approving this plan. Please use this plan when evaluating requests for building permits.



MRC/KDM:sls  
 Attachment

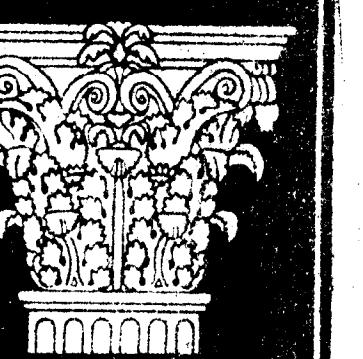

5815 Westpark Drive  
Charlotte, NC 28210  
Phone (704)525-6350  
Columbia-Myrtle Beach

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Little & Associates Architects, Inc.

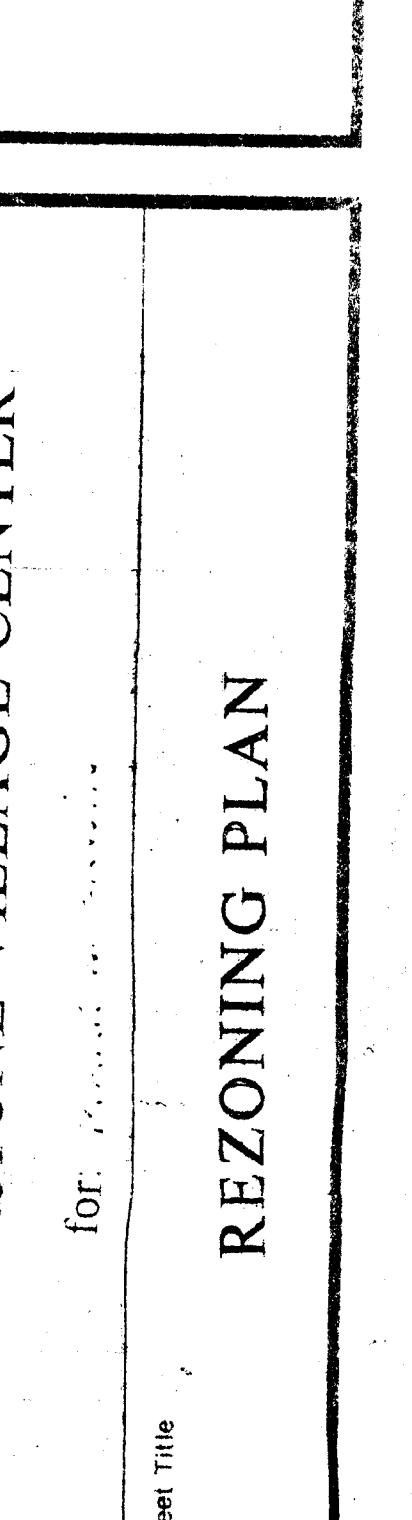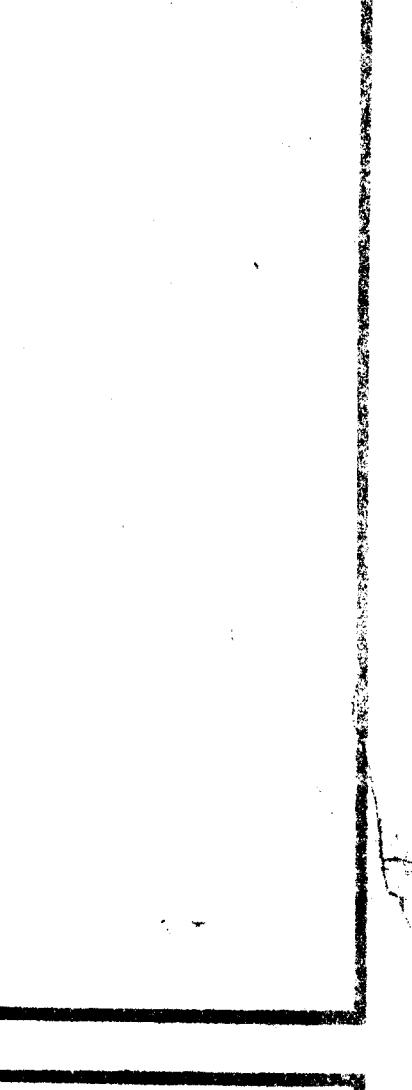

Partner In Charge	[REDACTED]								
Project Architect/Job Control	[REDACTED]								
Review By	[REDACTED]								
Date Drawn	12-87								
Revisions	<table border="1"> <tr><td>No. 1</td><td>Date 1-22-97</td></tr> <tr><td>No. 2</td><td>Date 2-21-97</td></tr> <tr><td>No. 3</td><td>Date 2-25-97</td></tr> <tr><td>No. 4</td><td>Date 5-20-97</td></tr> </table>	No. 1	Date 1-22-97	No. 2	Date 2-21-97	No. 3	Date 2-25-97	No. 4	Date 5-20-97
No. 1	Date 1-22-97								
No. 2	Date 2-21-97								
No. 3	Date 2-25-97								
No. 4	Date 5-20-97								
Issue Date	[REDACTED]								





Project Number	2094-X4
Sheet No.	[REDACTED]
SP-1	[REDACTED]

NOTES:

- Signage is limited to signs on the developed side of the Bay Brook Lane. This building shall contain underbrush, trees, and other undesirable growth. No trees larger than 1" caliper shall be removed, woodwind shall be dressed and landscaped with pine needle mulch or other suitable ground cover.
- Building identification signs including names of no more than 3 letters shall be located at each public entry to shopping center. If building identification signs are present, the maximum area of landscape to be left will be proportional to the size of each sign. Sign height no more than 12'000 sq ft. Sign advertising surface only to be 20% of total sign area. All signs shall be recessed or integrated with building. Maximum area of sign shall be area specified appropriate for a single tenant plus the area specified for a building. Signs shall be submitted according to Section 2100 of the City of Charlotte zoning ordinance.
- Building front area of the building area, architectural proportions, and detailing are to reflect the residential character of the neighborhood.
- Used for the community building will be determined by the power for public purposes. The power, however, will be controlled for improvement relative to the use of the building, lot, parking, sidewalks, water and power services, etc. The use will be approved by the appropriate department prior to the issuance of the permit. Approval prior to construction of facilities. Such uses may be a library, post office, or other public community use. Architectural style, colors and materials shall be compatible with the neighborhood if it is used.
- All buildings and free-standing equipment or electrical equipment near buildings or landscapes must be set back from buildings, earth embankments, plantings, other improvements, roads, etc., so as to minimize their visual impact on adjacent areas.
- Area of buildings and/or perimeter drainage shall be shown color scheme in form of buildings.
- Parking lot dimensions shall be one off, type numbers, to eliminate glare to surrounding areas.
- If community space is not accepted by appropriate agency prior to completion of the building, the building will be withdrawn. PARCEL SHALL THEN BE USED FOR AN INDIVIDUAL USE.
- Area will provide traffic control signage and clearly defined pedestrian walks at grade easements to parcels.
- Area to be coordinated with Engineering Department.
- Area agrees that the architectural style and theme of the improvements will be similar to the architectural rendering submitted as part of the rezoning application.
- Area to follow usual property between school and the shopping center.
- Area to coordinate with the engineering department.
- Area to coordinate with the engineering department.
- Area will coordinate with the city of Mecklenburg. Removal of matured trees is known except in the areas where the City Arborist determines that existing trees need to be replaced. In this and all other respects, abiding with applicable tree ordinances.
- Community parcel owner will comply with park requirements.

- Building identification signs including names of no more than 3 letters shall be located at each public entry to shopping center. If building identification signs are present, the maximum area of landscape to be left will be proportional to the size of each sign. Sign height no more than 12'000 sq ft. Sign advertising surface only to be 20% of total sign area. All signs shall be recessed or integrated with building. Maximum area of sign shall be area specified appropriate for a single tenant plus the area specified for a building. Signs shall be submitted according to Section 2100 of the City of Charlotte zoning ordinance.
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- Community parcel owner will comply with park requirements.

14. Community parcel owner will comply with park requirements.

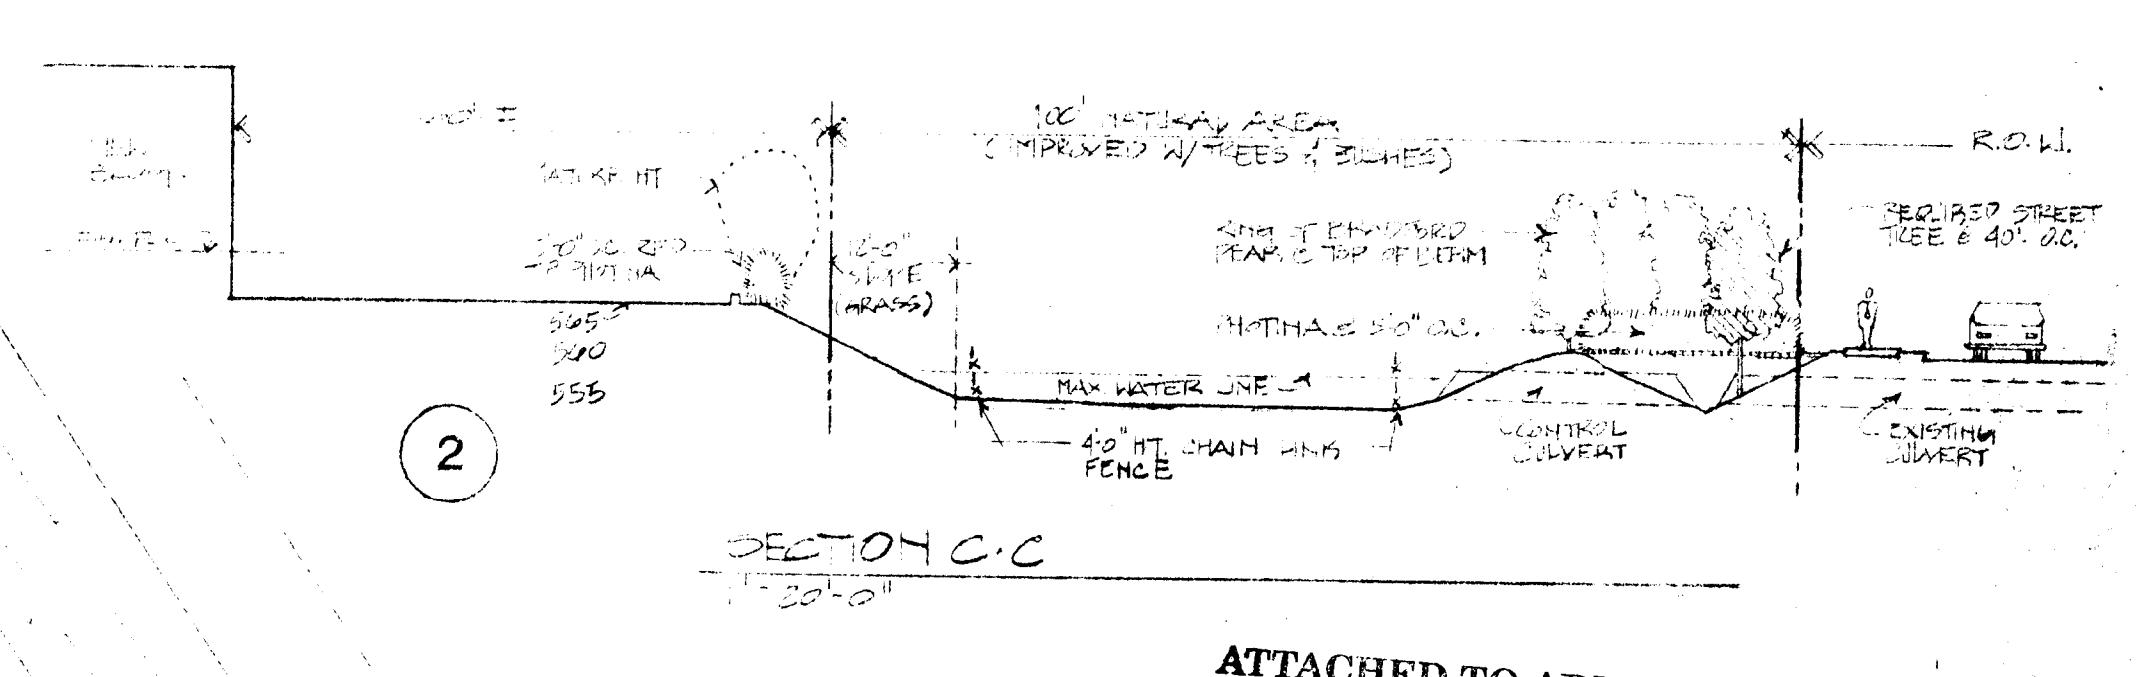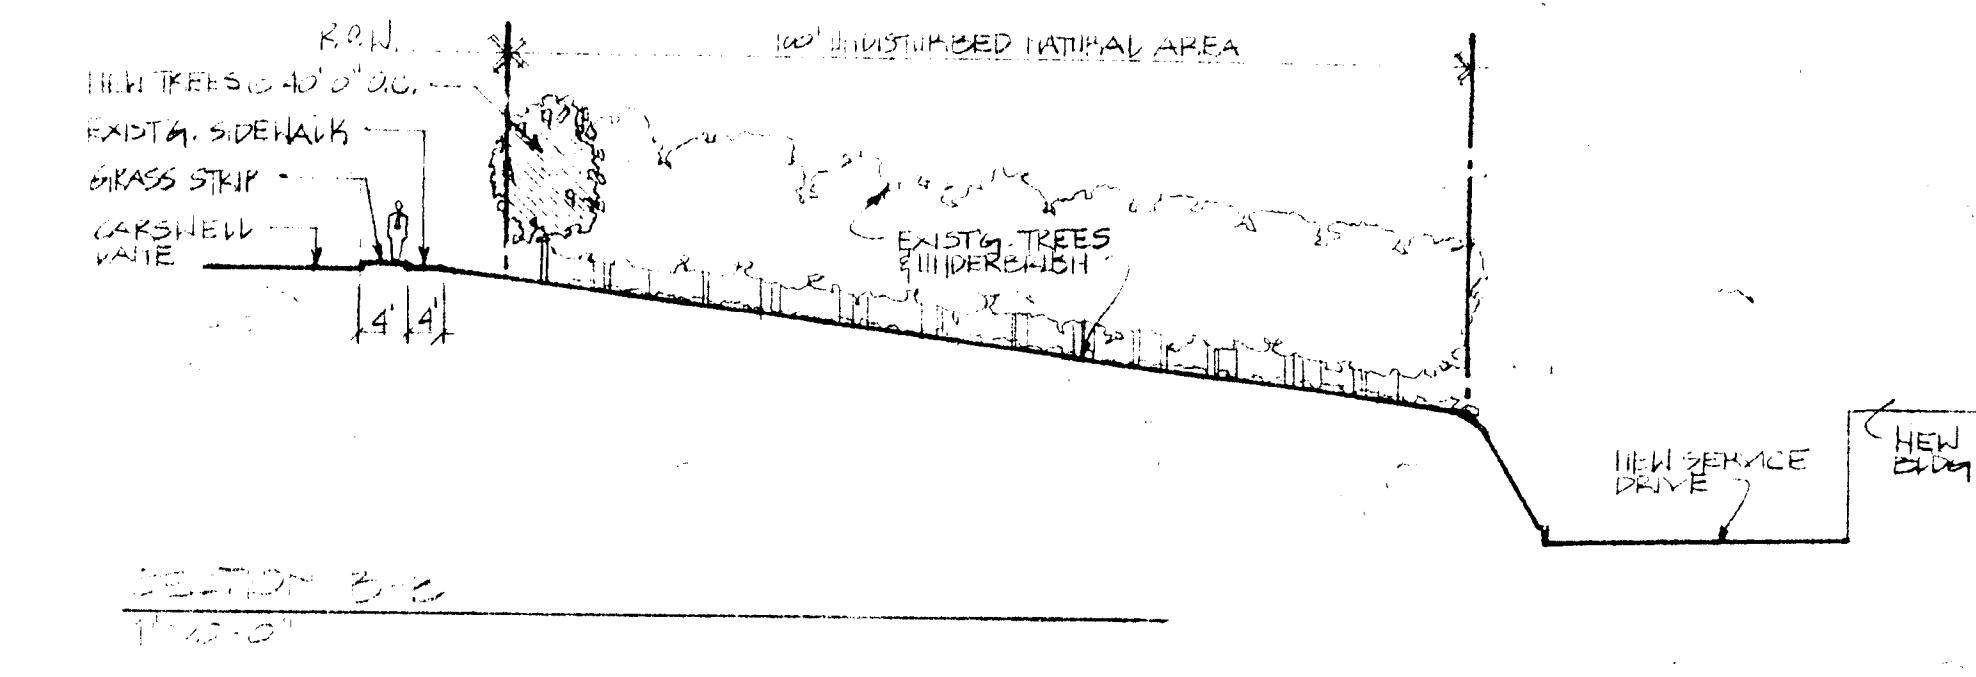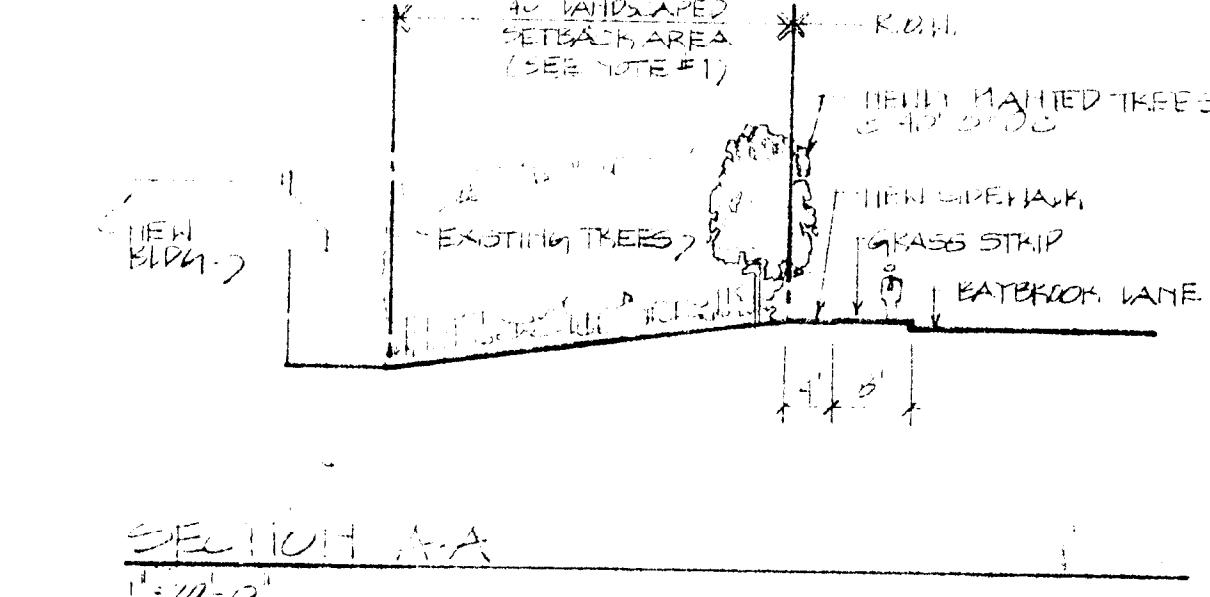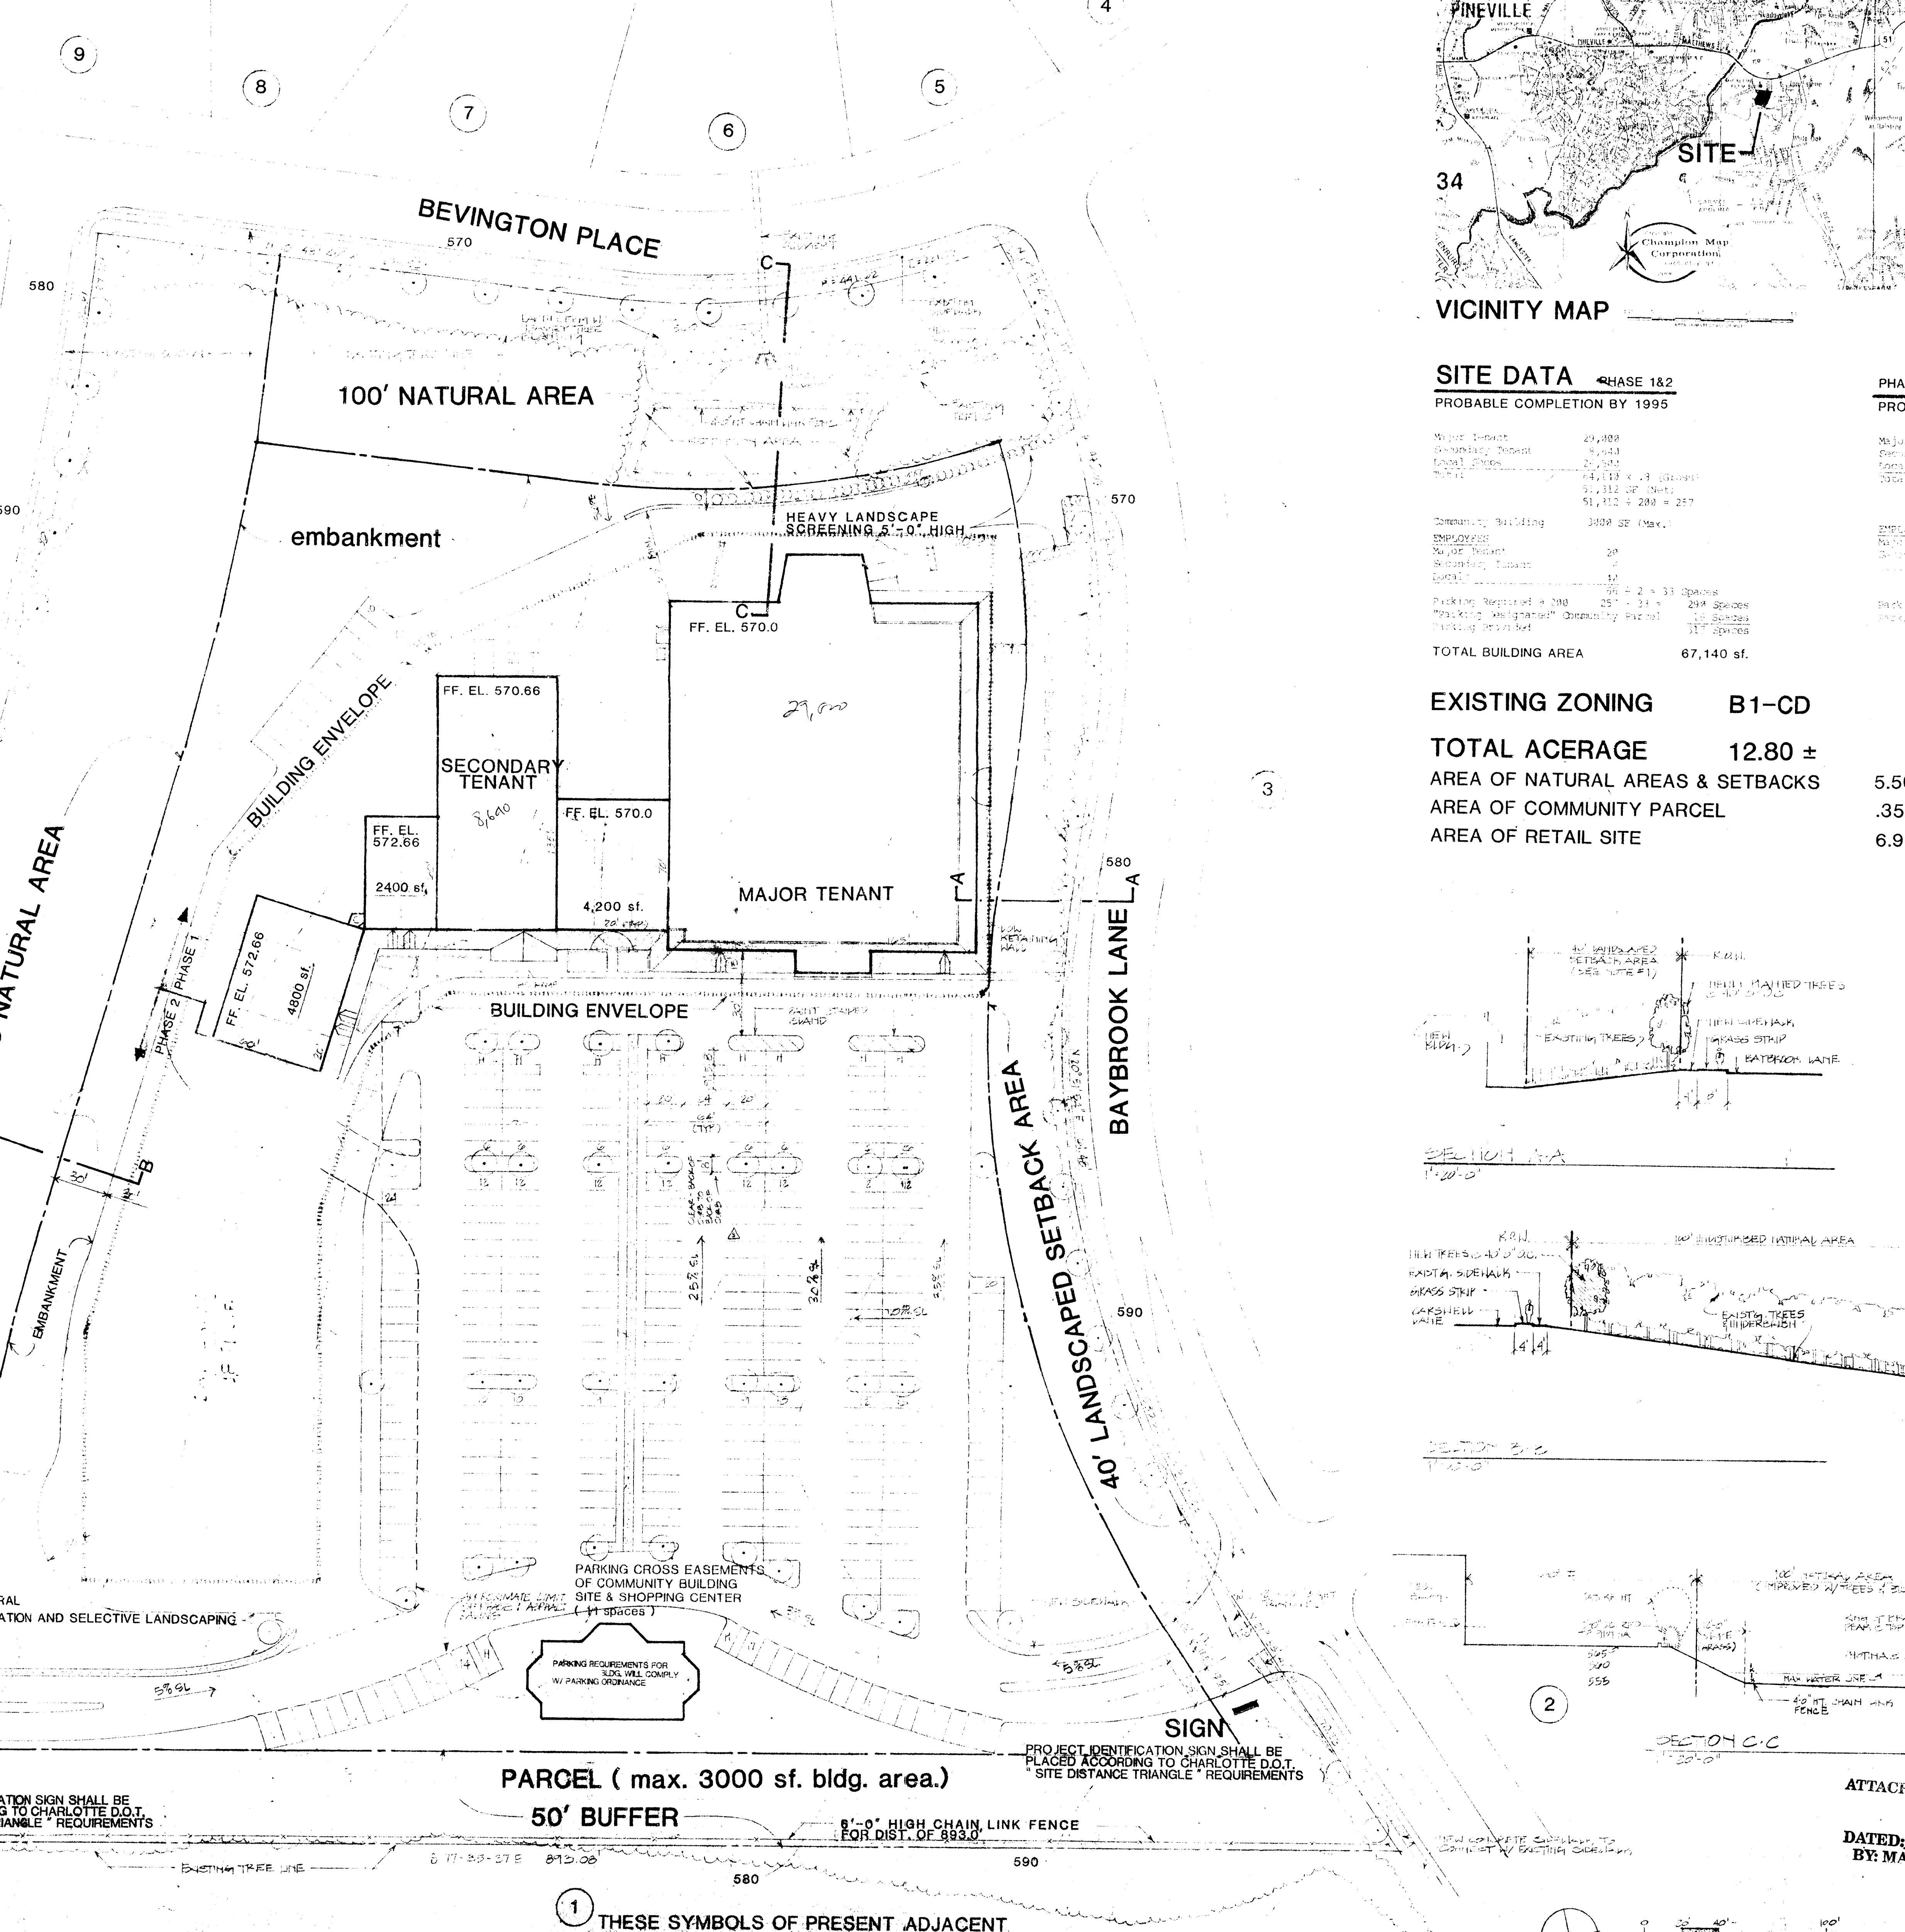

ATTACHED TO ADMINISTRATIVE APPROVAL  
DATED: 6/11/96  
BY: MARTIN R. CRANTON, JR.

CHARLOTTE-MECKLENBURG  
PLANNING COMMISSION

INTER-OFFICE COMMUNICATION

DATE: June 11, 1996

TO: Robert Brandon  
Zoning Administrator


FROM: Martin R. Cranton, Jr.  
Planning Director

SUBJECT: Administrative Approval for Petition No. 90-13 by Touchstone Assoc. Ltd. Partnership Tax  
Parcel # 223-025-02

Attached is a revised plan for the above mentioned rezoning petition. The plan has been revised to eliminate the commitment to a 3,000sqft. Community Park. The originally approved plan had committed to making this parcel available upon request by a community organization. The plan had also stated that any such request would need to occur prior to January 3rd 1994 otherwise the offer of dedication would be withdrawn. Since this date has passed and no request has been made by any community organization the owner has requested that we administratively approve a revised plan that eliminates the commitment to the community park and allows the community parcel building to be used for any use allowed by the approved conditional plan and the B-1 zoning classification. The square footage of any building built on this parcel will be limited to 3,000sqft. and subject to all other conditions of the approved conditional plan.

Since this change is minor and the total square footage for the center has not been exceeded and the commitment to dedicate the community parcel has elapsed we are administratively approving this revised plan. Please use this revised plan when evaluating request for building permits and certificates of occupancy.


90-13

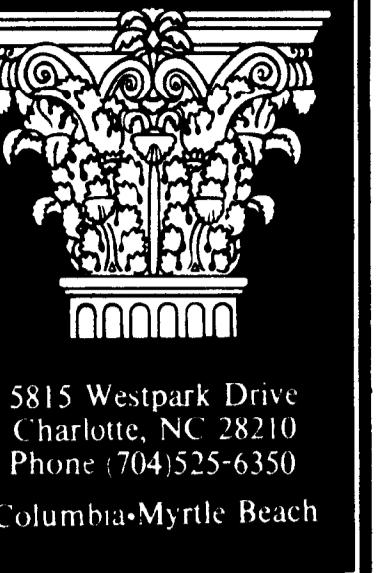

5815 Westpark Drive  
Charlotte, NC 28210  
Phone: (704) 552-0550  
Columbia-Mystic Beach

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### VICINITY MAP

### SITE DATA

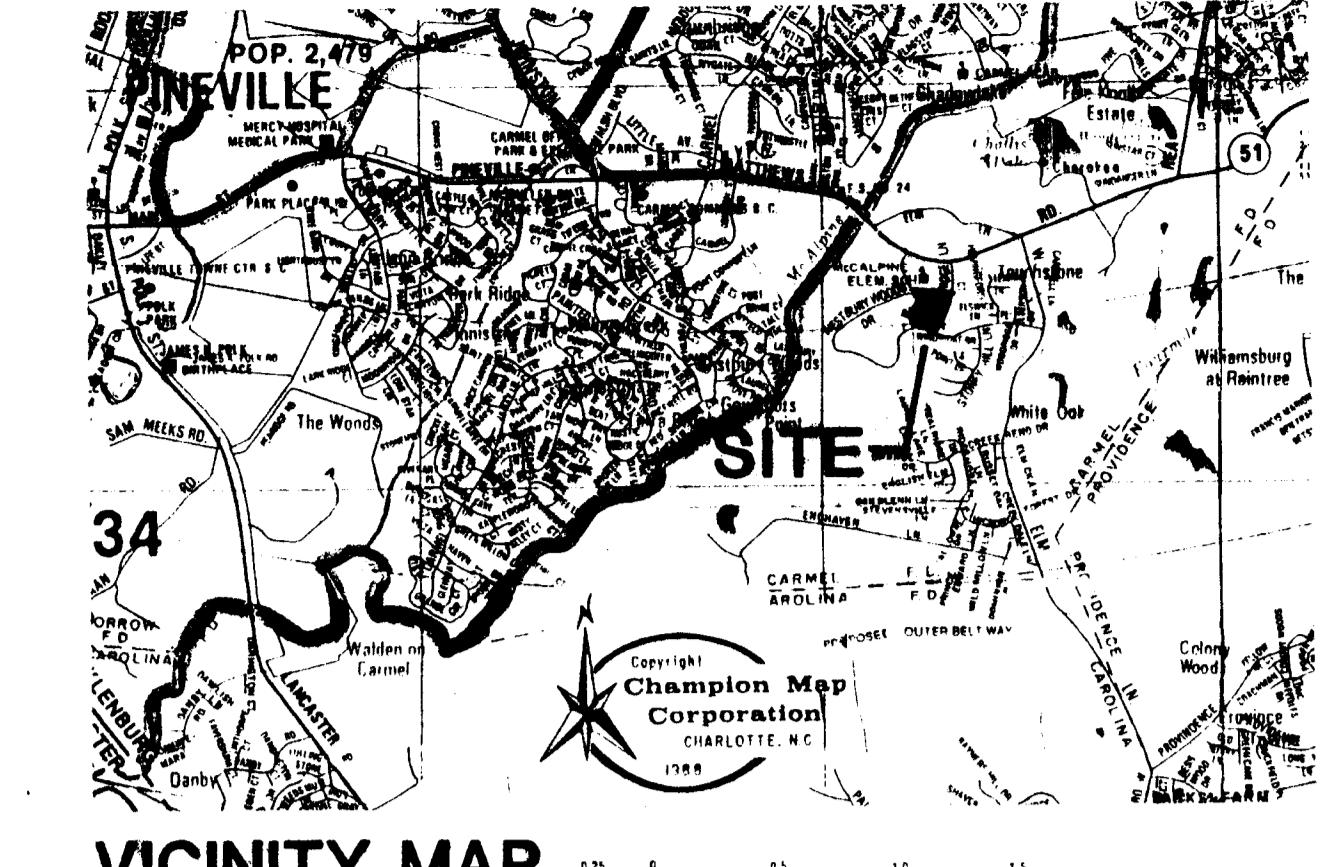PHASE 1A2  
PROBABLE COMPLETION BY 1995

Major Tenant	29,400
Secondary Tenant	8,440
Local Shops	11,480
Total	64,140 x .8 (Gross)
	51,312 SF (Net)
	51,312 + 208 = 257

Community Building 3800 SF (Max.)

EMPLOYEES 20

Major Tenant 20

Secondary Tenant 6

Locals 48

Parking Required @ 208 66 = 2 = 33 Spaces

"Parking Designated" Community Parcel 15 Spaces

Parking Provided 317 Spaces

TOTAL BUILDING AREA 67,140 sf.

PHASE 1  
PROBABLE COMPLETION BY 1990

Major Tenant	29,400
Secondary Tenant	8,440
Local Shops	11,480
Total	47,040 x .80 (Gross)
	39,232 SF (Net)
	39,232 + 208 = 197

EMPLOYEES

Major Tenant 20

Secondary Tenant 6

Locals 48

Parking Required 197 + 22 = 219 Spaces

Parking Provided Phase 1 = 243 Spaces

TOTAL BUILDING AREA 67,140 sf.


### EXISTING ZONING B1-CD

### TOTAL ACERAGE 12.80 ±


AREA OF NATURAL AREAS & SETBACKS 5.50 AC.

AREA OF COMMUNITY PARCEL .358 AC.


AREA OF RETAIL SITE 6.95 AC.

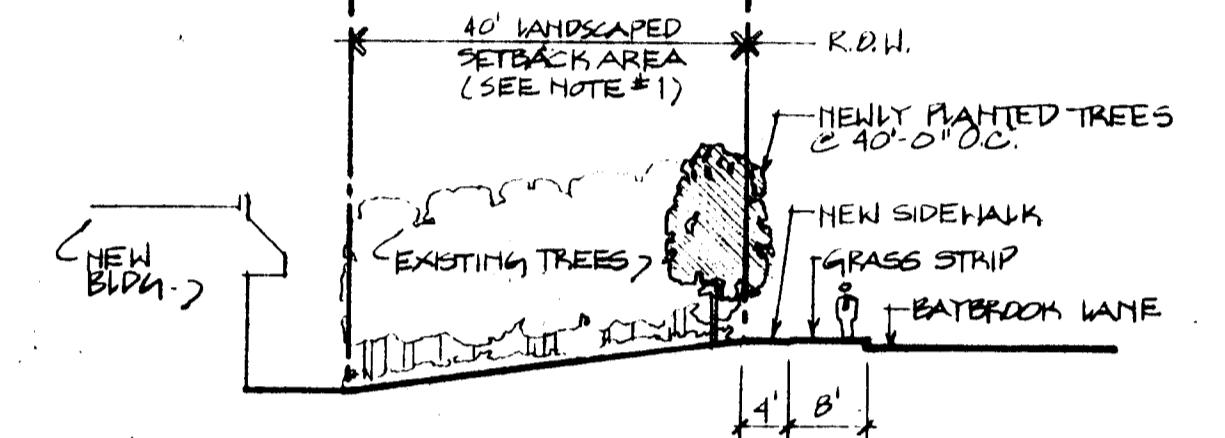

SECTION A-A  
1'-20'-0"

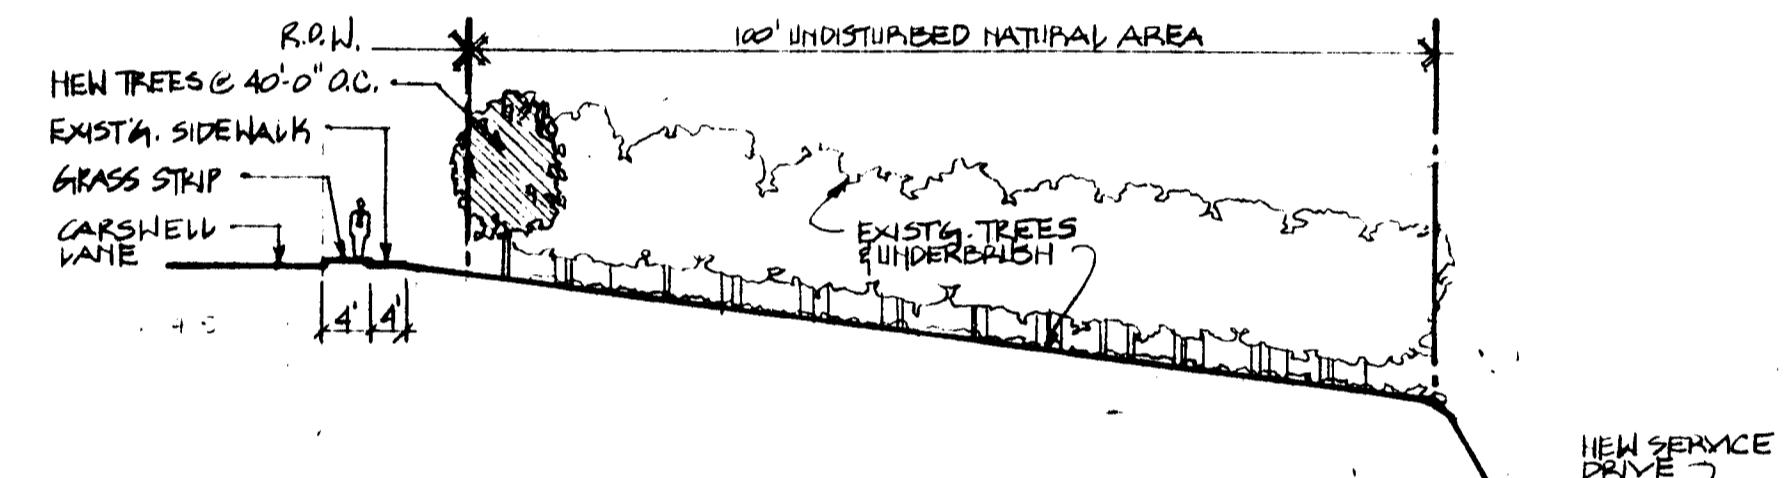

SECTION B-B  
1'-20'-0"

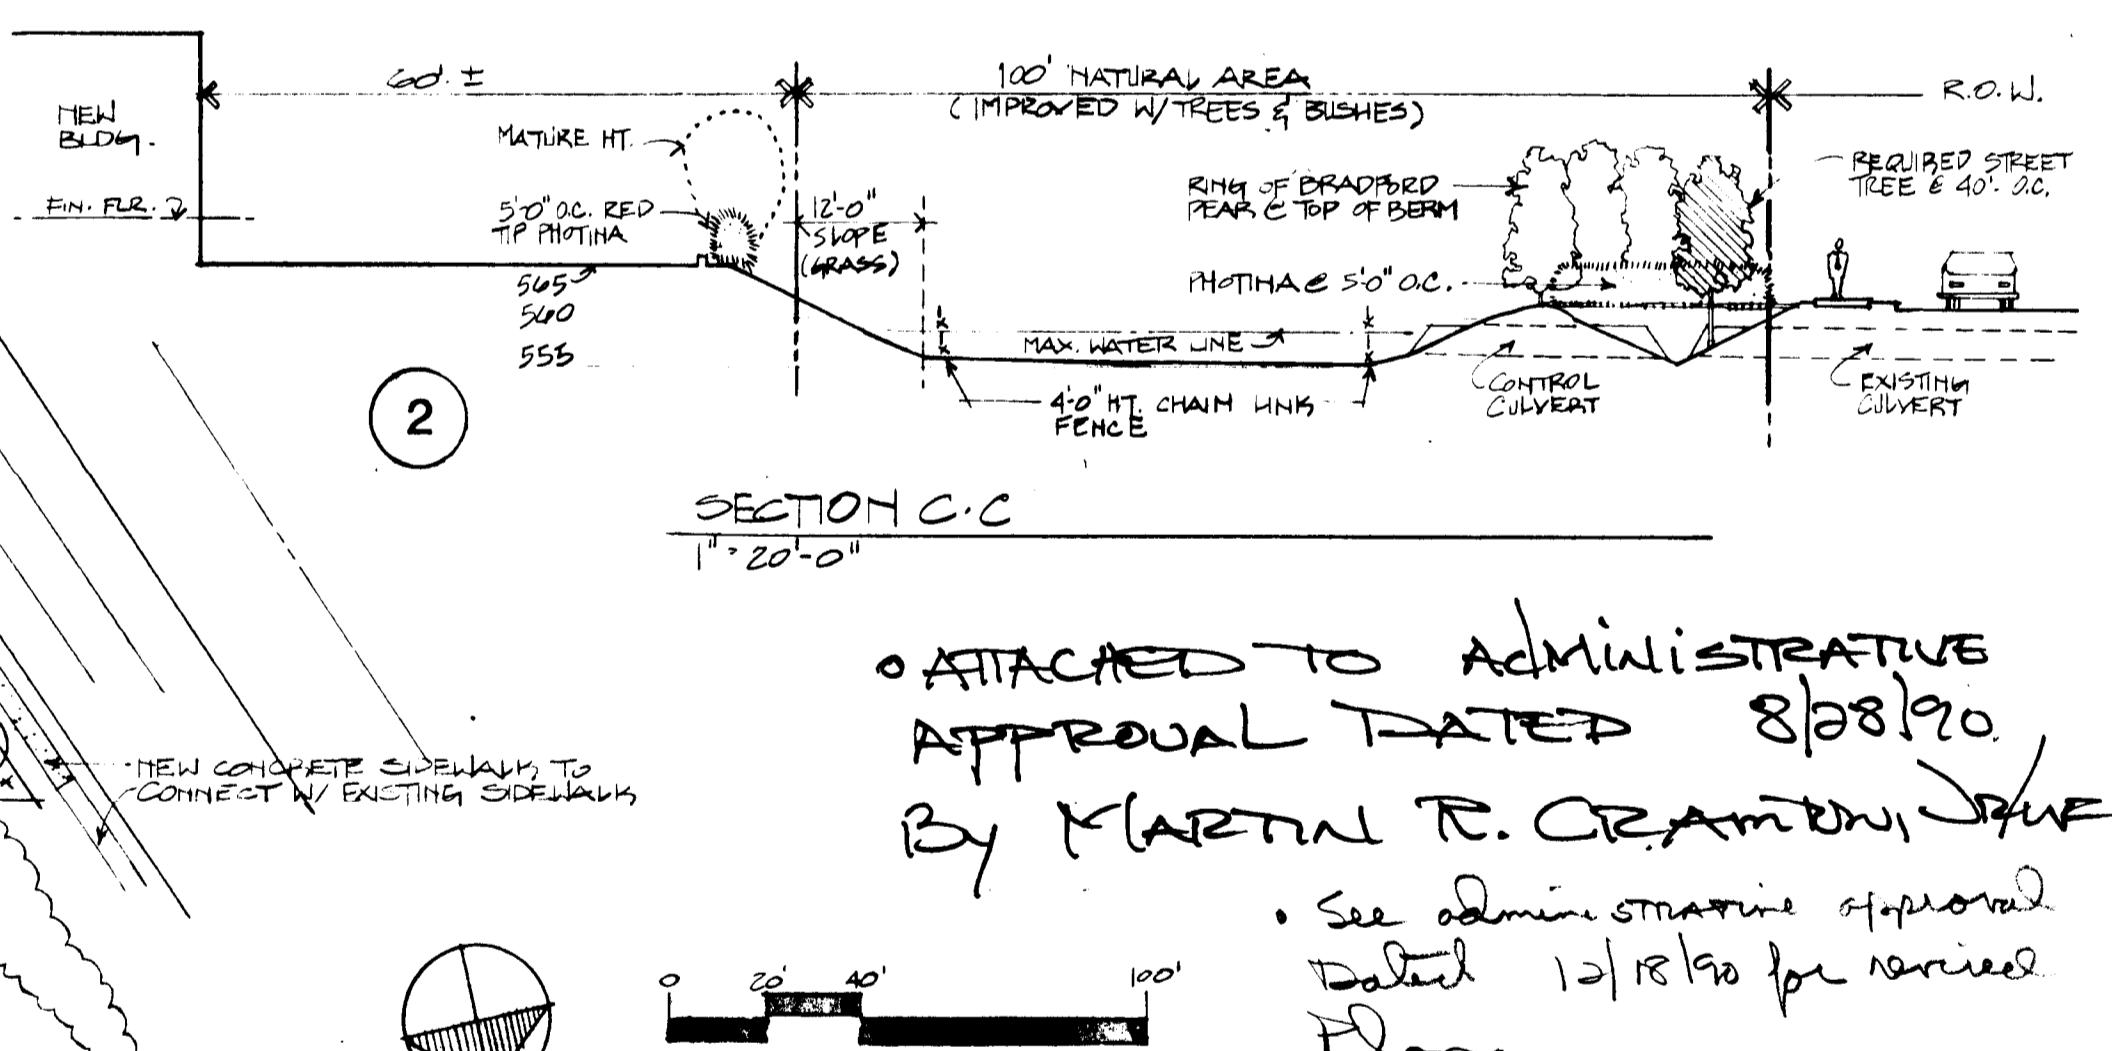

ATTACHED TO ADMINISTRATIVE APPROVAL DATED 8/08/90  
By MARTIN R. CRAMTON, Jr.

See administrative approval dated 10/18/90 for revised Plan

Project TOUCHSTONE VILLAGE CENTER  
for: CROSLAND GROUP  
Sheet Title \_\_\_\_\_  
Rezoning Plan

Partner In Charge  
V.R. FETTER  
Project Architect/Job Captain  
GAROLD  
Drawn By  
T. COOPER  
Date Drawn  
10/18/90  
Revisions  
No. 1 Date 1-22-90  
No. 2 Date 2-21-90  
No. 3 Date 3-25-90  
Issue Date

Project Number  
2094-X4  
Sheet  
SP-1

### CHARLOTTE-MECKLENBURG PLANNING COMMISSION

### INTER-OFFICE COMMUNICATION

DATE: August 28, 1990

TO: Robert Brandon  
Zoning Administrator

FROM: Martin R. Cramton, Jr.  
Planning Director


SUBJECT: Administrative Approval for Petition #90-13 Touchstone Assoc. Ltd.  
Partnership, Tax Parcel #223-023-02

Attached is a revised plan for the above mentioned rezoning petition. The plan is being revised to show a new location for the project identification sign along Carswell Lane. The sign is being moved from the north side of the driveway to the south side of the driveway. This shift will allow the developer to save the trees between the driveway and the school property to the north.

Pursuant to the authority as outlined in the zoning ordinance, I am administratively approving this plan. Please use it when evaluating requests for building permits.

NRC/KRM:als  
Attachment 10/17/90 9:00 AM 10/18/90



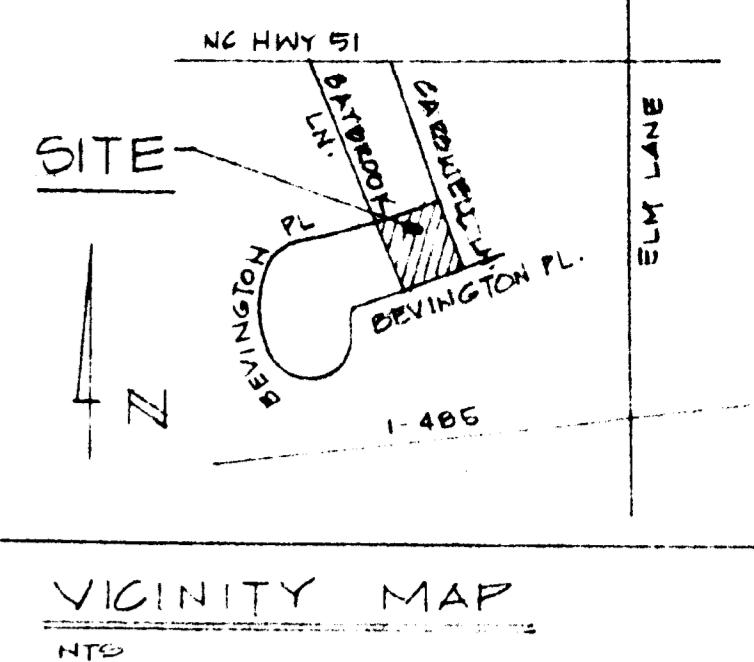

#### PROJECT DATA:

1. SITE ADDRESS: TOUCHSTONE VILLAGE CENTER, BAYBROOK LN / CARWELL LN / BEVINGTON PL., CHARLOTTE, NC
  2. TAX PARCEL NO: 223-253-02
  3. SITE ACREAGE: 1.10.28 AC. / PHASE 1  
1.55 AC. / PHASE 2
  4. ZONED: B1-CD PER REZONING PETITION 90-13 BY TOUCHSTONE ASSOCIATES LTD.
  5. DETENTION TOND IS EXISTING FOR THIS SITE. EXISTING DETENTION POND WAS DESIGNED TO HANDLE 7 ACRES OF IMPERVIOUS AREA PER THE CITY OF CHARLOTTE ENGINEERING DEPT.
- PHASE 1 = 4.7 ACRES IMPERVIOUS AREA  
PHASE 2 = .59 ACRE IMPERVIOUS AREA  
TOTAL = 5.34 ACRES IMPERVIOUS AREA

LINE	DIRECTION	DISTANCE
L1	N154°40' W	22.47'
L2	N205°15' E	61.48'
L3	S161°30' W	27.91'
L4	N025°15' W	19.39'
L5	N153°00' W	19.59'
L6	S55°08' E	80.45'
L7	N003°34' W	30.08'
L8	N36°17' W	85.34'
L9	N153°15' W	19.39'
L10	N172°42' E	251.66'
L11	N073°11' E	20.77'


CURVE	LENGTH	RADIUS	DIRECTION	CENTER
C1	269.31'	445.00'	N031°35' E	22.47'
C2	392.00'	540.00'	S029°56' W	40.00'
C3	168.47'	120.00'	S21°34'35" W	27.91'
C4	238.80'	130.00'	S34°08'53" W	19.39'
C5	221.74'	441.62'	N081°14'53" E	80.45'
C6	85.66'	251.63'	S36°17'00" W	30.08'
C7	51.00'	132.00'	S153°15'00" W	19.39'
C8	214.63'	132.00'	S172°42'00" E	251.66'

CURVE	LENGTH	RADIUS	DIRECTION	CENTER
C9	42.87'	11.11'	N031°35' E	22.47'
C10	19.91'	57.03'	S029°56' W	40.00'
C11	46.51'	49.44'	S21°34'35" W	27.91'
C12	75.69'	107.00'	S34°08'53" W	19.39'
C13	102.04'	137.00'	S153°15'00" W	80.45'
C14	51.00'	132.00'	S172°42'00" E	30.08'

#### NOTE:

ALL SITE INFORMATION WAS TAKEN FROM A SURVEY PREPARED BY:  
CAROLINA SURVEYORS  
P.O. BOX 267  
PINEVILLE, NC 28134  
HUGH WHITE, N.C.R.L.S.  
DATED: 6/16/94

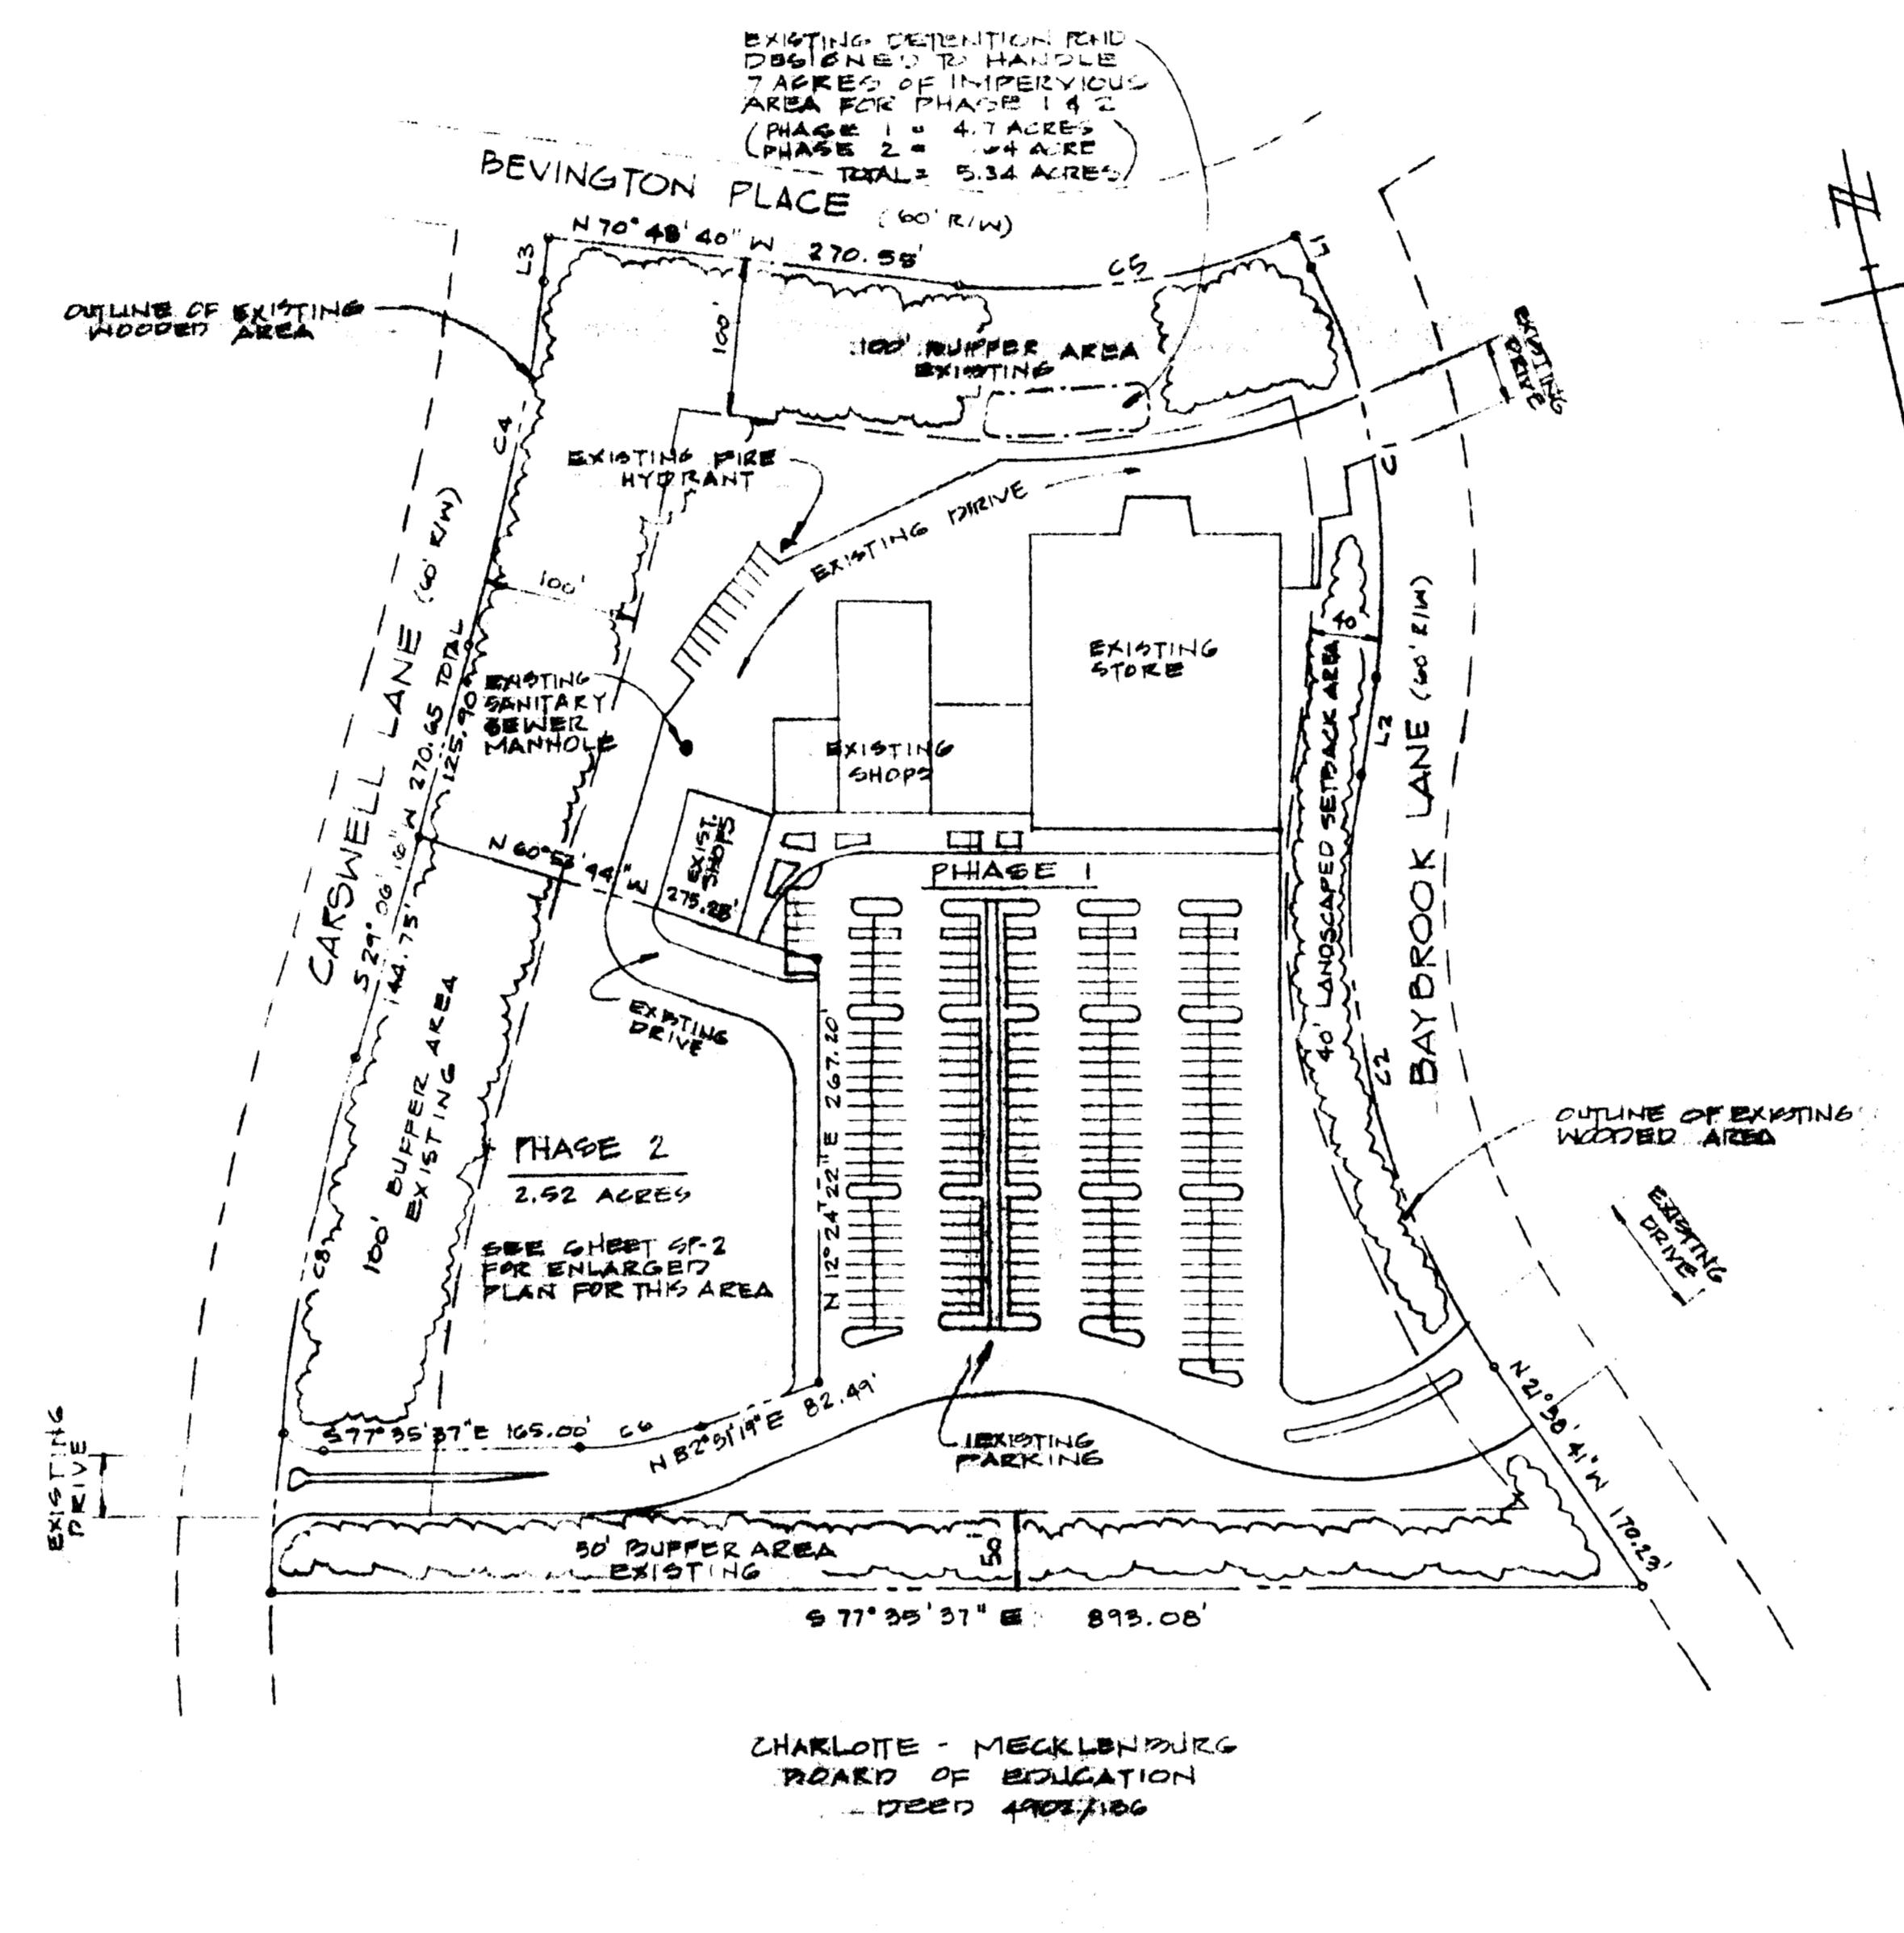

NOTE: SEE SHEET SP-2 FOR ENLARGED PHASE 2 SITE PLAN.

#### TOTAL SITE PLAN

SCALE: 1" = 100'

	REVISIONS	Project No.	Step Ahead Day Care	Drawing No.
	Date	CHARLOTTE, NC	Lee Shore	SP-1
	Owner	D.A.DAVIS CONSTRUCTION COMPANY, INC.		
	Scale: 1"=100'	Date: 5/30/95	3206 W. Roosevelt Blvd, Monroe, N.C. 28110 of -2	
	Drawn By: J.H.	Approved: CLH		
	Revised By:	Issue:		

#### CHARLOTTE-MECKLENBURG PLANNING COMMISSION INTER-OFFICE COMMUNICATION


TO: Robert Brandon  
Zoning Administrator  
FROM: Martin R. Cramton, Jr.  
Planning Director

SUBJECT: Administrative Approval for Petition No. 90-13 by Touchstone Associates Ltd. Partnership  
Tax Parcel # 223-025-02

Attached is a revised plan for a phase two of the Touchstone Shopping Center showing the development of this phase with a day care center. The originally approved plan had shown the development of this phase with additional shop space. Since day care centers are allowed by B-1 zoning classification and the total square footage for the shopping center is not been exceeded we are administratively approving this revised plan. Please use this revised plan when evaluating requests for building permits and certificates of occupancy.

Also included are building elevations noting that the building will use the same brick and roofing material as the shopping center.

DATE: August 10, 1995  
FROM: Martin R. Cramton, Jr.

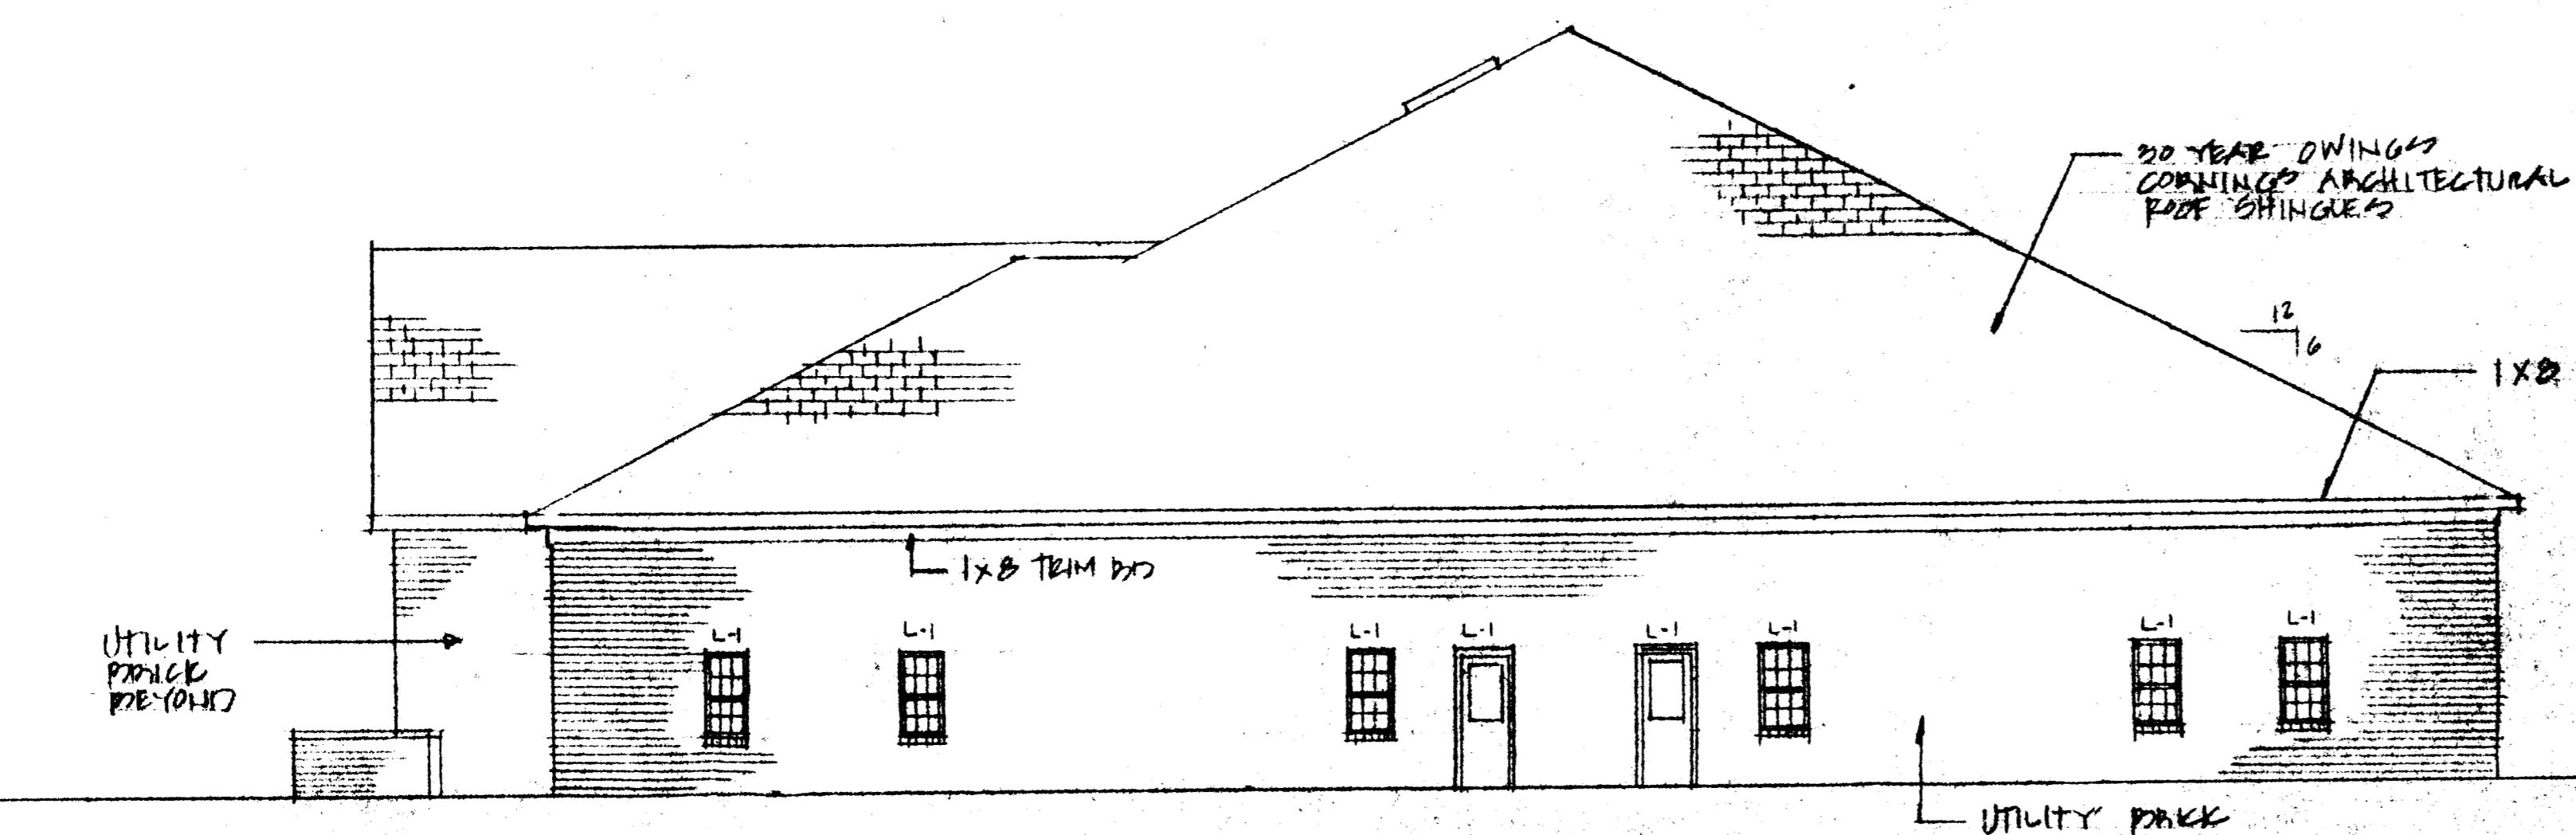

### RIGHT SIDE ELEVATION


SCALE  $\frac{1}{8}'' = 1'-0''$

#### NOTE

THE EXTERIOR BRICK & ROOF MATERIALS NEED TO BE THE SAME AS THE ADJACENT SHOPPING CENTER


#### BRICK LINTELS:

L-1:  $1\frac{3}{8}'' \times 3\frac{1}{2}'' \times 5\frac{1}{16}''$  UPTO  $5'-0''$  OPENING.  
L-2:  $1\frac{3}{4}'' \times 3\frac{1}{2}'' \times 5\frac{1}{16}''$  OVER  $5'-0''$  TO  $7'-0''$  OPENING  
DEAR 4" ON EACH END

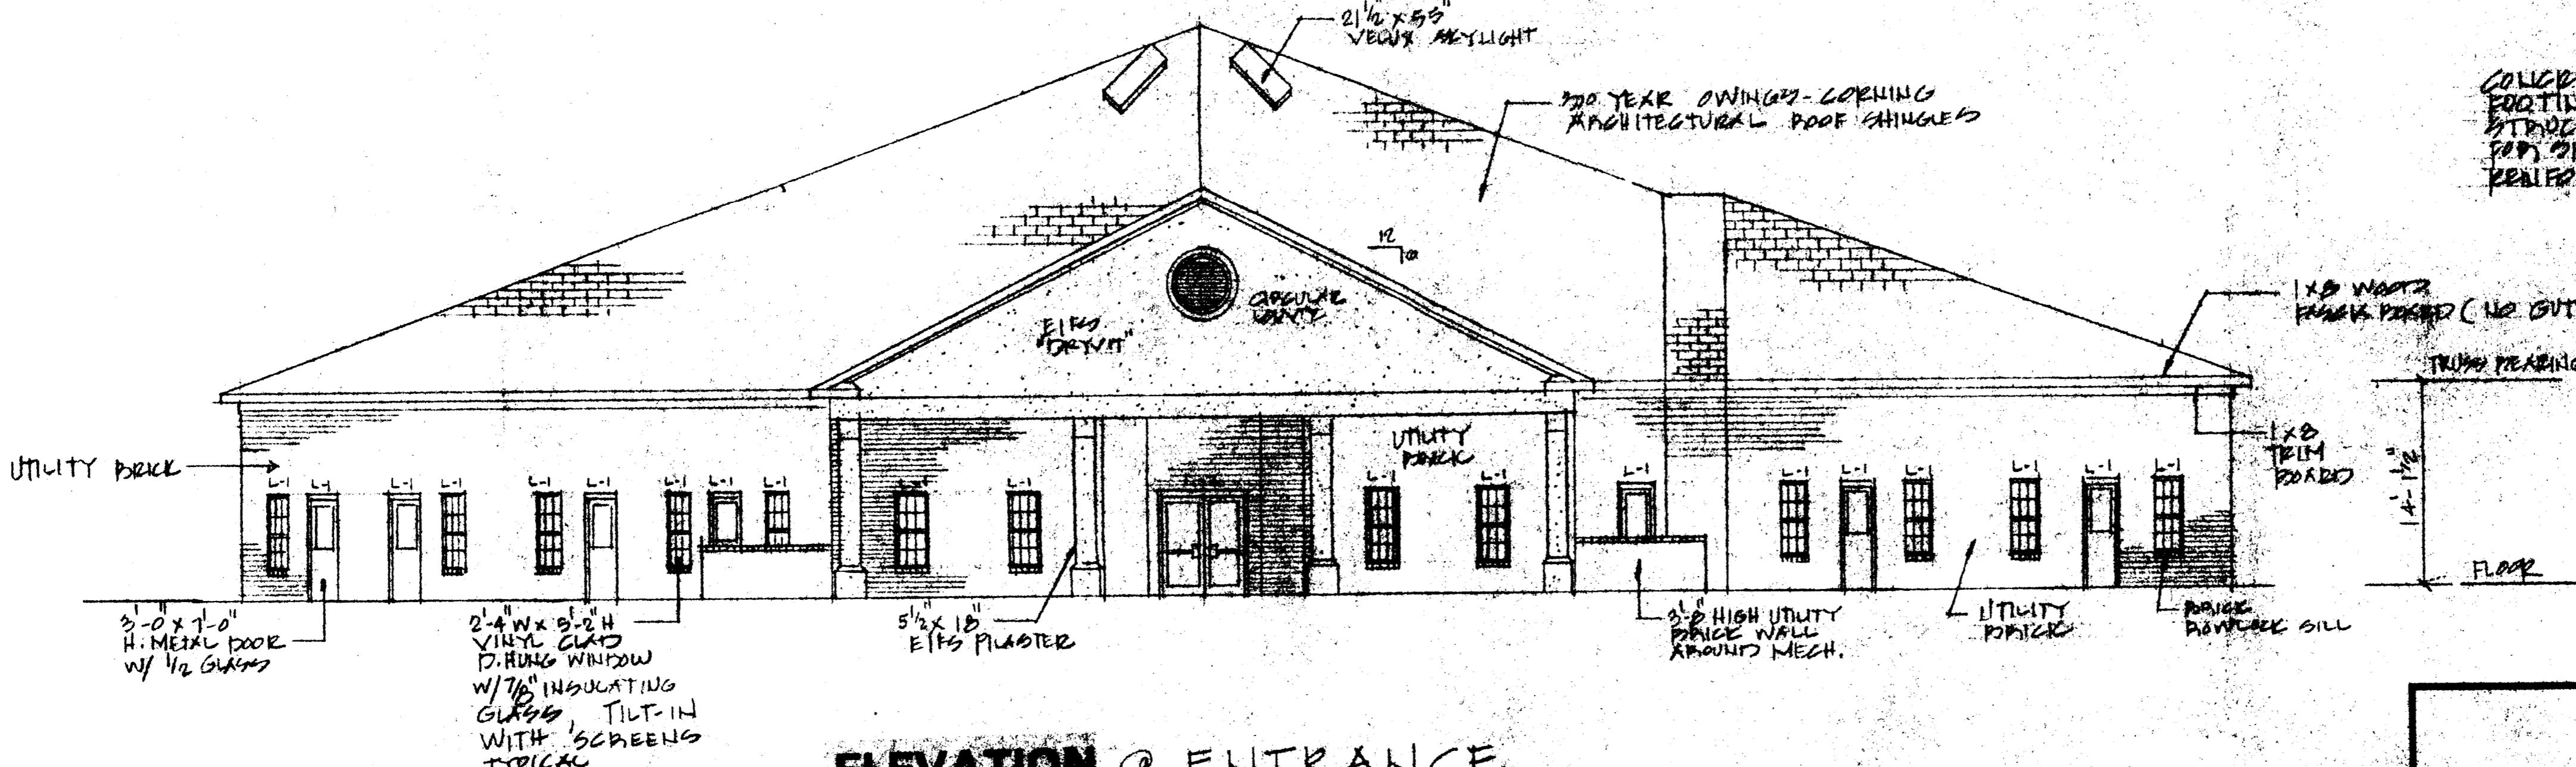

### ELEVATION @ ENTRANCE

SCALE  $\frac{1}{8}'' = 1'-0''$

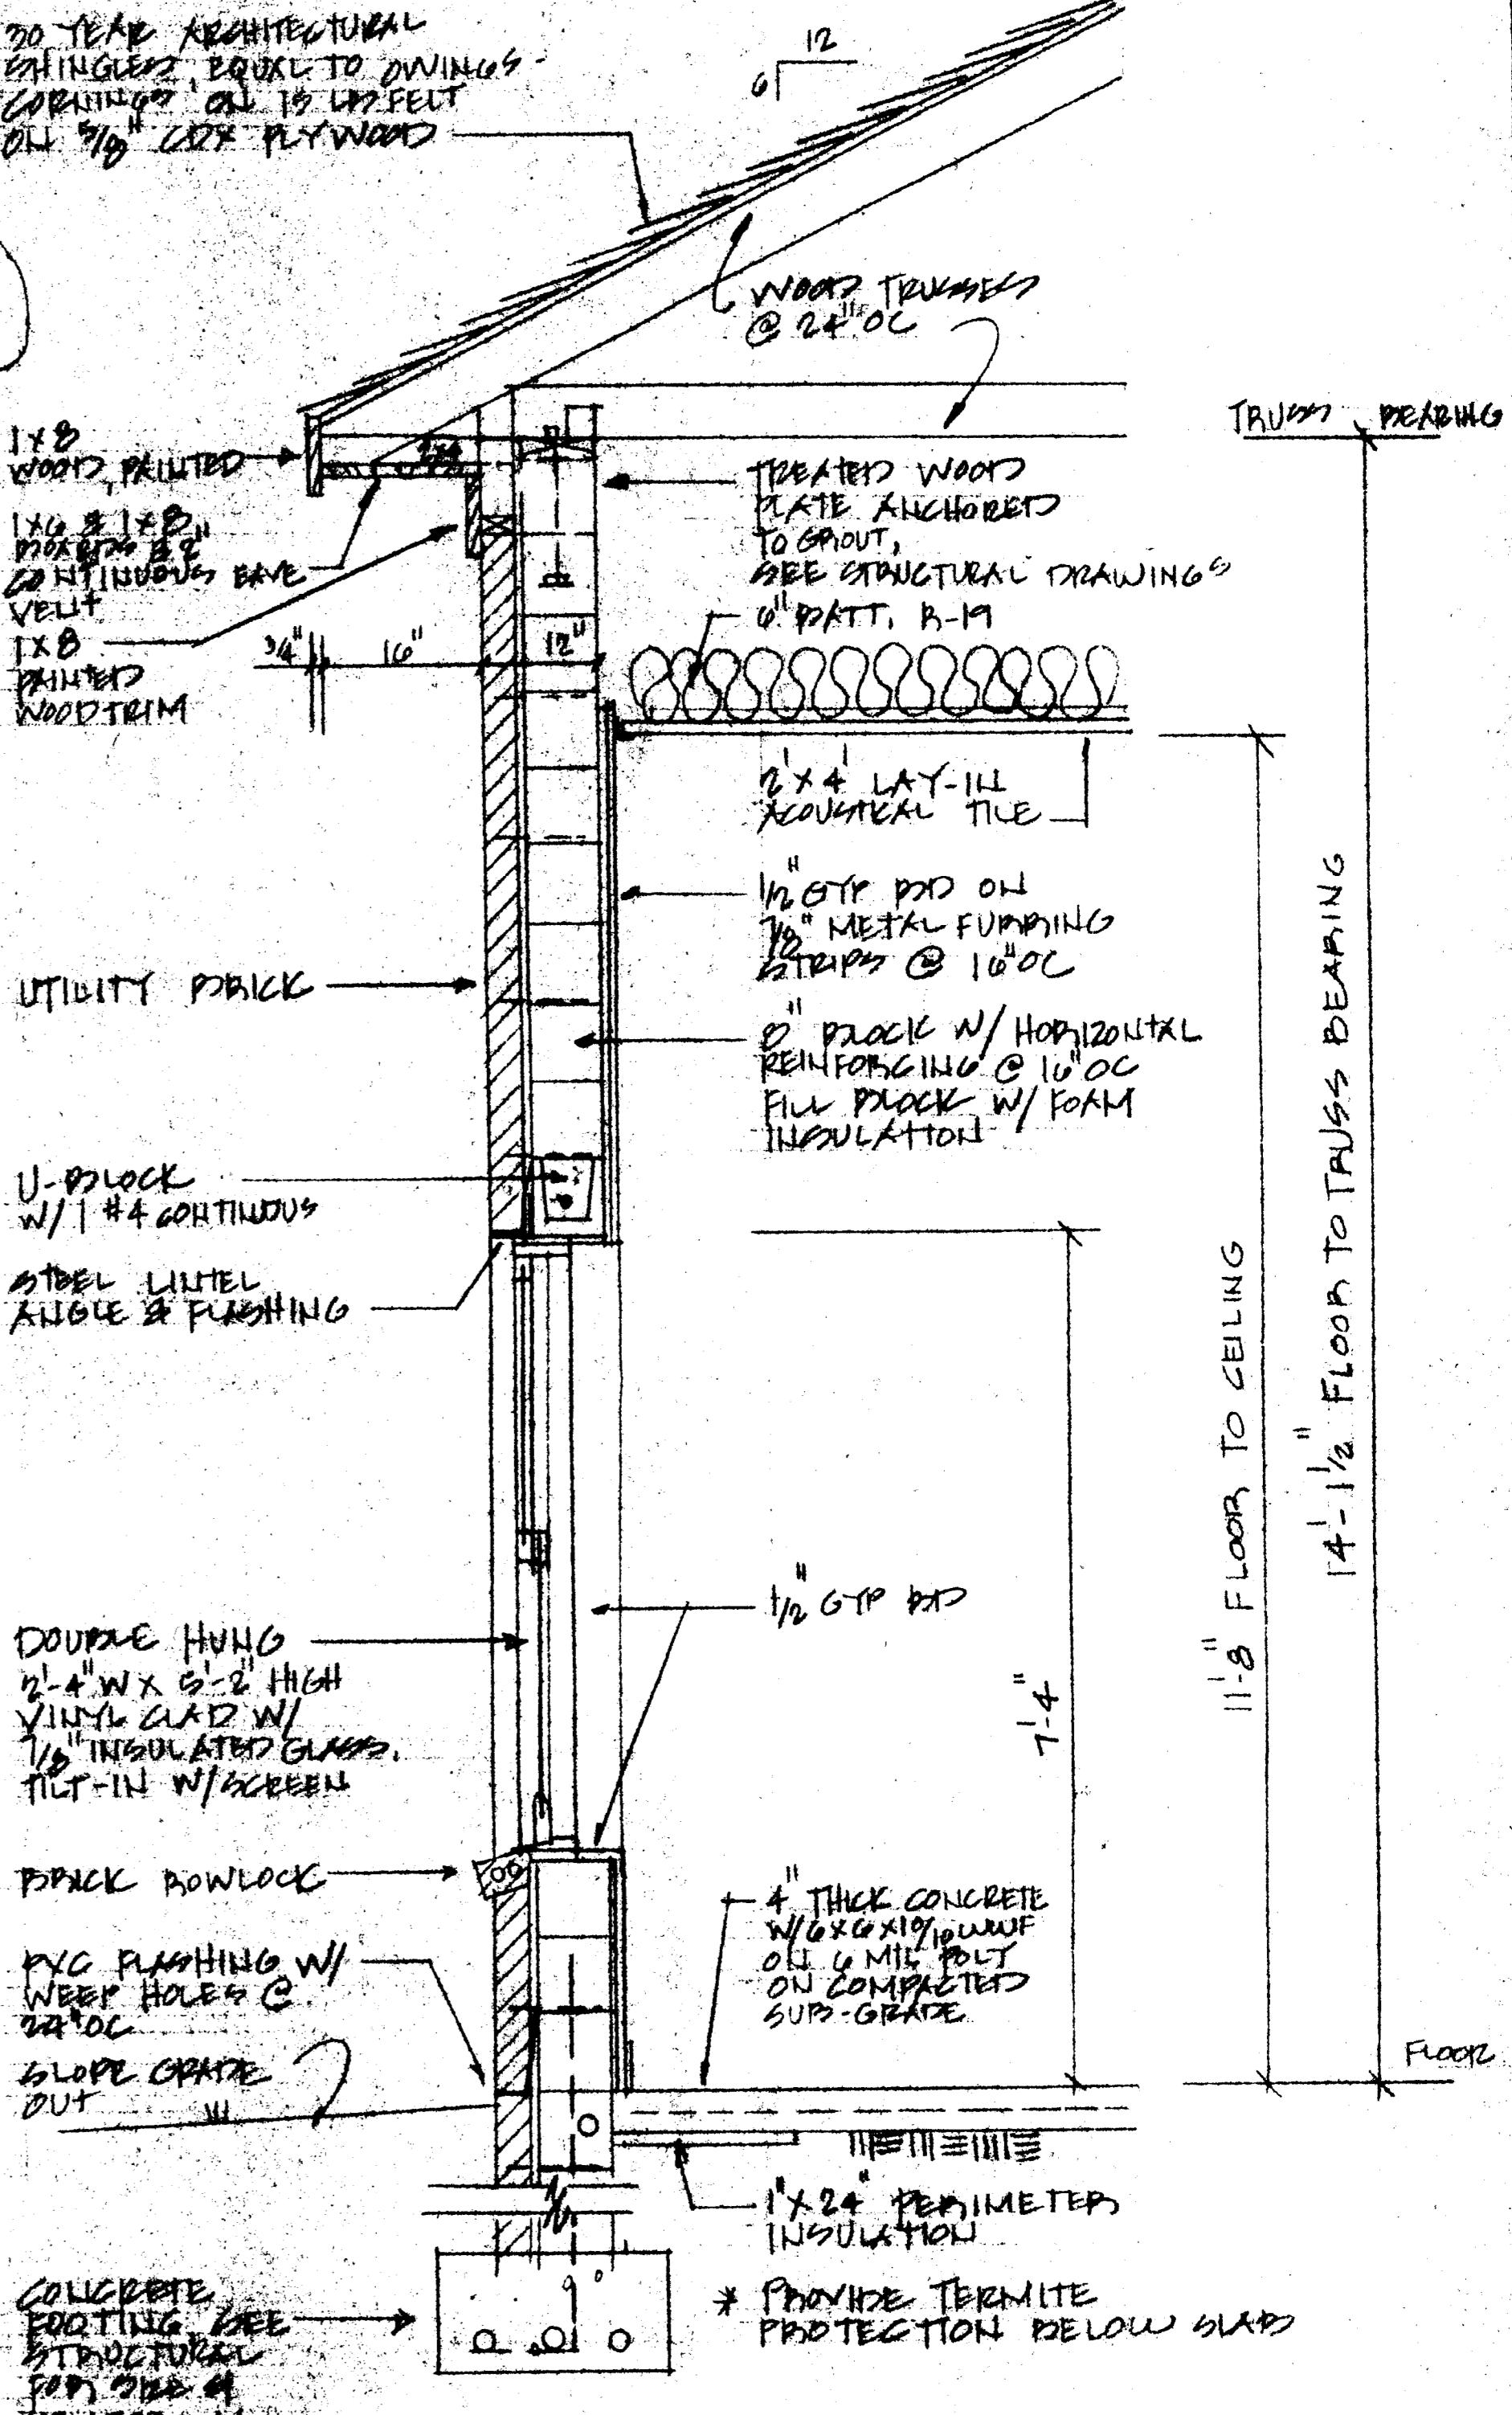

### TYPICAL WINDOW SECTION

Ted Richard Brown, AIA  
1119 Merrimont Court  
Matthews, North Carolina 28105  
Telephone: 704-846-4507 FAX: 704-846-5887

REVISIONS	Project	Drawing	
No.	Date	Charlotte, NC	Exterior Elevations
1	8/2/95	Owner	DAVIS CONSTRUCTION COMPANY, INC
		Scale	2208 W. Roosevelt Blvd., Monroe, N.C. 28110
		Date	Sheet No.
		Drafter	A-3
		Acad.	
		Check	

### TREE ORDINANCE NOTES:


1. PERIMETER PLANTING REQUIREMENTS:  
All properties are required to have a perimeter planting strip (not less than 10' wide) around the property line. Within this planting strip, trees shall be planted at a rate of one tree every 40 ft. Within the planting strip, trees shall be planted at a rate of one tree every 40 ft. If small matured trees are used at the perimeter, one tree every 30' is required. The minimum size required at the time of planting is two inches in diameter (DBH). If no DBH is provided, the minimum size required shall be at least 200 sq. ft. of root system from the public right-of-way.

2. INTERNAL PLANTING REQUIREMENTS:  
In addition to perimeter planting requirements, internal tree planting may be required. If the property contains a paved area of 10,000 sq. ft. or more, one tree every 100 sq. ft. of paved area is required. Tree planting is required to be one tree every 10,000 sq. ft. in improved areas, and areas where no trees are present. No trees shall be planted within 10' from a tree. Trees shall be planted in areas where the root system must be at least 200 sq. ft. of root system.

3. REPLACEMENT AND PROTECTION OF TREE:  
Trees within the tree protection zone (as per the general notes above), the property owner shall be responsible for the replacement of any tree(s) which are removed without a permit. This does not include single-family buildings. When applying for a permit for a new building, the property owner shall provide a plan showing how the new building will not damage existing trees. The property owner shall be responsible for the protection of any tree(s) within the tree protection zone. This should include grading changes, location of structures (earthen and non-earthen), sediment retention structures, drainage pipes and structures, sanitary sewer lines, parking areas and underground utilities.

4. TREE SURVEY AND PROTECTION PLANS:  
Trees within the tree protection zone (as per the general notes above), the property owner shall be responsible for the survey and protection of any tree(s) which are removed without a permit. This does not include single-family buildings. When applying for a permit for a new building, the property owner shall provide a plan showing how the new building will not damage existing trees. The property owner shall be responsible for the protection of any tree(s) within the tree protection zone. This should include grading changes, location of structures (earthen and non-earthen), sediment retention structures, drainage pipes and structures, sanitary sewer lines, parking areas and underground utilities.

DBH = 4" ABOVE GROUND  
GENERAL TREE NOTES:  
1. MINIMUM TREE SIZE FOR PLANTING IS 1" DBH CALIBER. IF TALL OR SINGLE TRUNK, MINIMUM HEIGHT AND SYSTEMS MAXIMUM DIA. OF TREE MULCH IS REQUIRED; STAKING/BUCKLING IS OPTIONAL.  
2. THE NUMBER OF TREES TO BE PLANTED IS BASED ON THE CHOICE FROM CITY OF CHARLOTTE'S APPROVED TREE LIST FOUND IN APPENDIX C OF THE CITY OF CHARLOTTE ZONING ORDINANCE.  
3. NO SOIL DISTURBANCE OR COMPACTION, CONSTRUCTION MATERIALS, TIE-OFFS, ETC., SHALL BE PLACED ON A TREE.  
4. TREE PROTECTION BARACADES MUST BE ERECTED BEFORE ANY GRAZING/COVETURE WORK IS PERFORMED ON THE PROPERTY.  
5. TREE PROTECTION BARACADES MUST MEET OR EXCEED CITY OF CHARLOTTE ZONING ORDINANCE REQUIREMENTS.  
6. WIRE BASKETS AND STRAPPING MUST BE CUT AWAY AND REMOVED FROM THE GROUND.  
7. CUT AWAY OR ROLL BACK TOP 12" OF BURLAP FROM ROOT BALL.  
GENERAL NOTES - Single-trunk:  
1. All trees are to be sturdy green, healthy and full (2 & 3) preferred. Minimum tree size is 2" caliper.  
2. Roots are to be removed from the root ball. After removal, roots are to be placed in a bucket of water until ready to plant.  
3. Roots are to be washed off the root ball. For smaller, no-pine needles or coarse mulch.  
4. Wrap tree trunk in burlap with burlap or tree wrap paper (optional). Wrap over any cut or rough areas.  
5. Staking is optional. Rubber bands or wire are for staking as recommended. Was or rope is to be used for staking. Burlap or tree wrap paper is to be used for covering the tree.  
6. Wrap tree trunk in burlap or tree wrap paper (optional).  
7. All trees shall come American Standard for Mercury Stock (ASME, 1990, Part 1, Grade and Planning Tree). For example: 2" caliper, 100' tall, 100' spread, 100' height, 100' width, 100' depth.

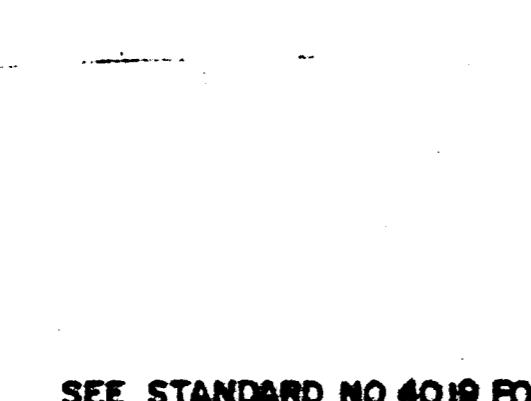

### REQUIRED HANDICAPPED READING SIGN ASSEMBLY

ALL HANDICAPPED SIGNS (R7-8) SHALL BE MOUNTED AT 7 FEET FROM GRADE TO BOTTOM EDGE OF SIGN FACE (MUTCD). MOUNTING HEIGHT CAN BE REDUCED TO 5 FEET IF PLACED BETWEEN SIDEWALK AND BUILDING FACE.

### HANDICAPPED SIGN DETAIL

#### 4.8 Ramps:

4.8.1 General. Any part of an accessible route with a slope greater than 1:12 should be considered a ramp and shall comply with 4.8.

4.8.2 Steps and Ramps. The least possible number of steps should be used. If more than three steps or a ramp in any construction shall be used, the ramp should be 1:12. The maximum rise for any run shall be 30 in (750 mm). The maximum rise for any ramp shall be 36 in (900 mm). Ramps should be constructed on existing sites or at a minimum, on new construction, slopes and rises as shown in 4.8.3(b)(2) if space constraints prohibit the use of 4.8.1(b).

4.8.3 Clear Widths. The minimum clear width of a ramp shall be 36 in (915 mm).

4.8.4 Landings. Ramps shall have level landings at corners and top of each ramp and shall be 36 in (915 mm) wide. Landings shall be 36 in (915 mm) wide.

(1) The landing shall be at least as wide as the ramp (Fig. 4.8.4).

(2) The landing length shall be a minimum of 60 in (1520 mm).

(3) The ramp clearance at landings, the minimum height of which shall be 60 in (1520 mm) wide.

4.8.5 A canopy is located at a landing. The total width of the doorway shall comply with 4.8.1(a).


4.8.6 Cross Slope and Smoothness. The cross slope of ramp surfaces should be no greater than 1:12. The smoothness of ramp surfaces should be no greater than 1:8.

4.8.7 Railing Requirements. Handrails and toe rails shall have vertical, railings or projecting surfaces that prevent people from slipping or falling. Handrails shall be a minimum of 3.50 in (90 mm) high (see Fig. 4.8.7).

4.8.8 Outrigger Definitions. Outrigger ramps and their applications shall be designed so that users will not interfere with walking surfaces.

GENERAL NOTES - Single-trunk:  
1. All trees are to be sturdy green, healthy and full (2 & 3) preferred. Minimum tree size is 2" caliper.  
2. Roots are to be removed from the root ball. After removal, roots are to be placed in a bucket of water until ready to plant.  
3. Roots are to be washed off the root ball. For smaller, no-pine needles or coarse mulch.  
4. Wrap tree trunk in burlap with burlap or tree wrap paper (optional). Wrap over any cut or rough areas.  
5. Staking is optional. Rubber bands or wire are for staking as recommended. Was or rope is to be used for staking. Burlap or tree wrap paper is to be used for covering the tree.  
6. Wrap tree trunk in burlap or tree wrap paper (optional).  
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### APPENDIX 2 CLASSICAL DRIVELINE SINGLE STRUCTURE

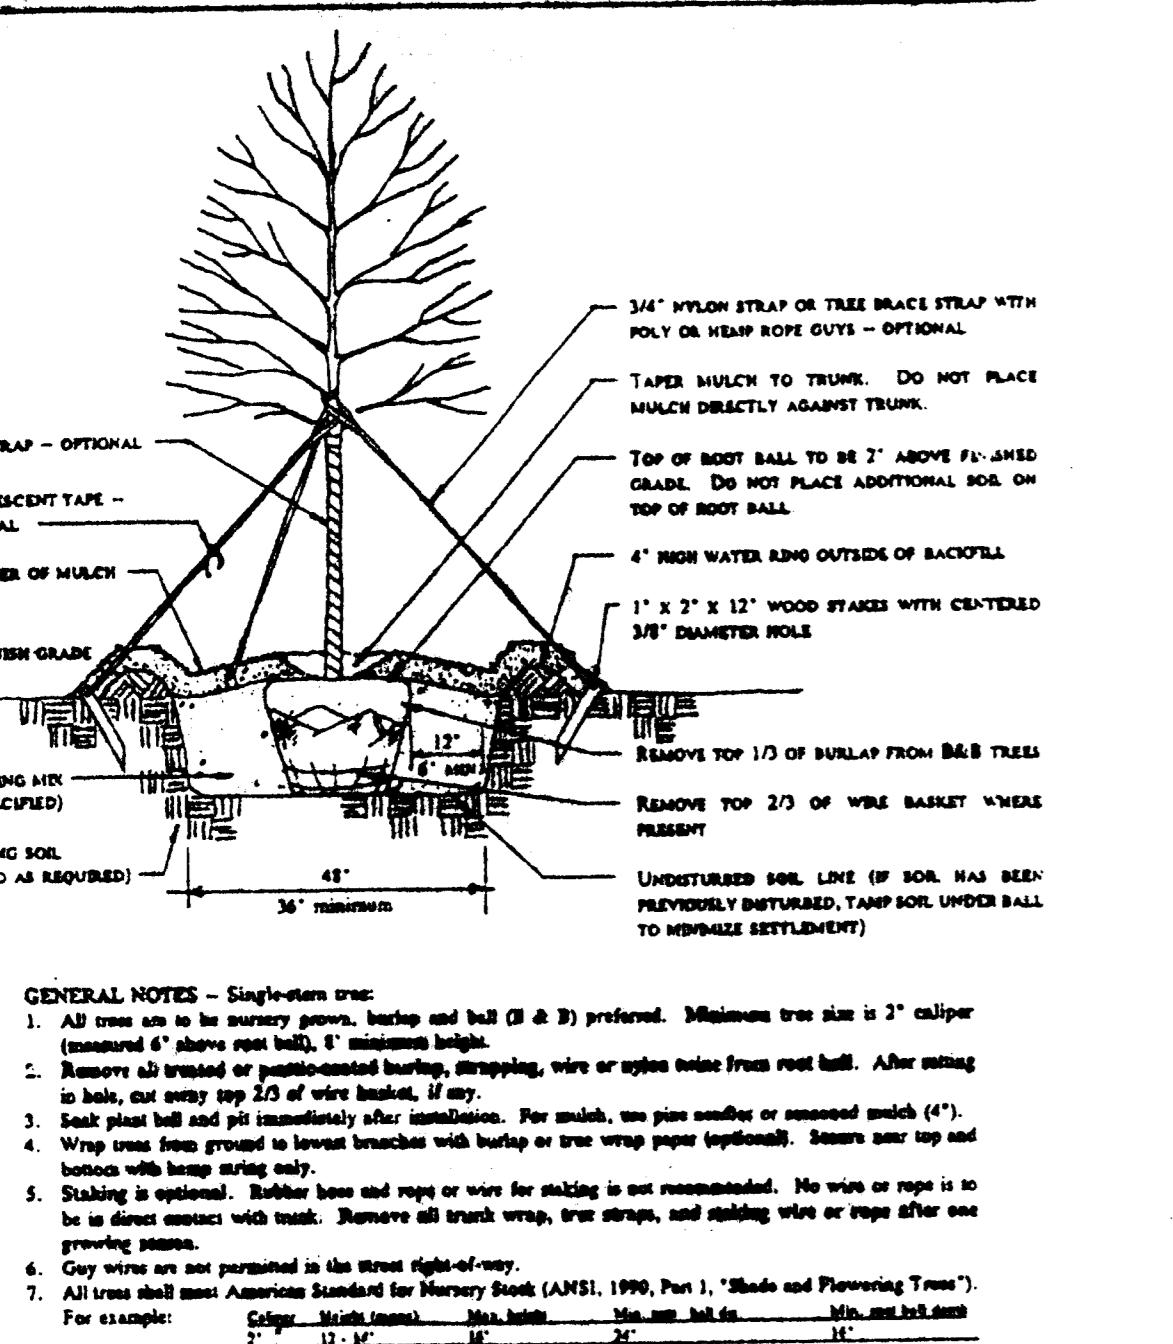

### DUMPSTER PAD SCREENING

Any fence or wall shall be constructed in a durable fashion of brick, stone, other masonry materials or wood posts and planks or any combination of such materials. No more than 25 percent of the fence surface shall be left open and the finished side of the fence shall face the abutting property;

CURVE LENGTH	RADIUS	DIRECTION	CHORD
C1 269.31'	445.00'	N03°31'36" W	265.22'
C2 275.81'	320.00'	S01°11'30" W	271.77'
C3 346.67'	1320.00'	S21°34'35" W	316.67'
C4 236.80'	1380.00'	S24°05'33" W	238.30'
C5 236.80'	1380.00'	S24°05'33" W	238.30'
C6 85.66'	251.03'	S67°22'08" E	85.24'
C7 29.30'	40.00'	S56°36'31" E	29.65'
C8 244.63'	1320.00'	S23°47'27" W	244.28'

LINE	DIRECTION	DISTANCE
L1	N13°49'40" W	22.47'
L2	S11°13'30" E	13.81'
L3	N52°51'19" E	18.49'
L4	S47°51'57" E	18.49'
L5	S47°51'57" E	18.49'
L6	N05°53'45" E	18.45'
L7	N05°53'45" E	18.08'
L8	N76°34'05" E	18.82'
L9	N12°24'22" E	23.66'
L10	S07°31'17" E	20.77'

CURVE LENGTH	RADIUS	DIRECTION	CHORD
C9 8.16'	11.71'	N43°48'26" E	8.00'
C10 42.87'	36.85'	N22°58'36" E	40.49'
C11 19.51'	36.85'	S22°58'36" E	19.51'
C12 49.44'	102.44'	N05°24'45" E	44.82'
C13 24.66'	13.15'	N10°45'37" E	21.20'
C14 102.04'	1320.00'	S10°18'32" E	102.04'

### MUTCD

R7-8

12" x 16"

MUTCD

R7-9

12" x 9"

MUTCD

R7-10

12" x 9"

### SEE STANDARD NO 4Q19 FOR SUPPLEMENTAL SIGN DETAIL

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### MUTCD

R7-8

12" x 16"

MUTCD

R7-9

12" x 9"

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R7-10

12" x 9"

### SEE STANDARD NO 4Q19 FOR SUPPLEMENTAL SIGN DETAIL

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