+

CHARLOTTE-MECKLENBURG PLANNING COMMISSION

INTER - OFFICE COMMUNICATION

DATE:

October 14, 1997

TO: Robe

Robert Brandon

Zoning Administrator


FROM:


Martin R. Cramton, Jr.

Planning Director

SUBJECT: Administrative Approval for Petition No. 97-25 Seaboard Realty, Inc. Tax Parcel # 047-

Attached is revised plan for the above mentioned rezoning petition. The plan has been revised to allow a portion of the site along the Western property line to be sold to First Union National Bank for the expansion of there existing drive-thru windows. The revised plan maintains the required yards and the required number of parking spaces within parcel "X". Since this change is minor and does not intensify development on the site we are administratively approving this revised plan. Please use this revised plan when evaluating requests for building permits and certificates of occupancy.

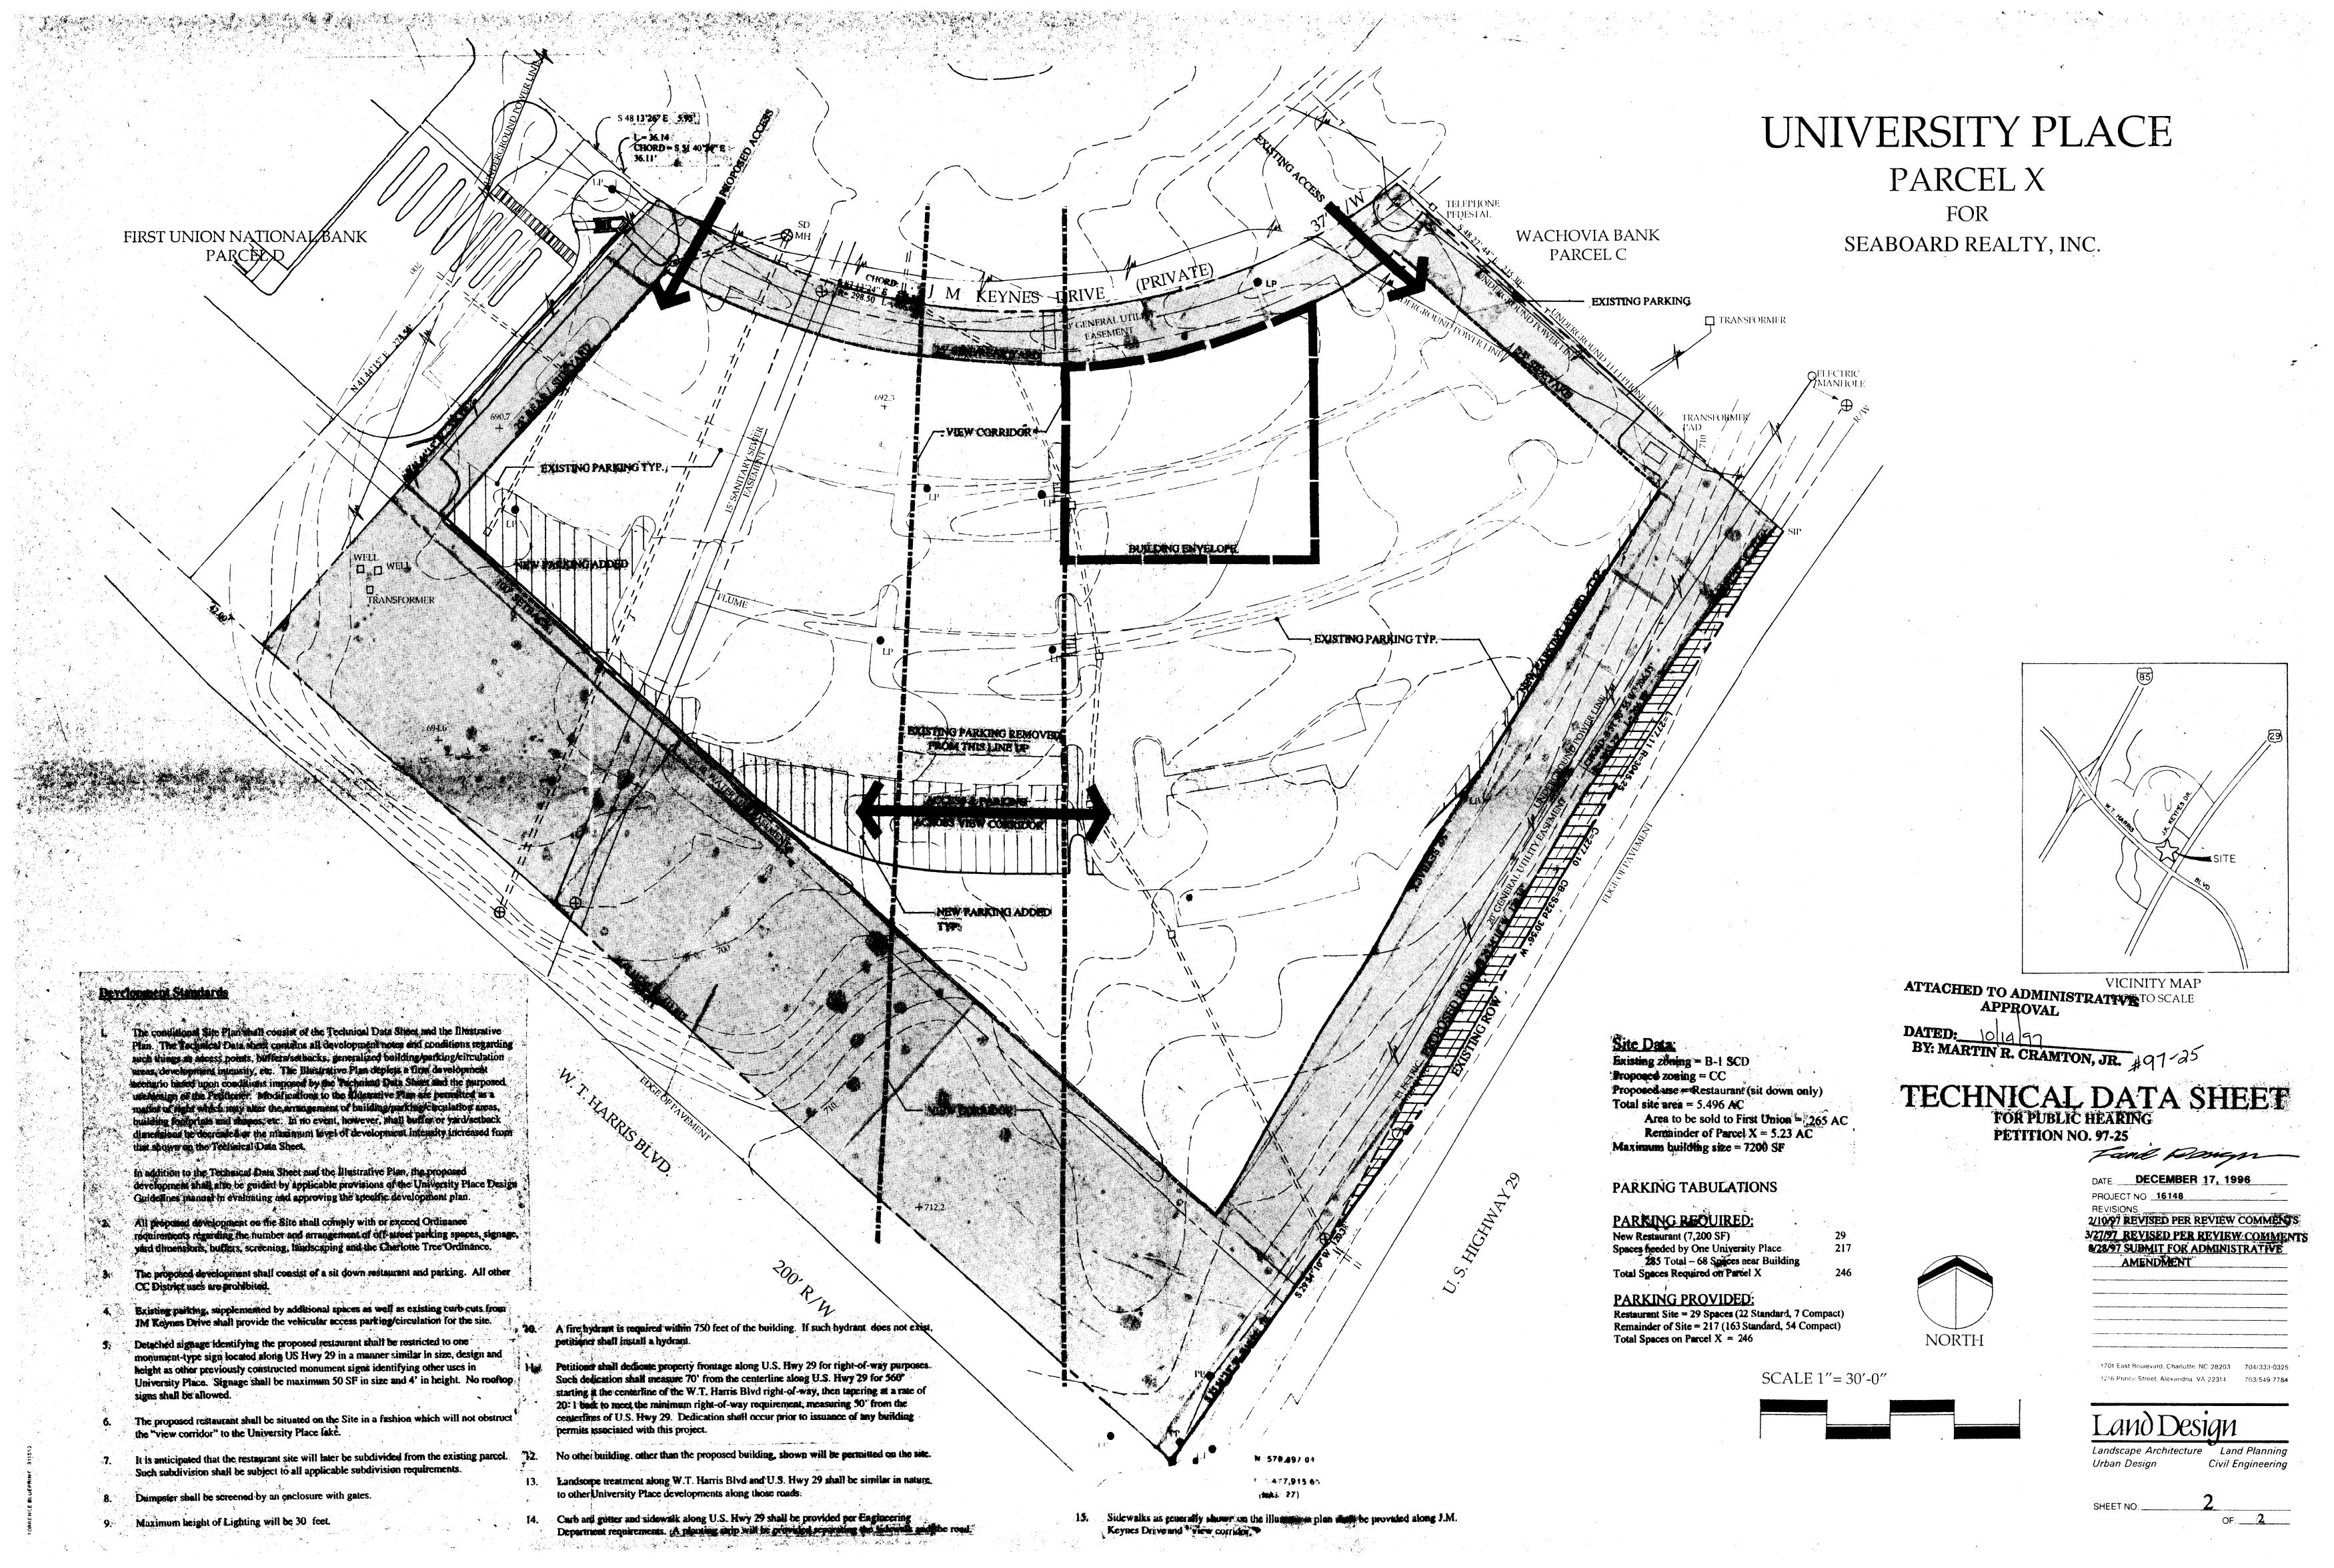


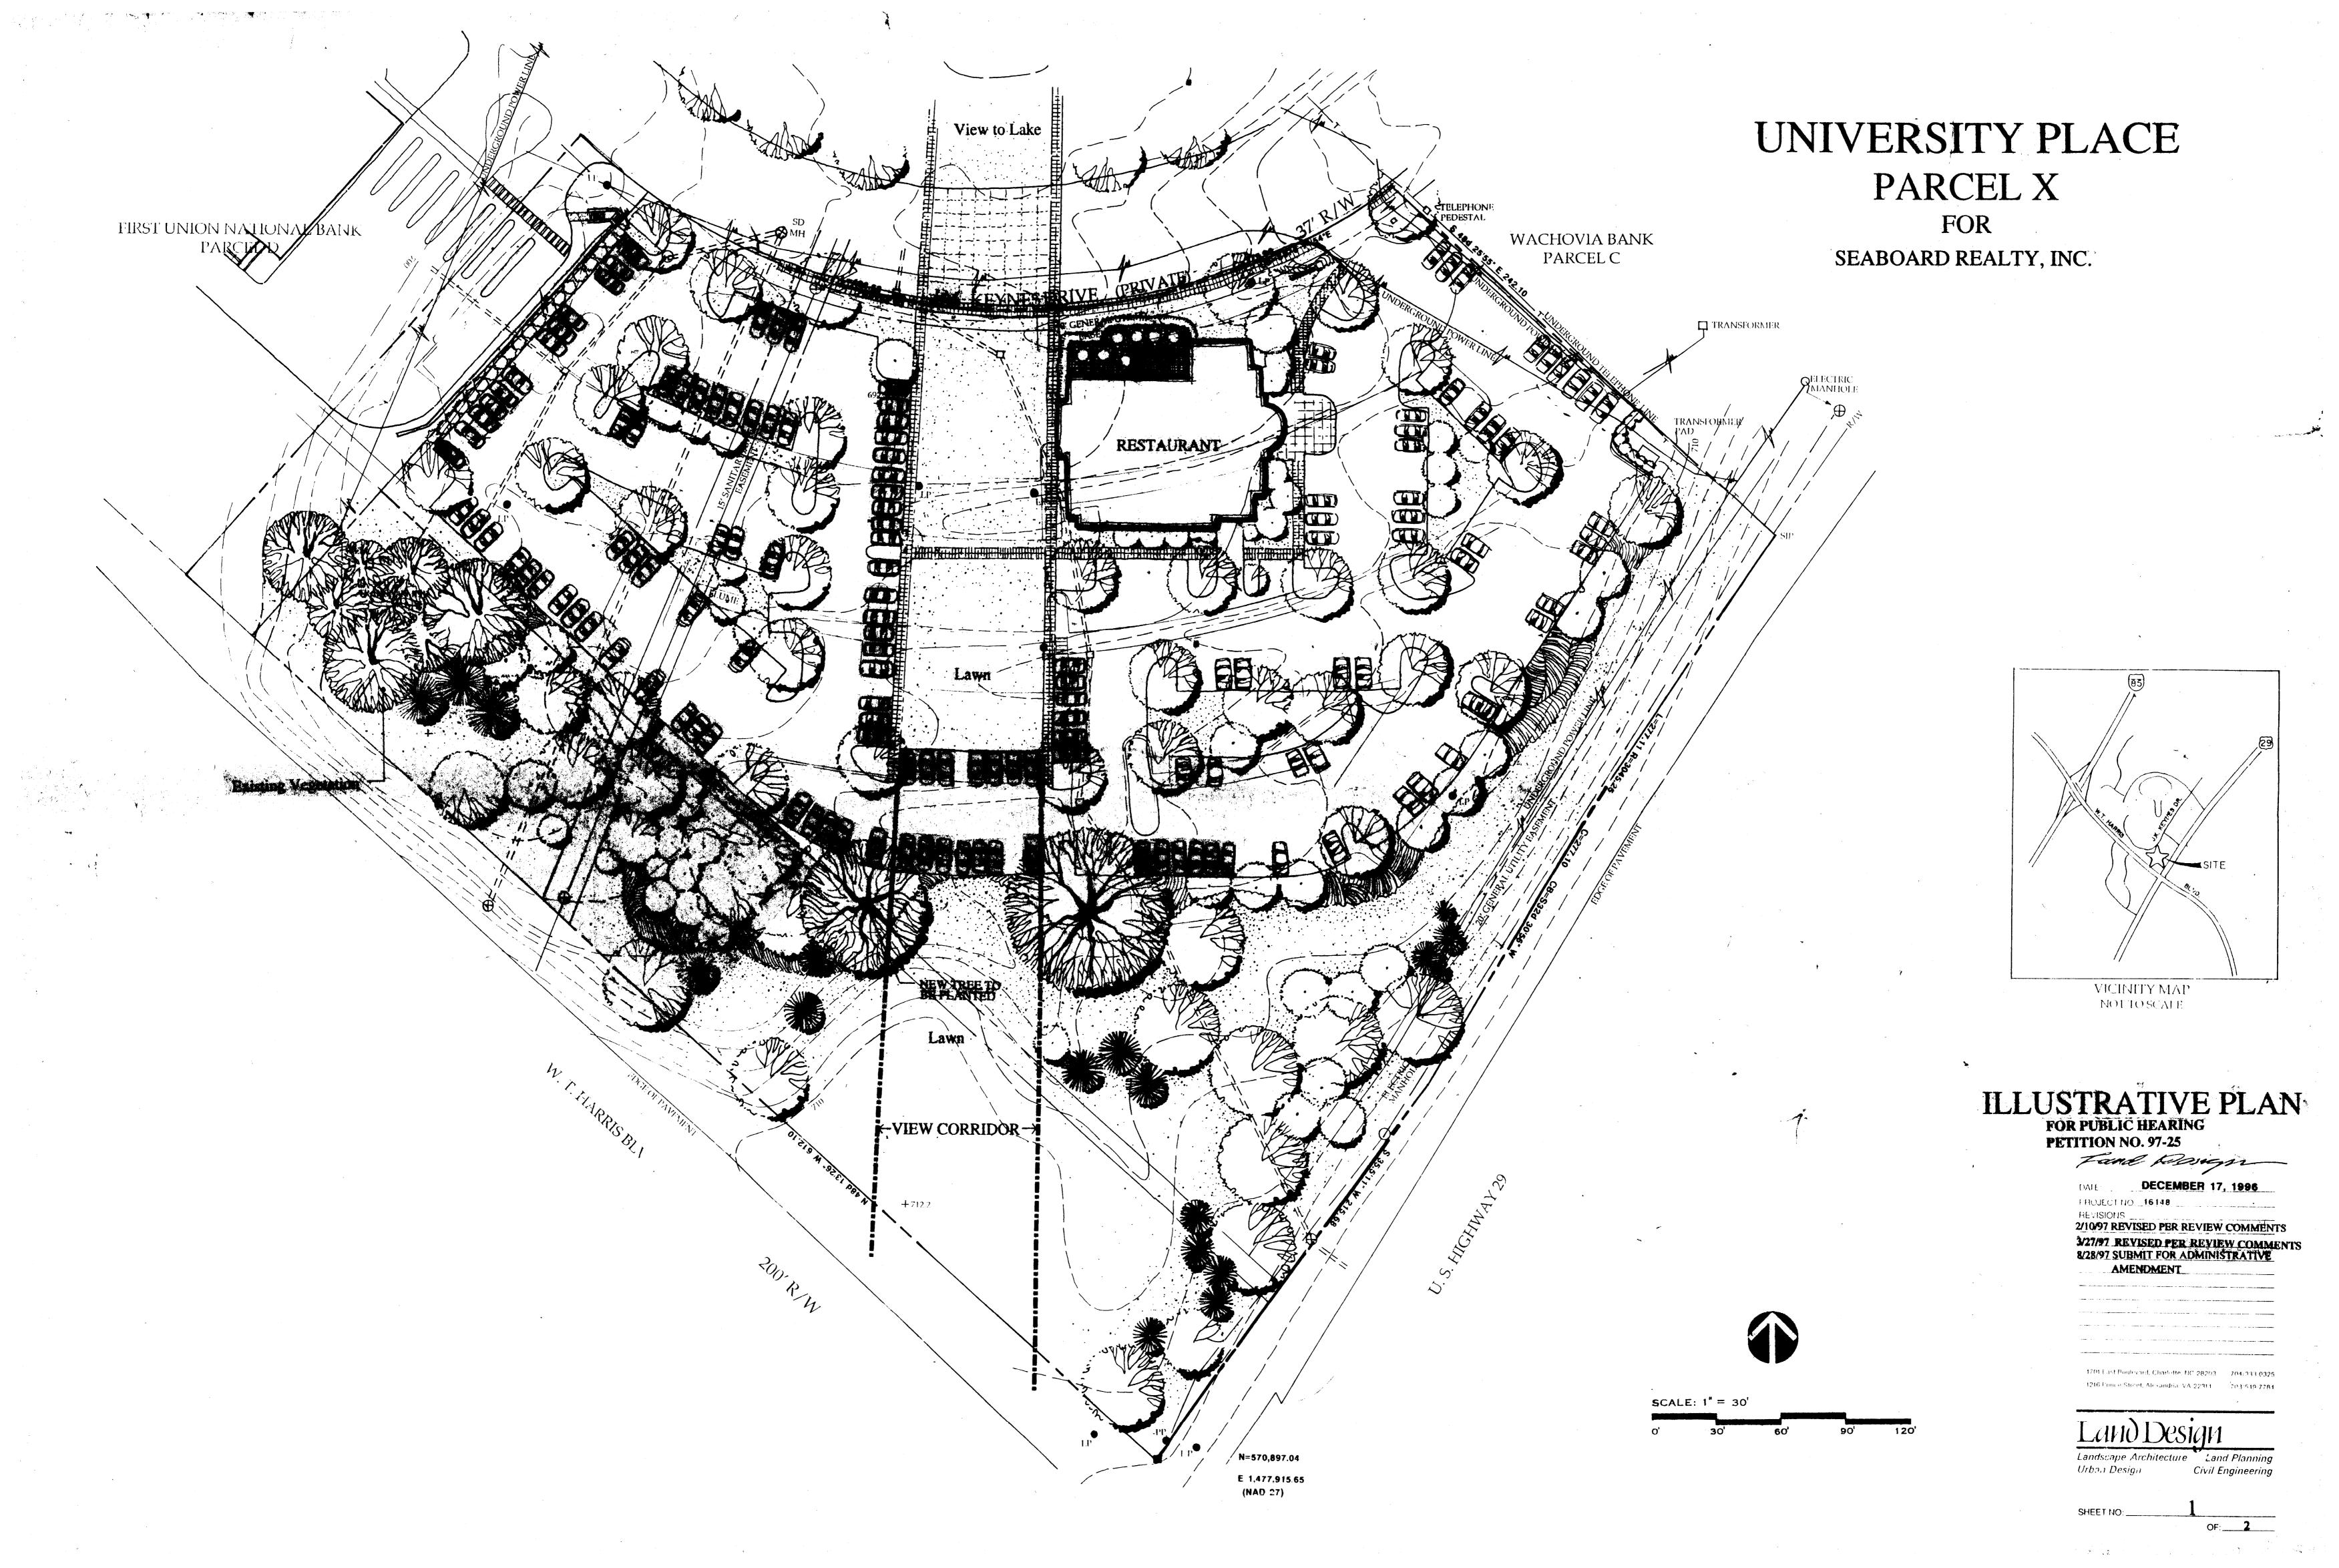




FIRST UNION NATIONAL BANK

UNIVERSITY PLACE BRANCH RENOVATIONS 8700 J. M. KEYNES DRIVE CHARLOTTE, NORTH CAROLINA 28213

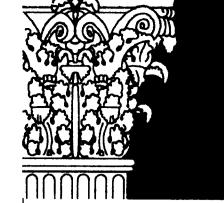

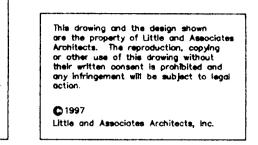

Index of drawings

C-1 SITE PLAN C-2- SITE CRADING PLAN C-3- EXIST. REFERENCE ELEVATIONS C-4- EXIST. REFERENCE ELEVATIONS C-5- SITE CRADING PLAN C-5- SITE CRADING PLAN C-6- SITE CRADING PLAN C-7- EXIST. REFERENCE ELEVATIONS C-7- EXIST. REFERENCE ELEVATIONS C-7- EXIST. REFERENCE ELEVATIONS C-7- EXIST. REFERENCE ELEVATIONS C-7- EXIST. REFERENCE FOATOMS
D-1 DEVOLITION FLOOR PLAN A-1 FLOOR PLAN A-2 REFLECTED CEILING PLAN A-3 ROOF PLAN A-4 ELEVATIONS A-5 FLEVATIONS A-6 WALL SECTIONS ATTACHED TO ADMINISTRATI APPROVAL DATED.
A-2 REFLECTED CEIL'NG PLAN A-3 ROOF PLAN A-4 ELEVATIONS A-5 ELEVATIONS A-6 WALL SECTIONS ATTACHED TO ADMINISTRATI APPROVAL DATED.
DATED:
BY: MARTIN'R. CRAMTON, JE
BE-2 BANK EQUIPMENT

THERMAL ENVELOPE

METHOD OF COMPLIANCE

APPENDIX B				
BUILDING CODE SUMMARY				
FOR ALL COMMERCIAL PROJECTS				
Name of Project: First Union National Bank Renovations				

Address: 8700 J. M. keynes Drive, Charlotte, NC 28213

DESIGNER OF RECOR	RD:		
DESIGNER	NAME	LICENSE#	TELEPHONE#
Architectural	N. Everhart	/5953	(704) 525-6350
Electrical	M. Reitterer	/19586	(704) 525-6350
Plumbing	N/A	/	•
Mechanical	N/A	_ /	•
Structural	J. Armfield	/6506	(704) 525 - 6350
Sprinkler-Standpipe	N/A	_ /	•
Fire Alarm	N/A	_ /	·
Other (Civil)	F. Craig	/17596	(704) 334-5348

Mezzanine: Yes / No High Rise? Yes / No

BUILDING DATA Occupancy: Assembly Business DEducational ☐Mercantile ☐Hazardous ☐Factory—Industrial □Institutional (unrestrained) □Institutional (restrained) Úse Condition □Residential □ Storage Mixed Occupancy? Yes /(No) Separation:_____ Hr. Construction Type: $|\Box ||\Box ||\Box ||V(P)\Box |V(UP)\Box |V(P)\Box$ V(UP) ☐ VI(P) ☐ VI(UP) ■ Mixed Construction No Yes/No Type _____Existing: Type VI Fire District? Yes /(No)

Building Height: 28'-0"± Feet _____1 Number of Stories

Gross Building Are (Foot			(=	oot Print)
Floor Sq. Basement N 1st Floor 4,897 2nd Floor 3rd Floor	Ft. I/A existing	4th F 5th F 6th F 7th F	loor loor	Sq. Ft.
Total Area Increase? If yes, calculation	Yes / (No			sq. ft.
FIRE RESISTANCE	Required			Design No. for Rated Assemblies ⁵ (unrestrained)
Exterior Bearing Wal North East West South Exterior Non-bearing Wa North East West	lls: N/A			
Interior Walls: Bearing Non—bearing Ceiling—Floor Assemb Beams: Columns: Ceiling—Roof Assemb Vertical Shafts: 4 Chases—P.E.M.: Mixed Occupancy Separat Tenant Separation	ol <u>y:</u>		for Kate Penetratio	No.Design No. ed for Rated ons ⁵ Assemblies ons (unrestrained)

LIFE SAFETY SYSTEM: Emergency Lighting and Exit Signs Yes/No_Yes_ Fire Alarm and Smoke Detections Systems Yes/No No Yes/No_No Panic Hardware EXIT REQUIREMENTS: N/A Dead end limit-maximum condition 20 Fee Travel distance to exit-maximum condition 2 Number of exits: Total Square footage of floor 4,897 divided net/sq. ft. per occupancy 100 = 49 Tota of people on floor. Number of doors provided_ Number of doors required ____ FOOTNOTES: 1. Rea'd if wall to property line or assumed line

- 3. Identify code section when using any special exceptions, etc. 4. Stairs, elevators and/or atriums. 5. Details or reproductions of rated assemblies/
- penetrations shall be incorporated on the draw DESIGN LOADS: Roof Live Load: 20 psf
 Wind: Zone 80 mph Importance Factor

wina: .	Zone <u>80</u> mpn	importance ractori
	VOLUME 1 Section 1606	ASCE-7 Exposure
Floor:	psf	

Snow:	10	_pst					
Seismic:	Zone	C	Av	0.10	Importance	Facto)r
					smic/Other)	<u> </u>	Vind
Method (of Res	istance:	(i.e.	Brace	d Frame/		
Moment	Frame	/Shear	Walls	s)	Braced	Frame	
Soil Bear	rina Co	nnacities	3.				

Son bearing capacities.	
Field Test (provide copy of test report) _	ps
Presumptive bearing capacity 3,000	psf
Pile size, type, and capacity	N/A
PARKING SPACES: 25 Required	<u>38</u> Provide

EXIT REQUIREMENTS: N/A Dead end limit-maximum condition	Description of assembly U-Value of total assembly. R-Value of insulation Skylights in each assembly. U-Value of skylight total square footage of skylights in each assembly. Exterior Walls (each Assembly) Description of assembly U-Value of total assembly. R-Value of insulation Openings (windows or doors with glazing).
 FOOTNOTES: Req'd if wall to property line or assumed line is less than 30 feet. All fire rated walls shall be identified on plans by hatching, shading, etc.; show legend. Identify code section when using any special exceptions, etc. Stairs, elevators and/or atriums. Details or reproductions of rated assemblies/penetrations shall be incorporated on the drawings. 	U-Value of assembly shading coefficient projection factor low e required, if applicable Door R-Value Walls adjacent to unconditioned space (each assembly) Description of assembly U-Value of total assembly R-Value of insulation Openings (windows or doors with glazing) U-Value of assembly shading coefficient projection factor low e required, if applicable .
DESIGN LOADS: Roof Live Load: psf Wind: Zone 80 mph	Walls below grade (each assembly) Description of assembly U-Value of total assembly. R-Value of insulation Floors over unconditioned space (each assembly)
Floor:psf Snow:10psf Seismic: Zone c Av0.10 Importance Factor 1 Lateral design Control: (Wind/Seismic/Other) Wind Method of Resistance: (i.e. Braced Frame/ Moment Frame/Shear Walls) Braced Frame Soil Bearing Capacities: Field Test (provide copy of test report) psf Presumptive bearing capacity3,000psf	Description of assembly U-Value of total assembly. R-Value of insulation Floors slab on grade Description of assembly U-Value of total assembly. R-Value of insulation Horizontal/vertical requirement. slab heated DESIGNER STATEMENT: To the best of my knowledge and belief, the design of this building complies with the thermal envelope requirements of the North Carolina State Building
Pile size, type, and capacity	Code, Volume X—Energy. ■ Volume 1—General Construction, Chapter 13. ☐ Signed: Name:

Thermal Zone:

Roof/ceiling assembly (each assembly) Description of assembly Code Allow. Mex. or Mit	and the said the said of the s
R-Value of total assembly. Skylights in each assembly.	Lighting schedule Code Allow, Max. or Mi
U-Value of skylight total square footage of skylights in each assembly. Exterior Walls (each Assembly) Description of assembly U-Value of total assembly. R-Value of insulation Openings (windows or doors with glazing). U-Value of assembly shading coefficient projection factor low e required, if applicable. Door R-Value	number of ballasts in fixture. total wattage per fixture. total interior wattage specified vs allowed. total exterior wattage specified vs allowed. Equipment schedules with motors(not used for mechanical system motor horsepower . number of phases . minimum efficiency . motor type .
Walls adjacent to unconditioned space (each assembly) Description of assembly U-Value of total assembly R-Value of insulation Openings (windows or doors with glazing) U-Value of assembly shading coefficient projection factor low e required, if applicable Door R-Value	DESIGNER STATEMENT: To the best of my knowledge and belief, the design of this building complies with the electrical system and equipment requirements of the North Carolina State Building Code, Volume X—Energy. Volume 1—General Construction, Chapter 13.
Walls below grade (each assembly)	MECHANICAL SYSTEMS, SERVICE SYSTEMS AND EQUIPMENT
Description of assembly	METHOD OF COMPLIANCE
Floors over unconditioned space (each assembly) Description of assembly U-Value of total assembly. R-Value of insulation	Thermal Zone Exterior design conditions winter dry bulb
Floors slab on grade Description of assembly U-Value of total assembly R-Value of insulation Horizontal/vertical requirement slab heated	Interior design conditions winter dry bulb . summer dry bulb.
DESIGNER STATEMENT: To the best of my knowledge and belief, the design of this building complies with the thermal envelope requirements of the North Carolina State Building Code, Volume X—Energy Volume 1—General Construction, Chapter 13. 5	Mechanical Spacing Conditioning System Unitary

Prescriptive 🔳 Performance 🗆 Energy Cost Budget 🗀

METHOD OF COMPLIANCE

heating efficiency cooling efficiency

heat output of unit

cooling output of unit

total boiler output, if oversized, state reason

chiller_	
tota	chiller capacity, if oversized, state reason.
List equ	pment efficiencies
Fauinma	at schodula with motors (machanisal automa)
	nt schedule with motors (mechanical systems)
motor i number	of phases
minima	n enciency.
1110101	.ype
# or po	les .
DESIGNE	R STATEMENT:
	t of my knowledge and belief, the design of this building complies
with the m	echanical systems, service systems and equipment requirements of
the North	Carolina State Building Code, Volume X—Energy.
	General Construction, Chapter 13. 🗆 🕆
Volume 1-	,
Volume 1— Signed:	General Construction, Chapter 13. []




REVISIONS


SET NUMBER

PROJECT NUMBER

5/10/97


04-1540-09

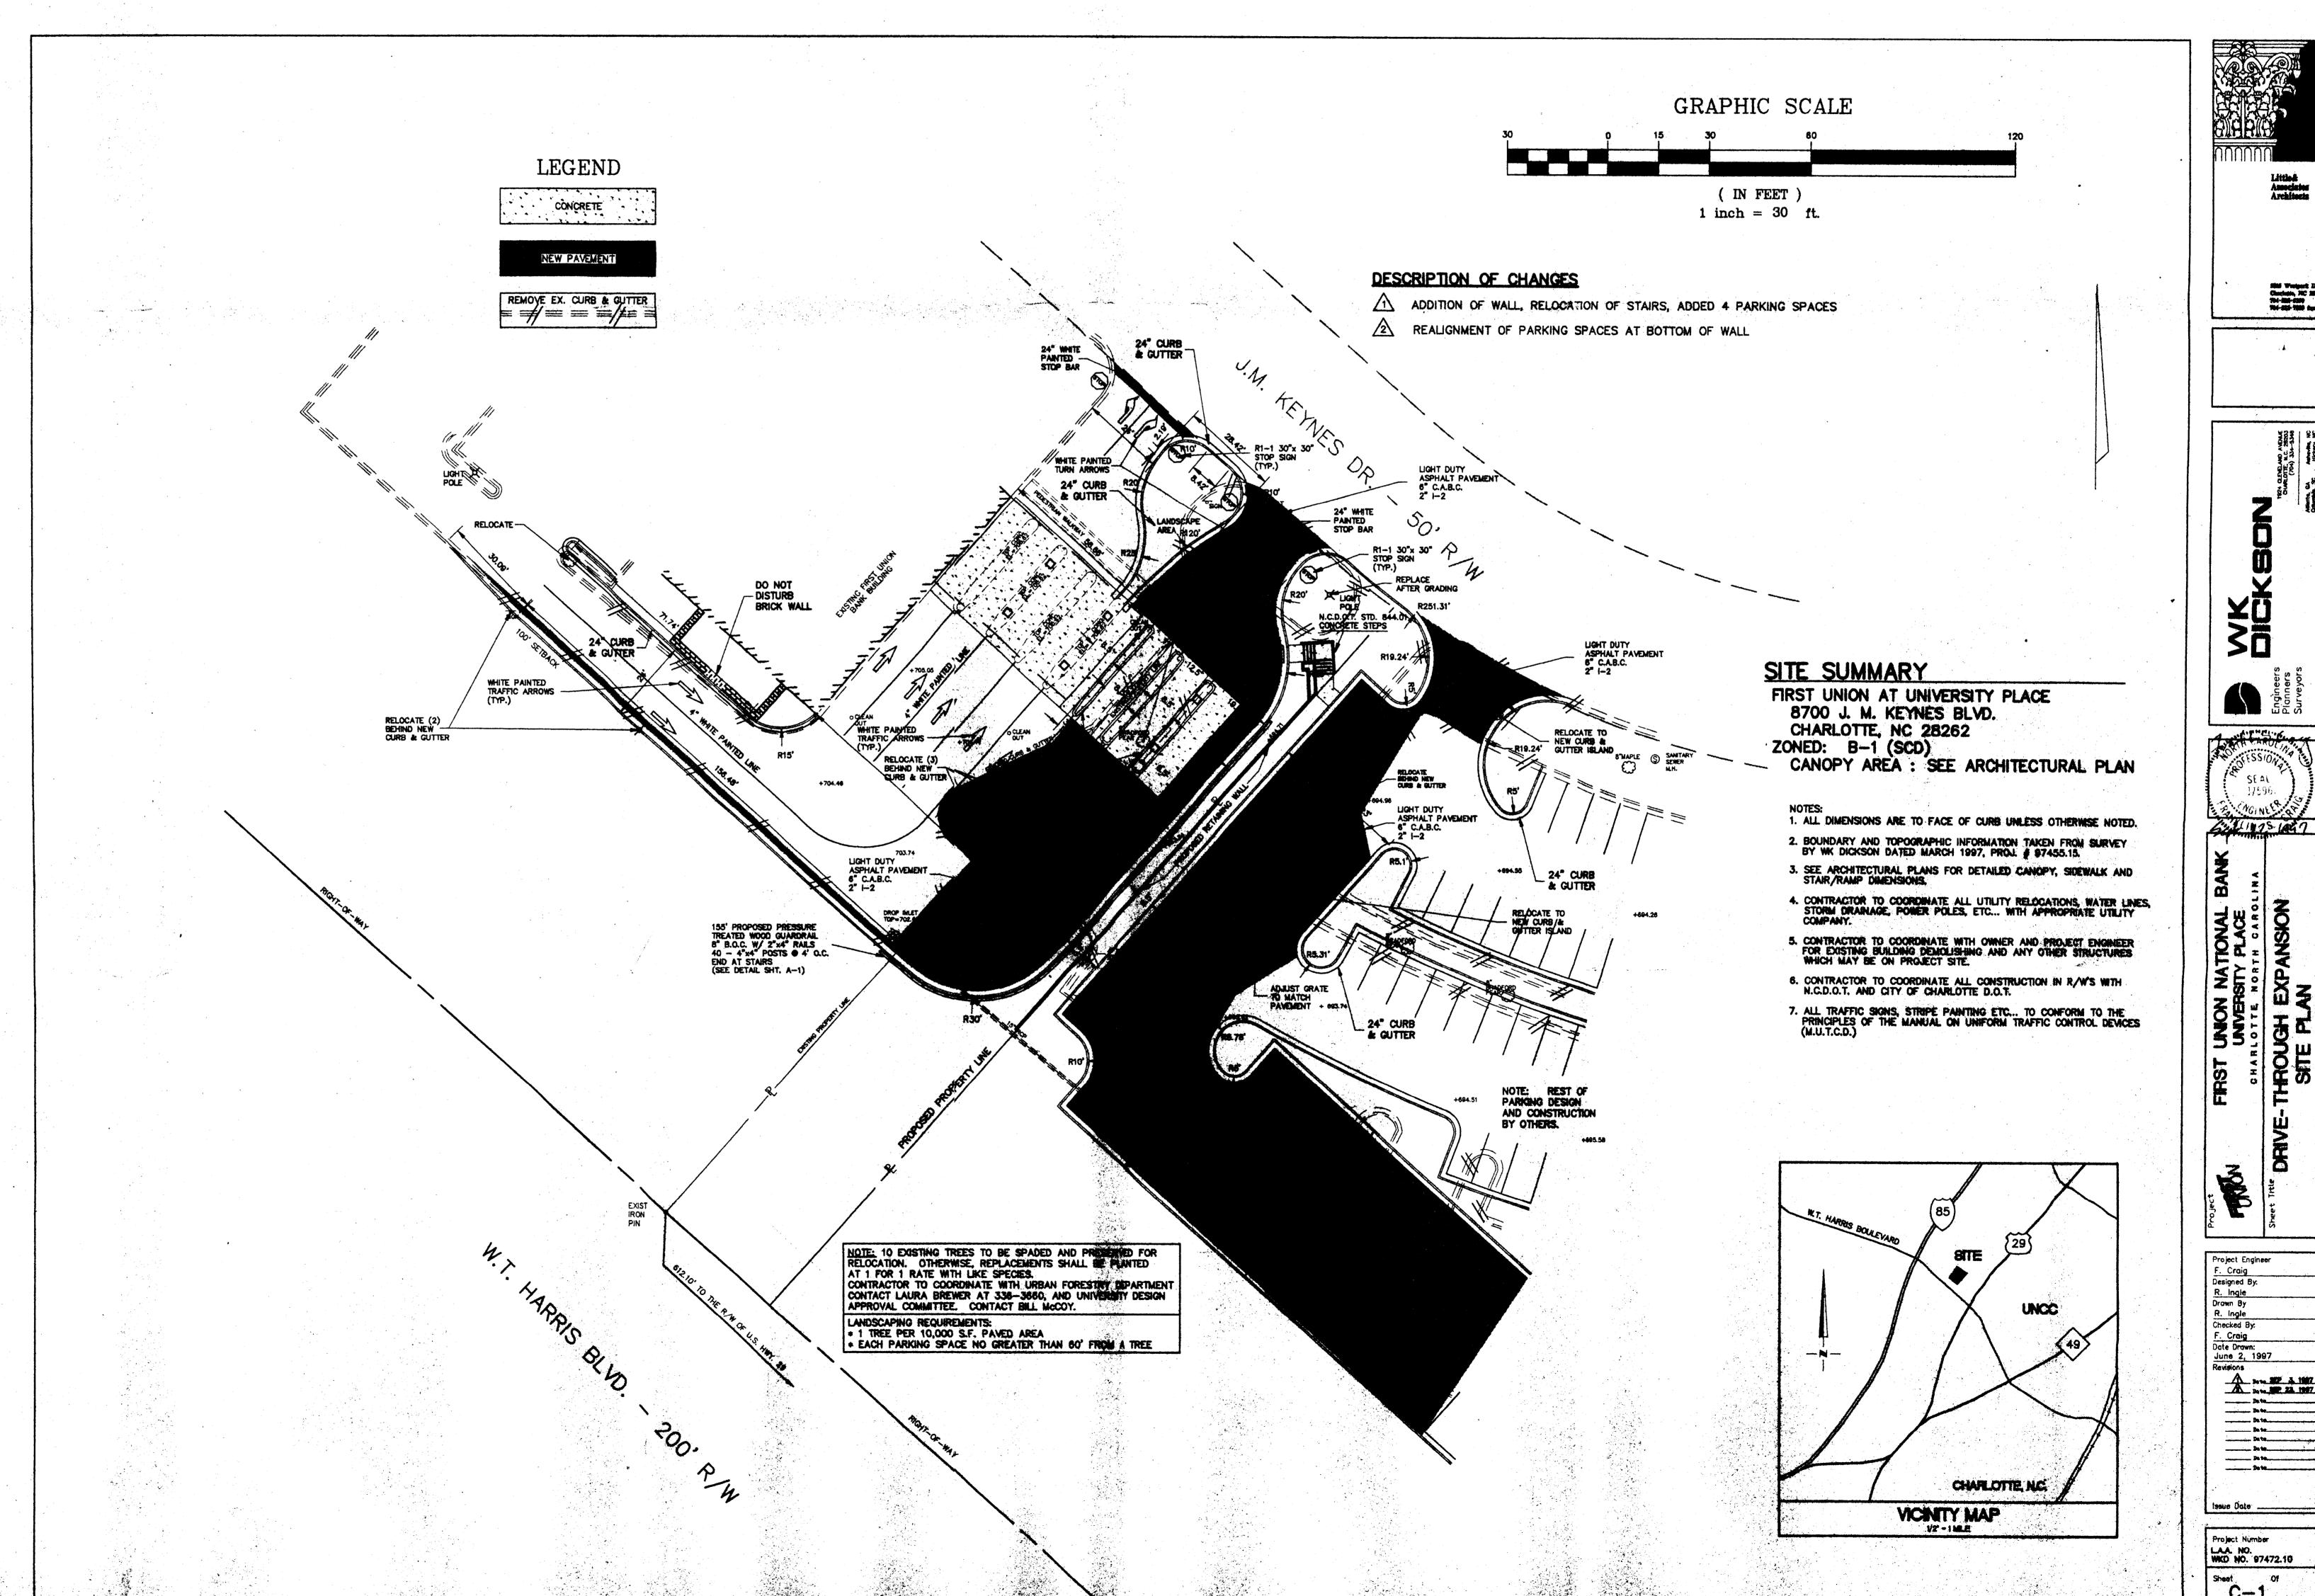

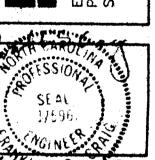


Project Engineer F. Craig Date Drawn: June 2, 1997 A 2010 SEP 2 1987 _____ Data_____ _____ Bate_____ Date _____ De te______ _____ Pa te_____

Project Number LAA. NO. WKD NO. 97472.10 Sheet

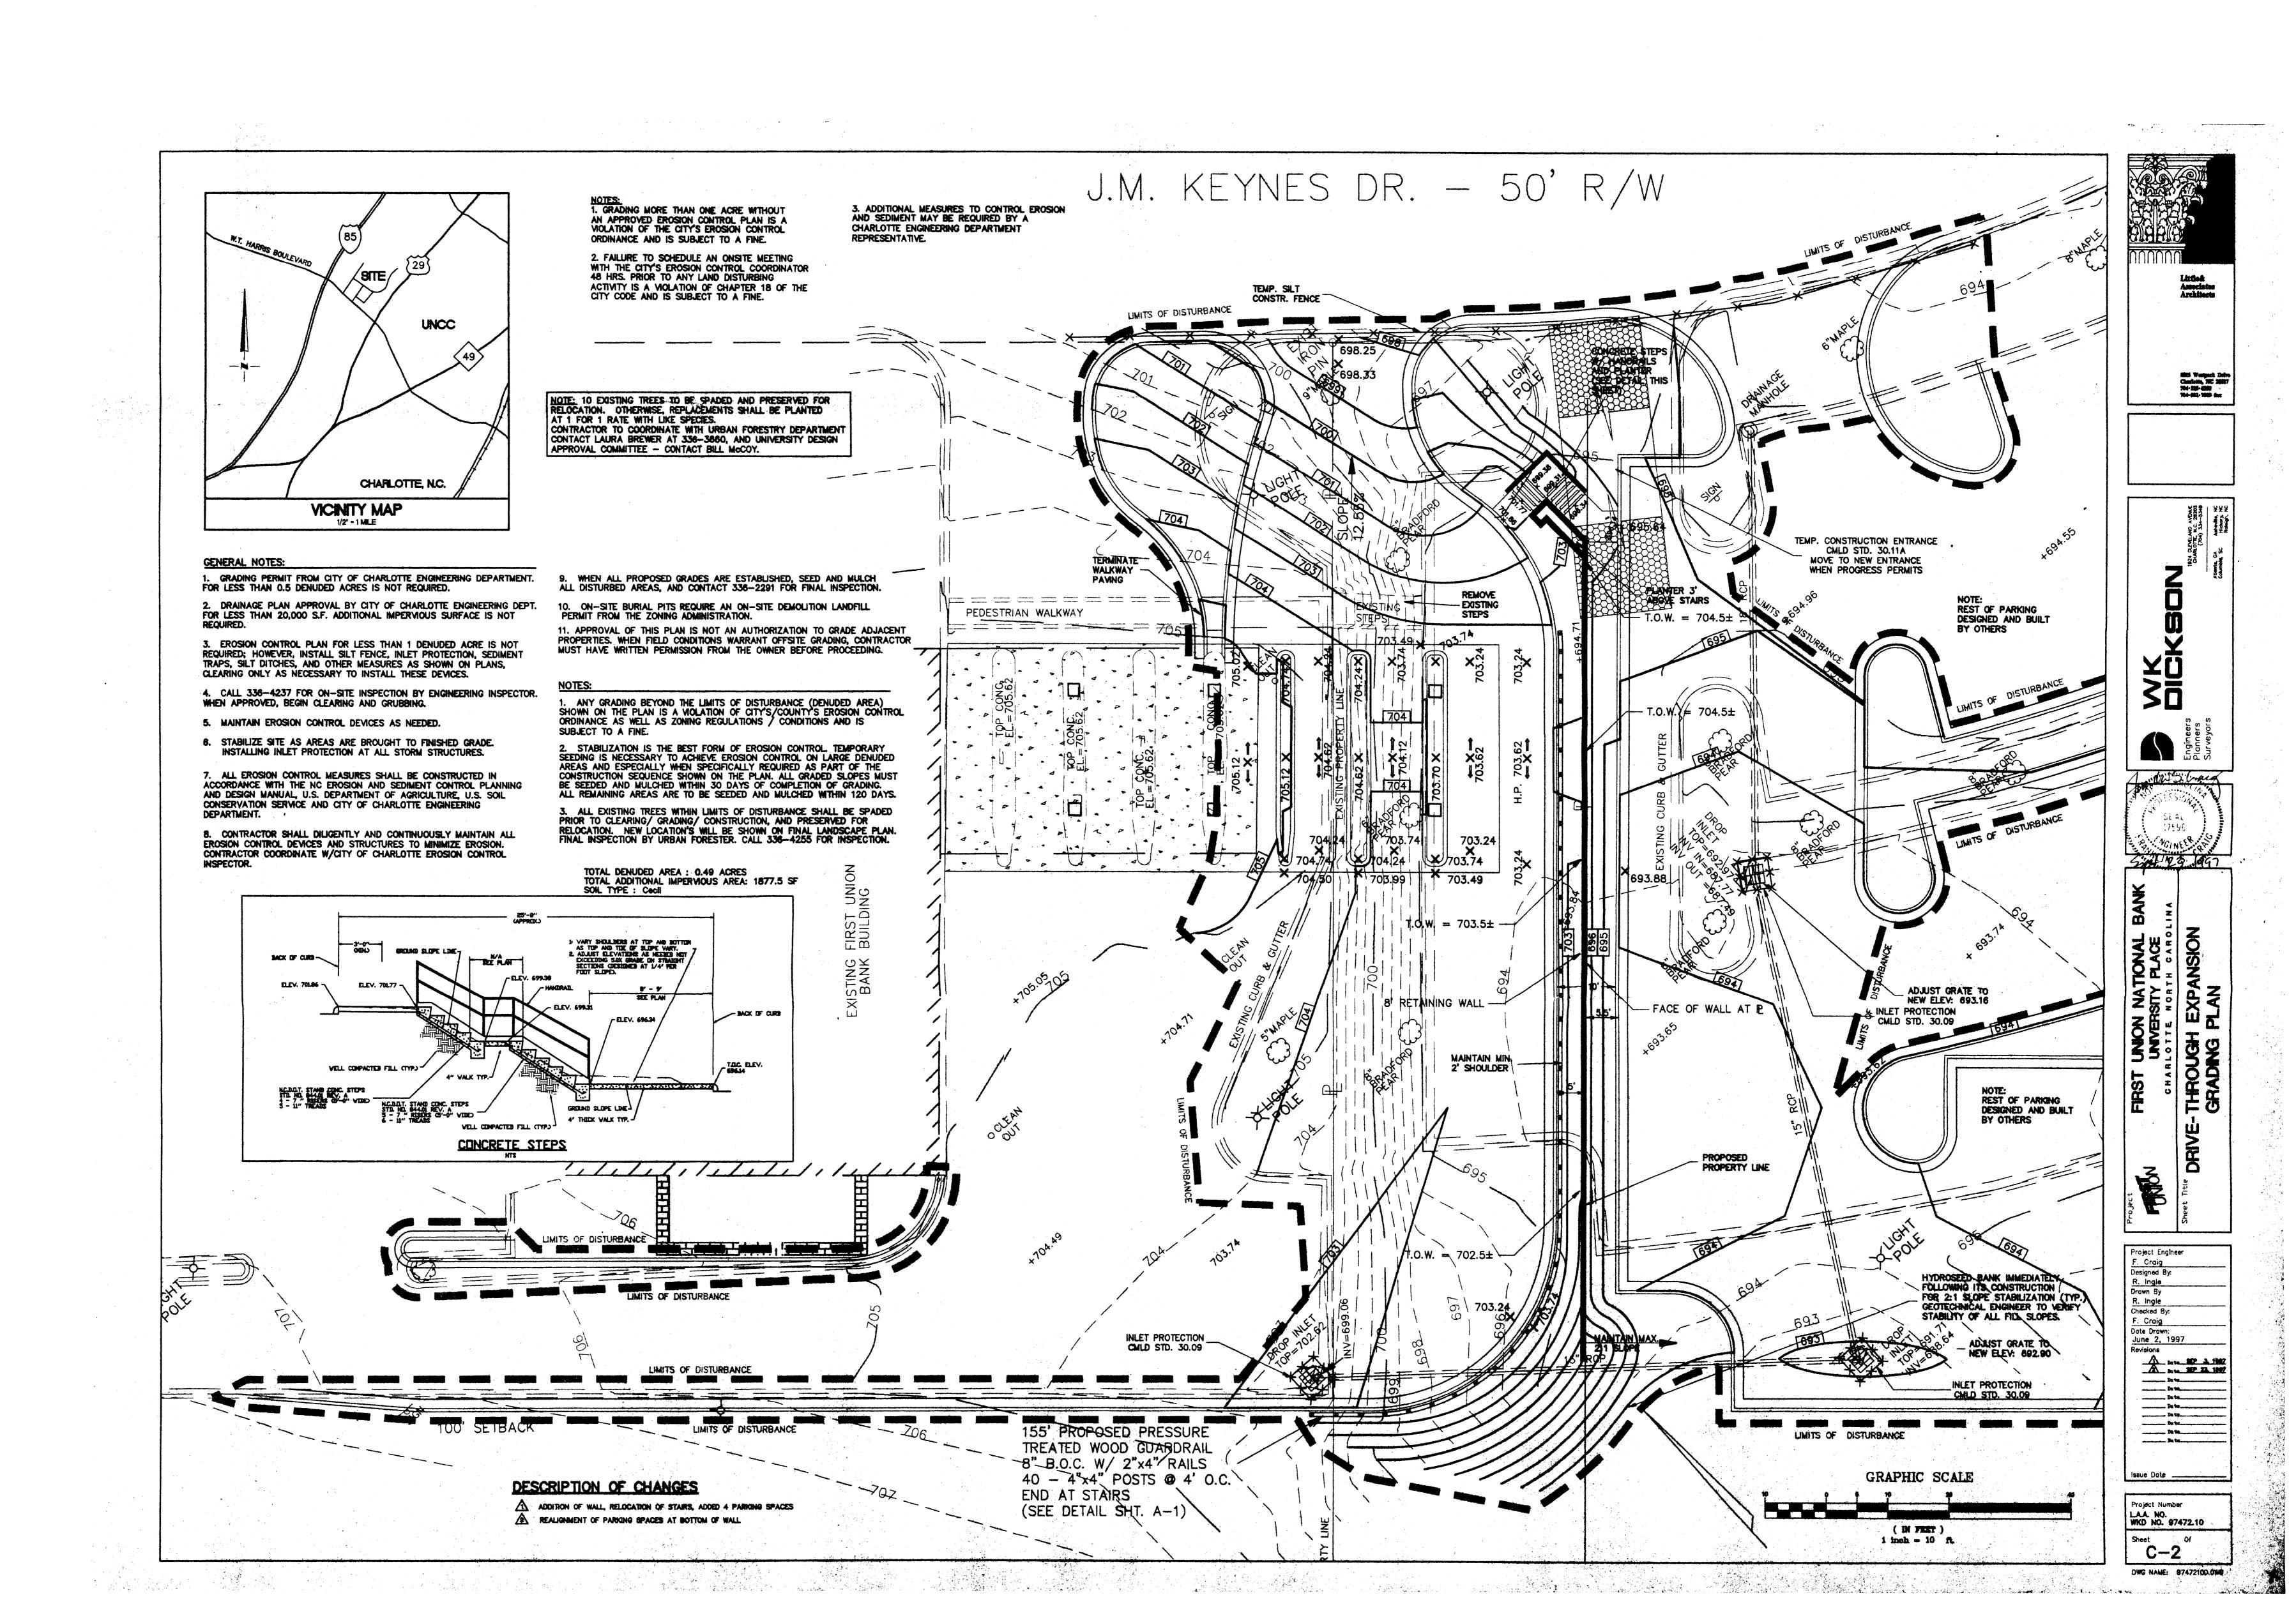

_ .

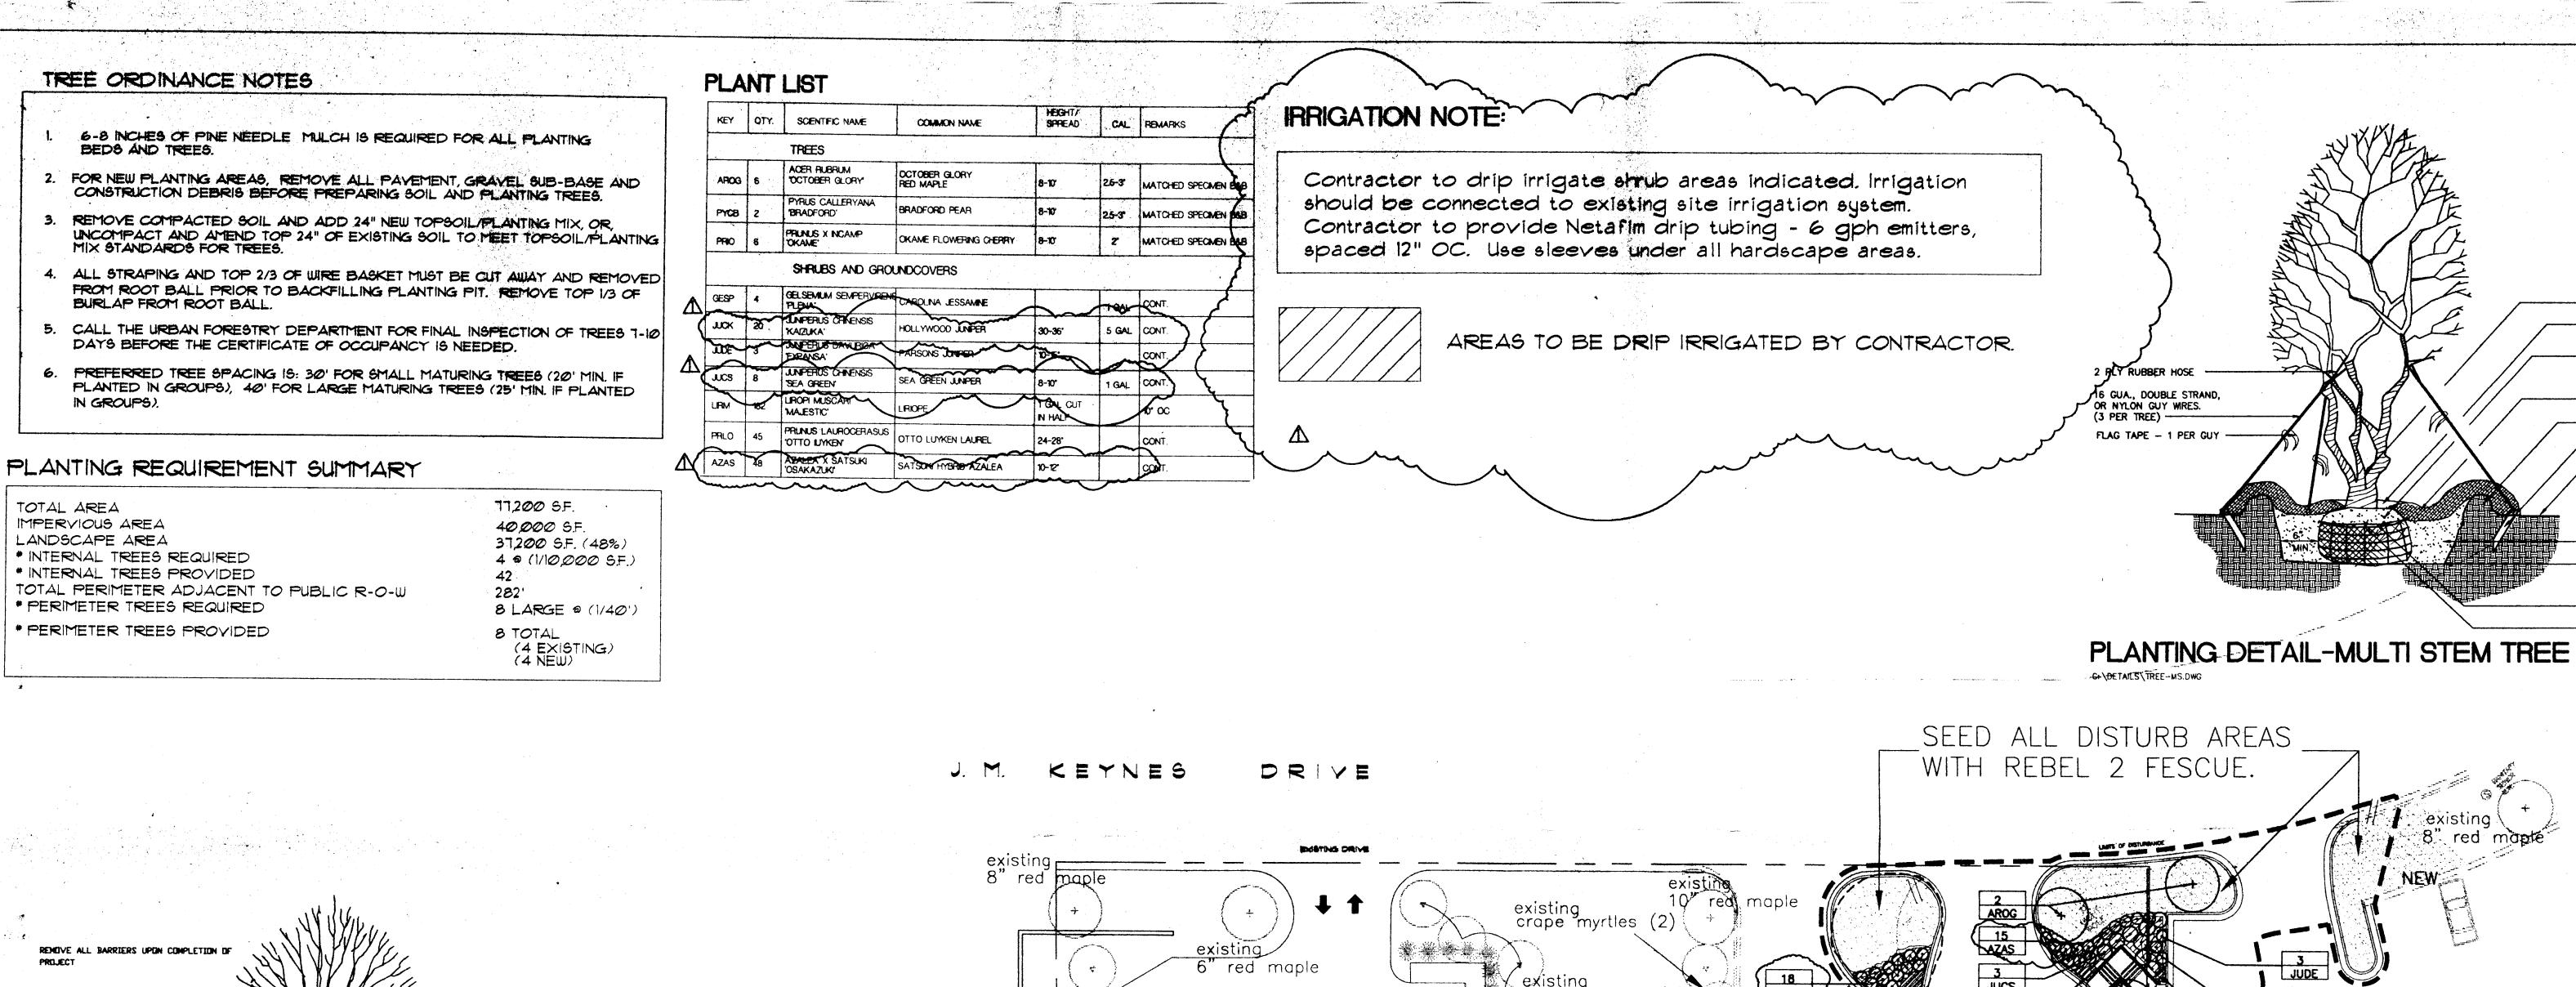

ROOT PROTECTION ZONE: ONE FOOT FOR EACH INCH OF TRUNK DIAMETER OR 1/2 HEIGHT OF TREE WHICHEVER IS GREATER -

(6' MINIMUM VIDTH)

DIMENSION ON PLAN

disturbing activity are allowed in the tree protection zone.

TREE PROTECTION DETAIL

final inspection by Urban Forester.

barricades by Urban Forester.

an individual basis by the Urban Forestry staff.

NO GRUBBING ALLOWED

1. Note: No soil disturbance or compaction, construction naterials, traffic, trenching, burial pits or other land

2. Tree barricades must be installed before any denolition, grading or construction and not removed until after

3. Trees protection barriers shall extend around the trees with a radius of no less than one foot (1') for every one inch CD of trunk diameter -or- 1/2 the height of the tree, whichever is greater, unless otherwise approved on

4. All tree protection barriers shall be installed prior to anygrading, construction or other land-disturbing activity.


They shall be constructed from any material substantial enough to protect the roots, trunk and crown of the tree,


such as orange safety fencing on netal posts, wooden 2"x4" standards with 1"x4" rails, or 3" high sit fance

with flagging.

5. Before denolition, grading or construction begins, call 336–3599 or 2291 for impection of tree protection

DRANGE SAFETY FENCE ON METAL POSTS OR 2'X4' STANDARDS AND 1'X4' RAILS DR 3' HIGH SILT FENCE WITH FLAGGING

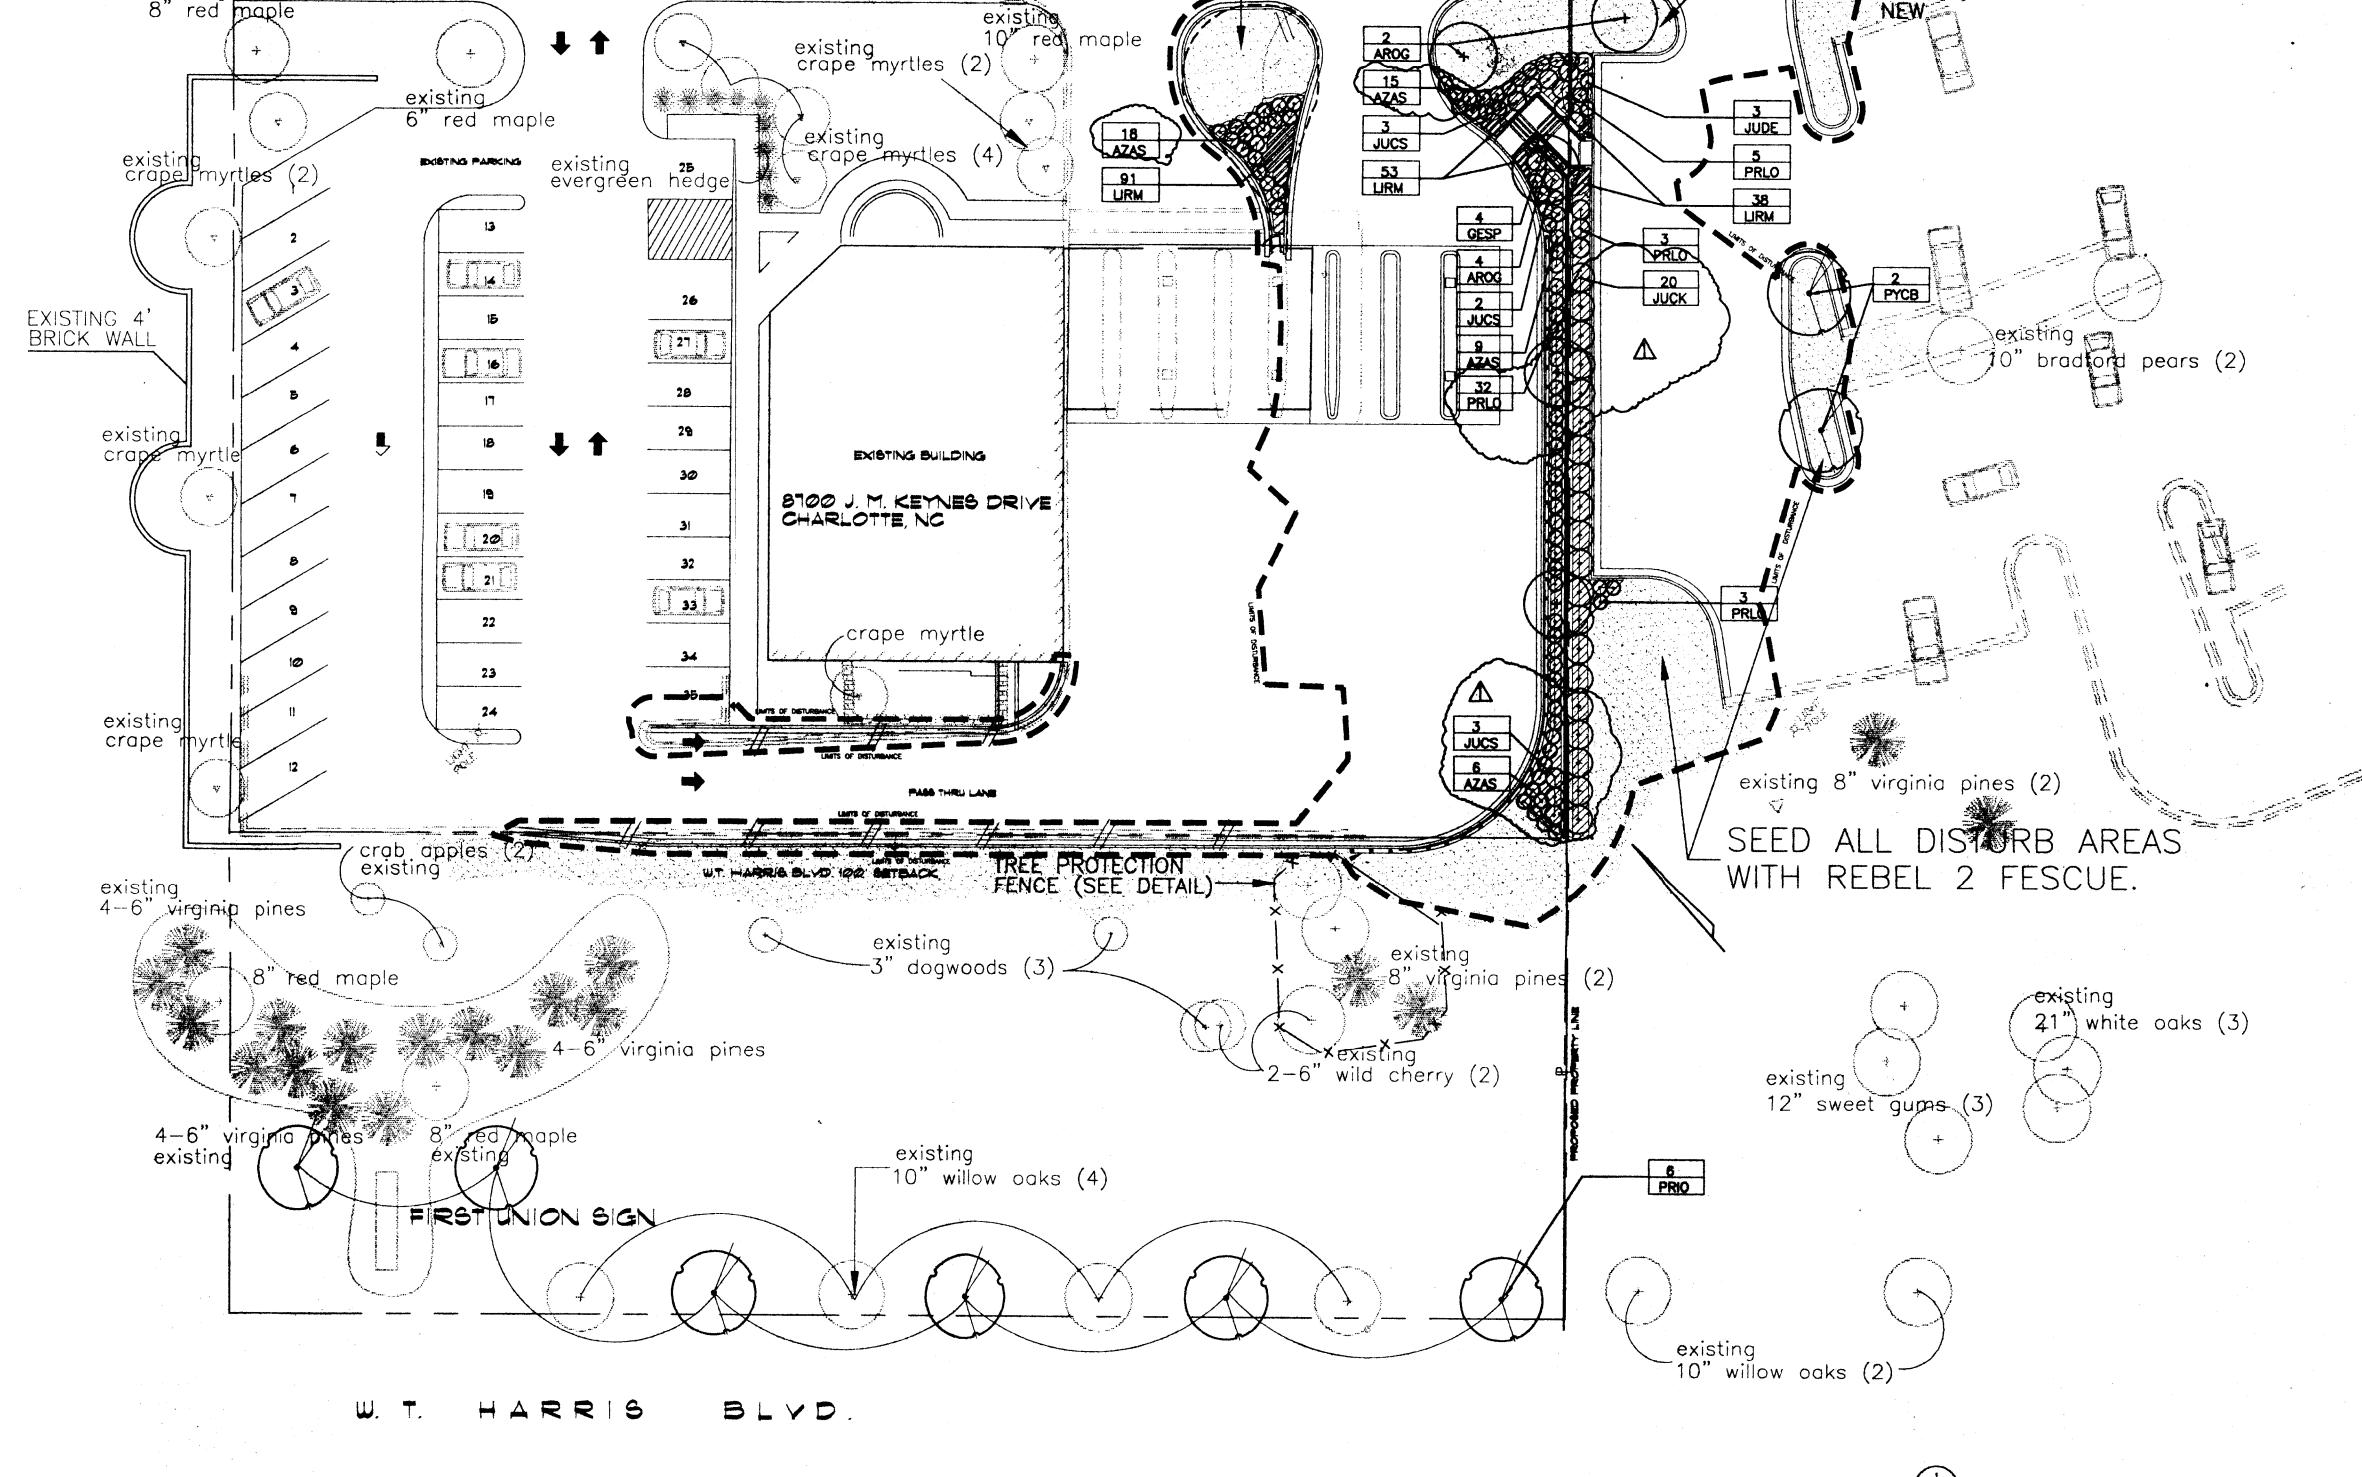

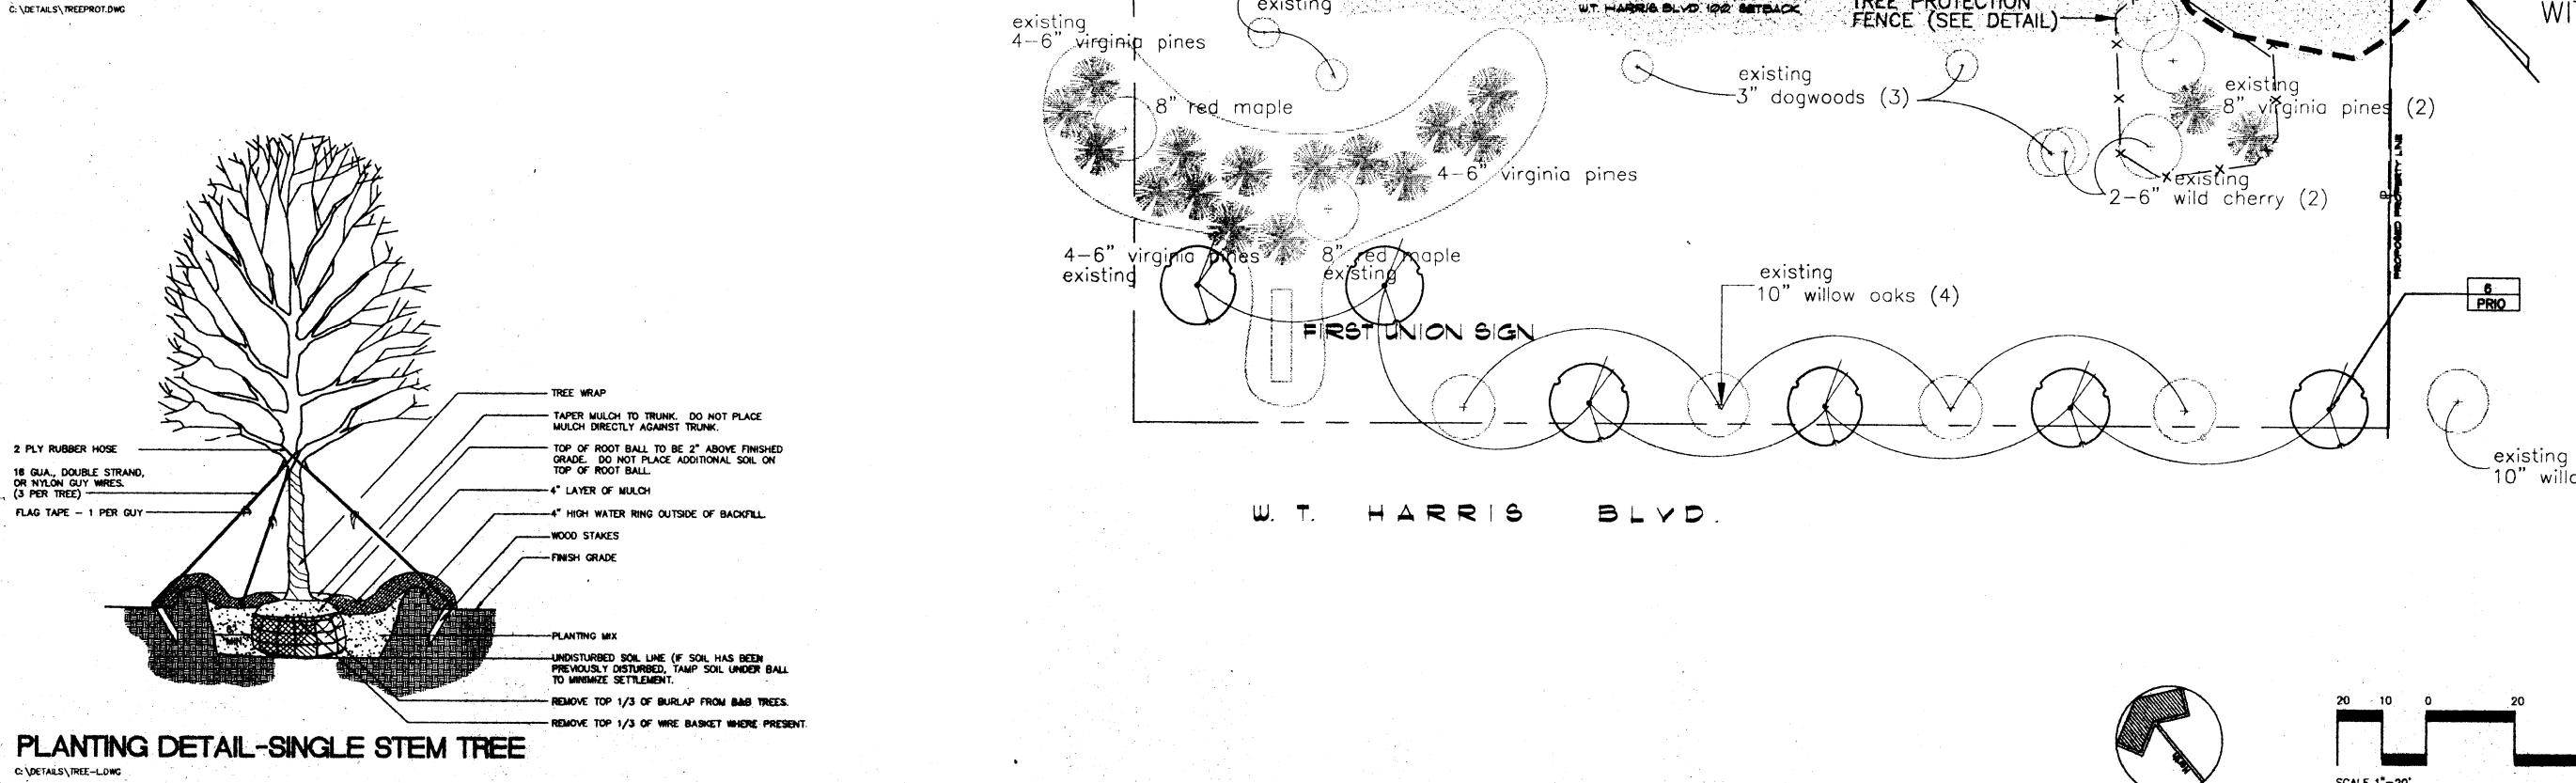

UNIVERSITY PLACE BRANCH

TAPER MULCH TO TRUNK. DO NOT PLACE MULCH DIRECTLY AGAINST TRUNK.

----4" HIGH WATER RING OUTSIDE OF BACKFILL.

--- FINISH GRADE

-PLANTING MIX

TOP OF ROOT BALL TO BE 2" ABOVE FINISHED GRADE. DO NOT PLACE ADDITIONAL SOIL ON TOP OF ROOT BALL.

--- UNDISTURBED SOIL LINE (IF SOIL HAS BEEN PREVIOUSLY DISTURBED, TAMP SOIL UNDER BALL TO MINIMIZE SETTLEMENT.

REMOVE TOP 1/3 OF BURLAP FROM B&B TREES.

Little & Associates Architects


5815 Westpark Drive Charlotte, NC 28227 704-525-6350 704-561-6777 fax


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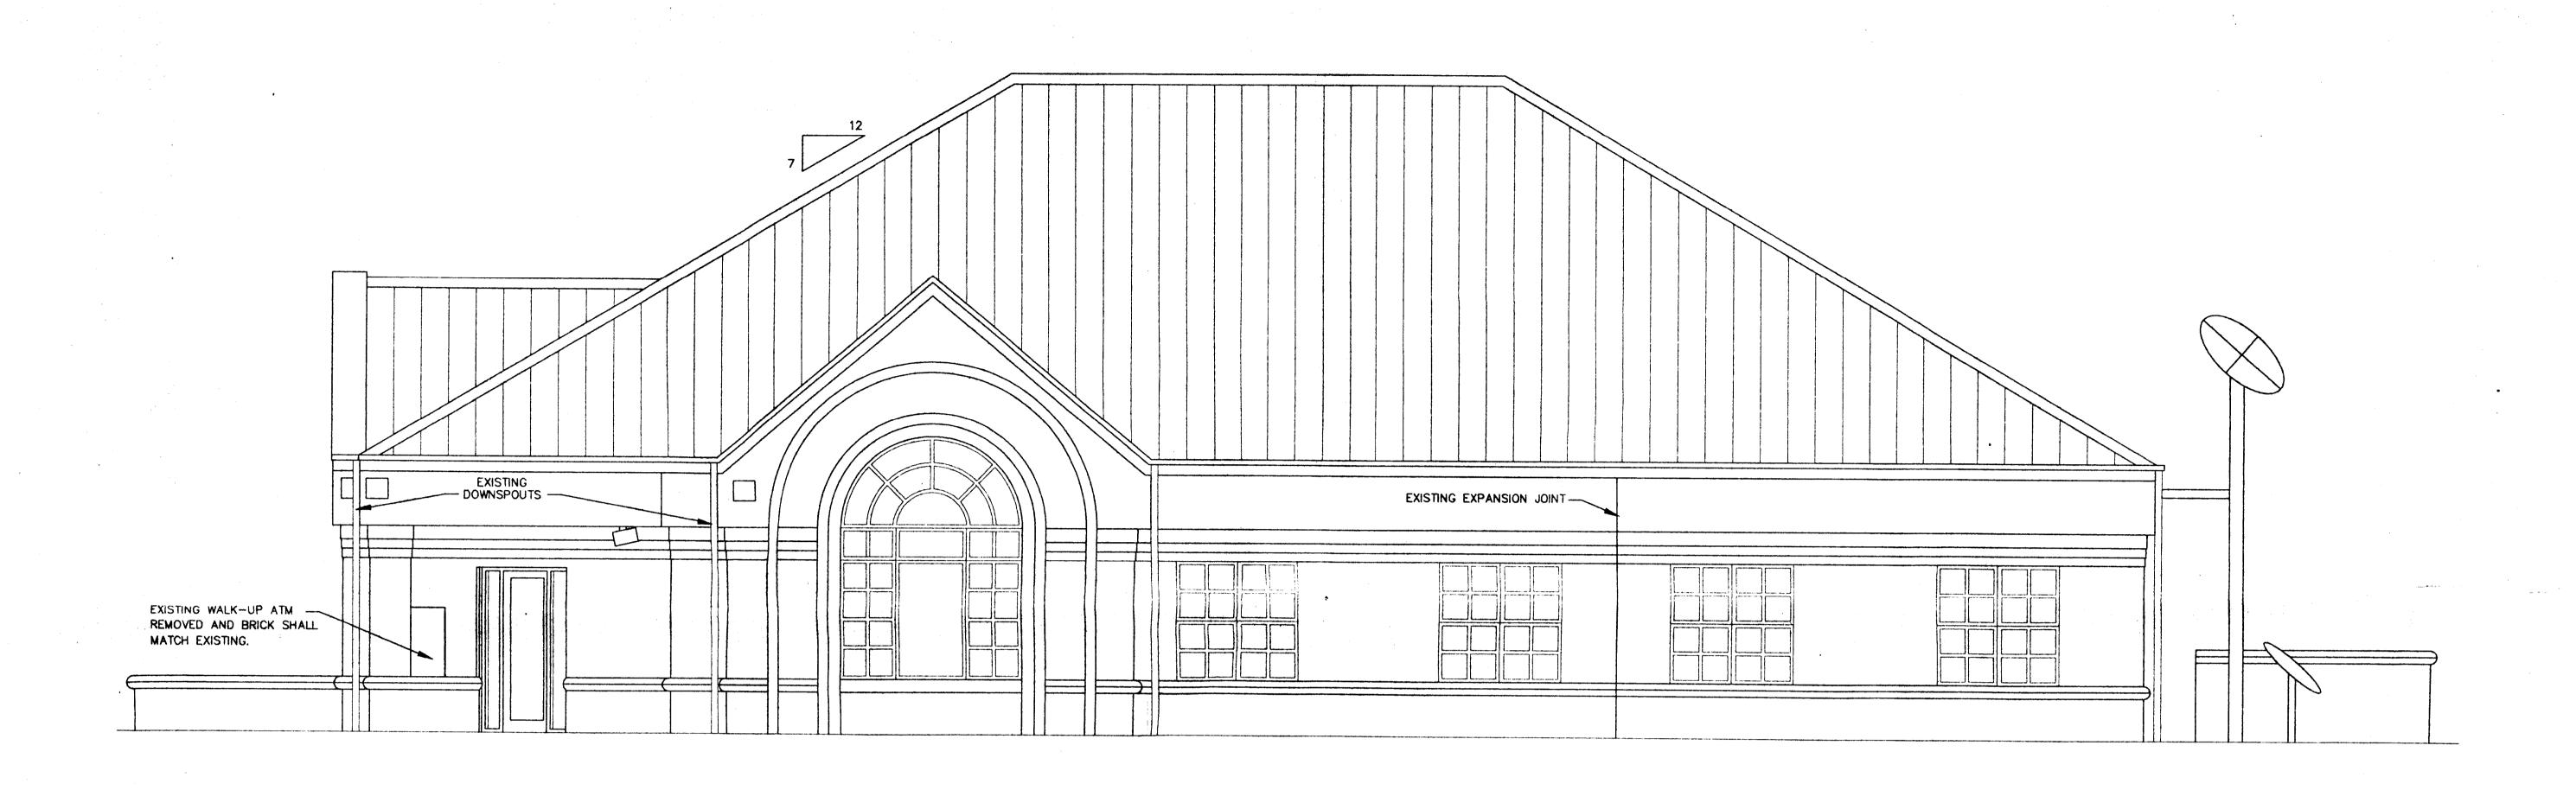
Division President C. RADKIN Job Captain N. EVERHART Drawn By DENNIS TERRY 09/03/97 Drawing File Name 1540L1.DWG 1"=20'

Project Number 04-1540-09

Issue Date:




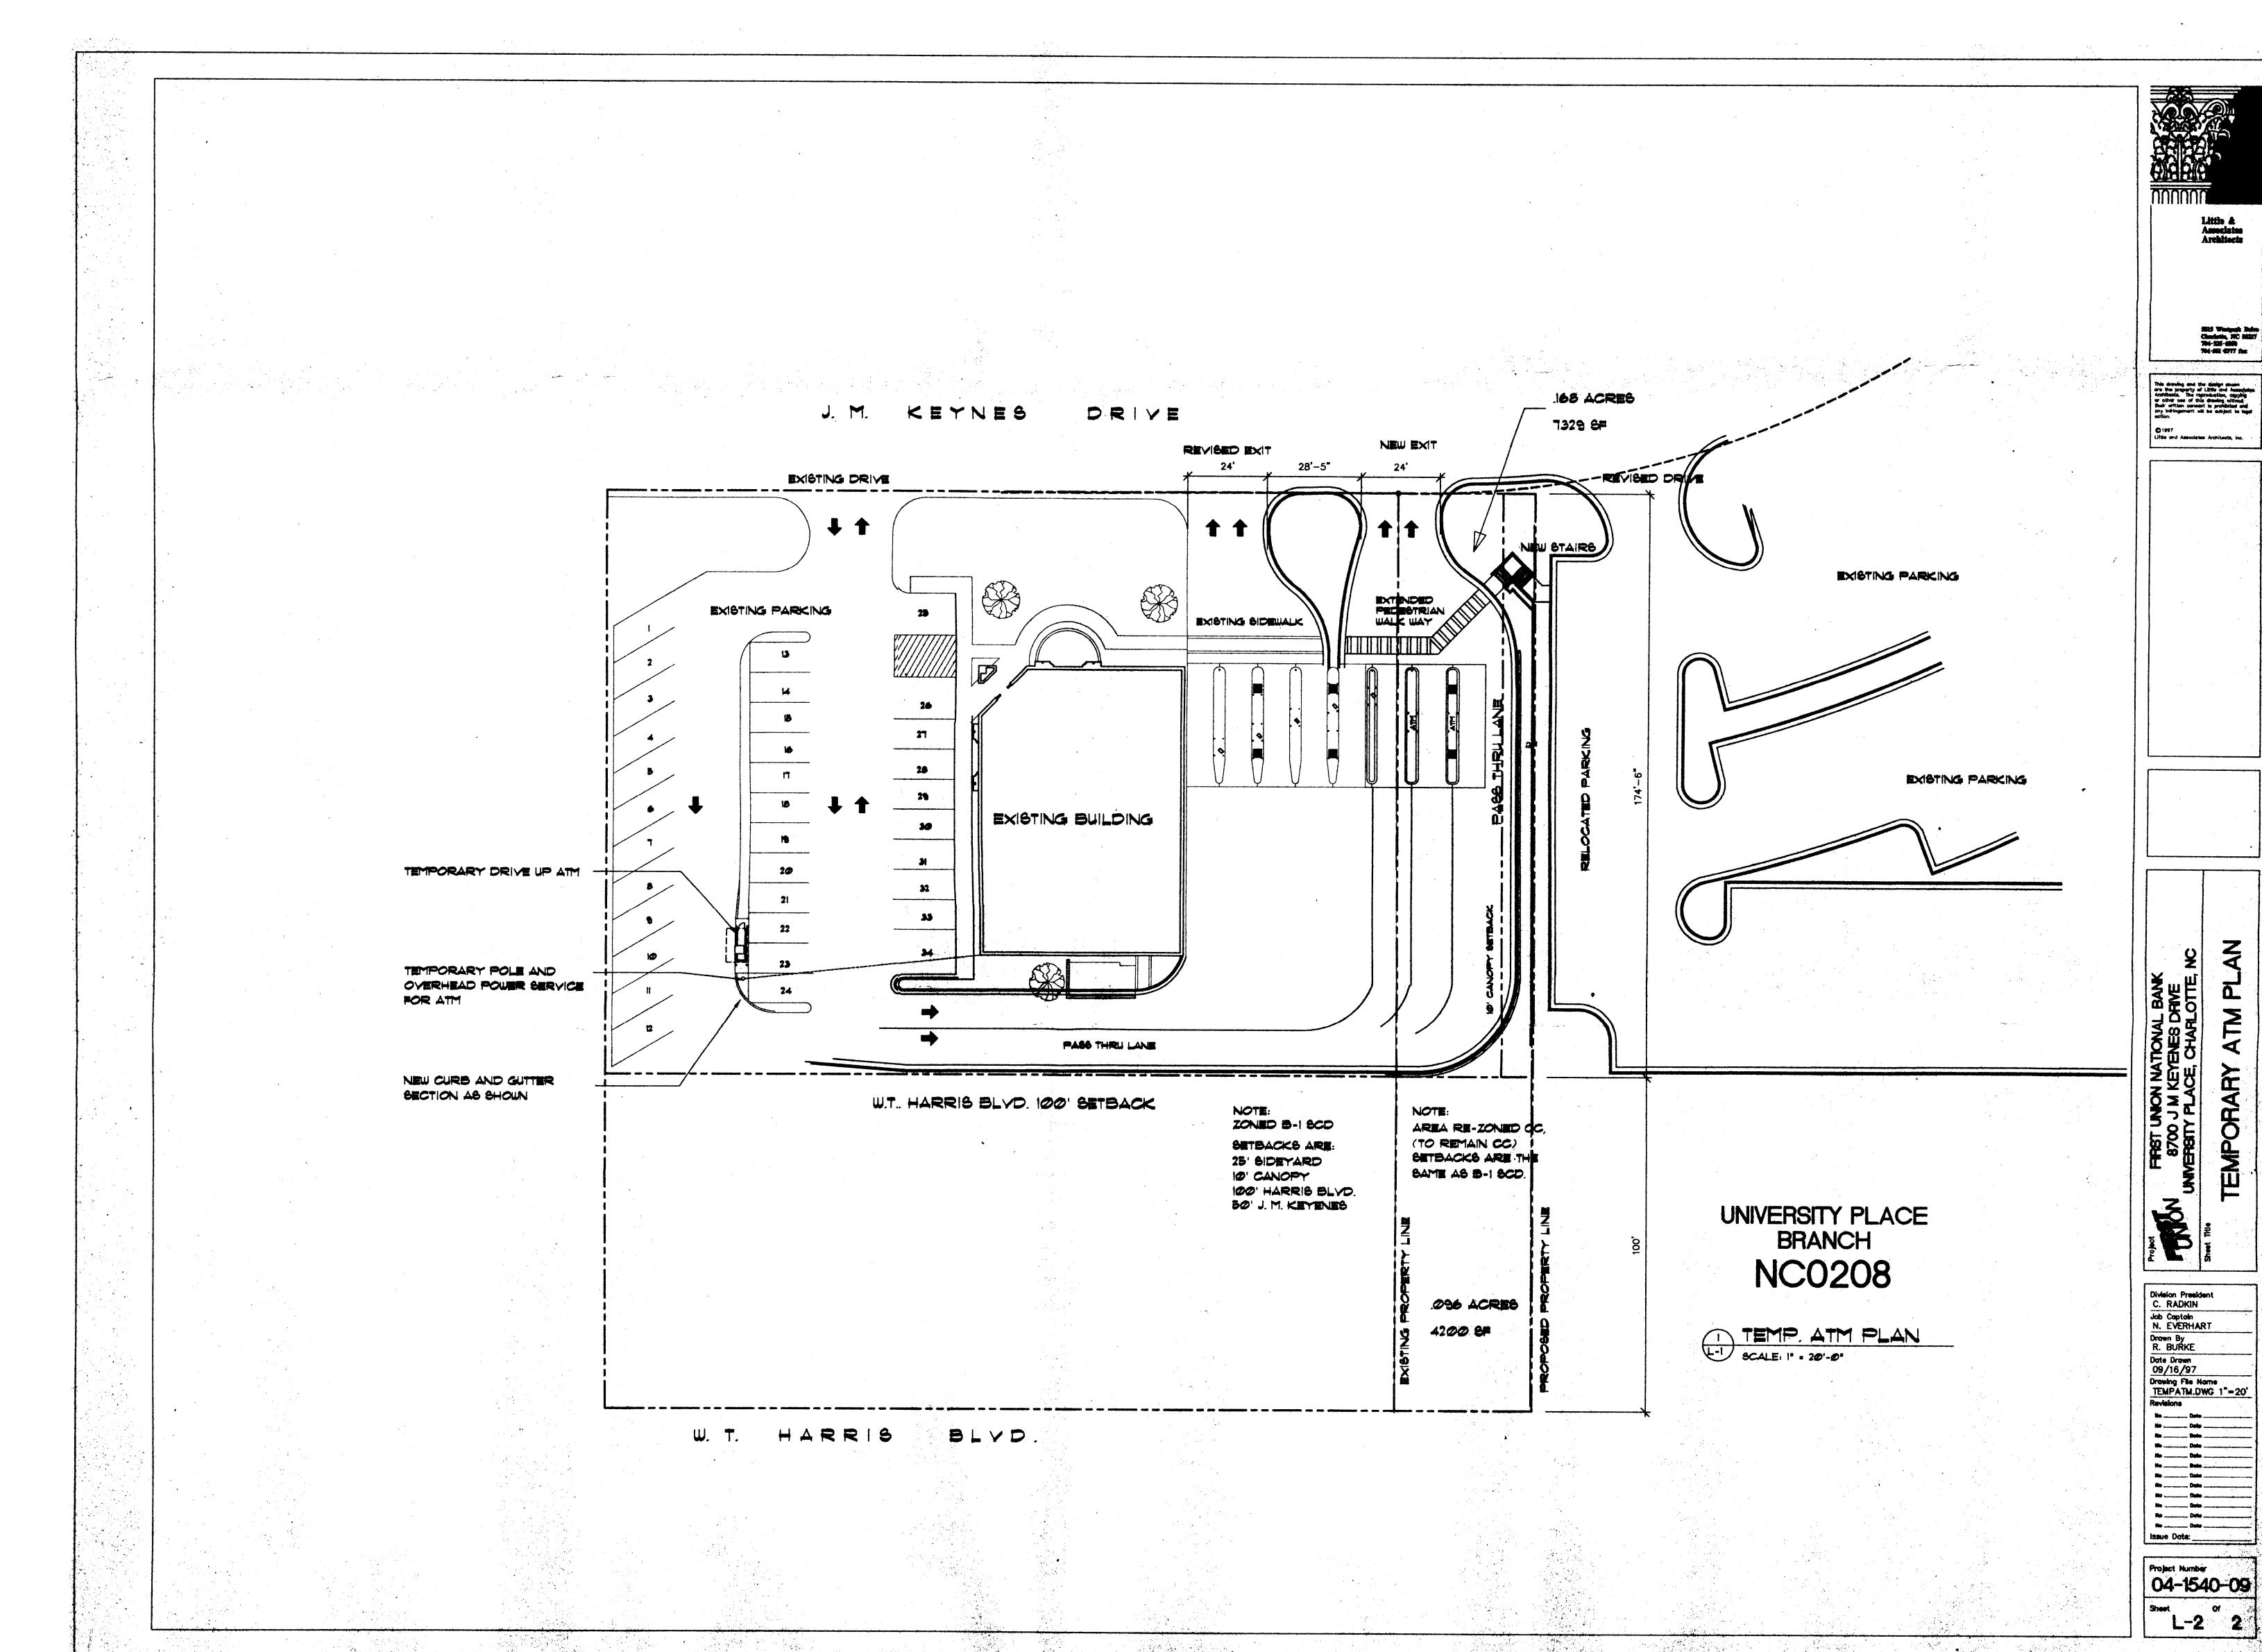

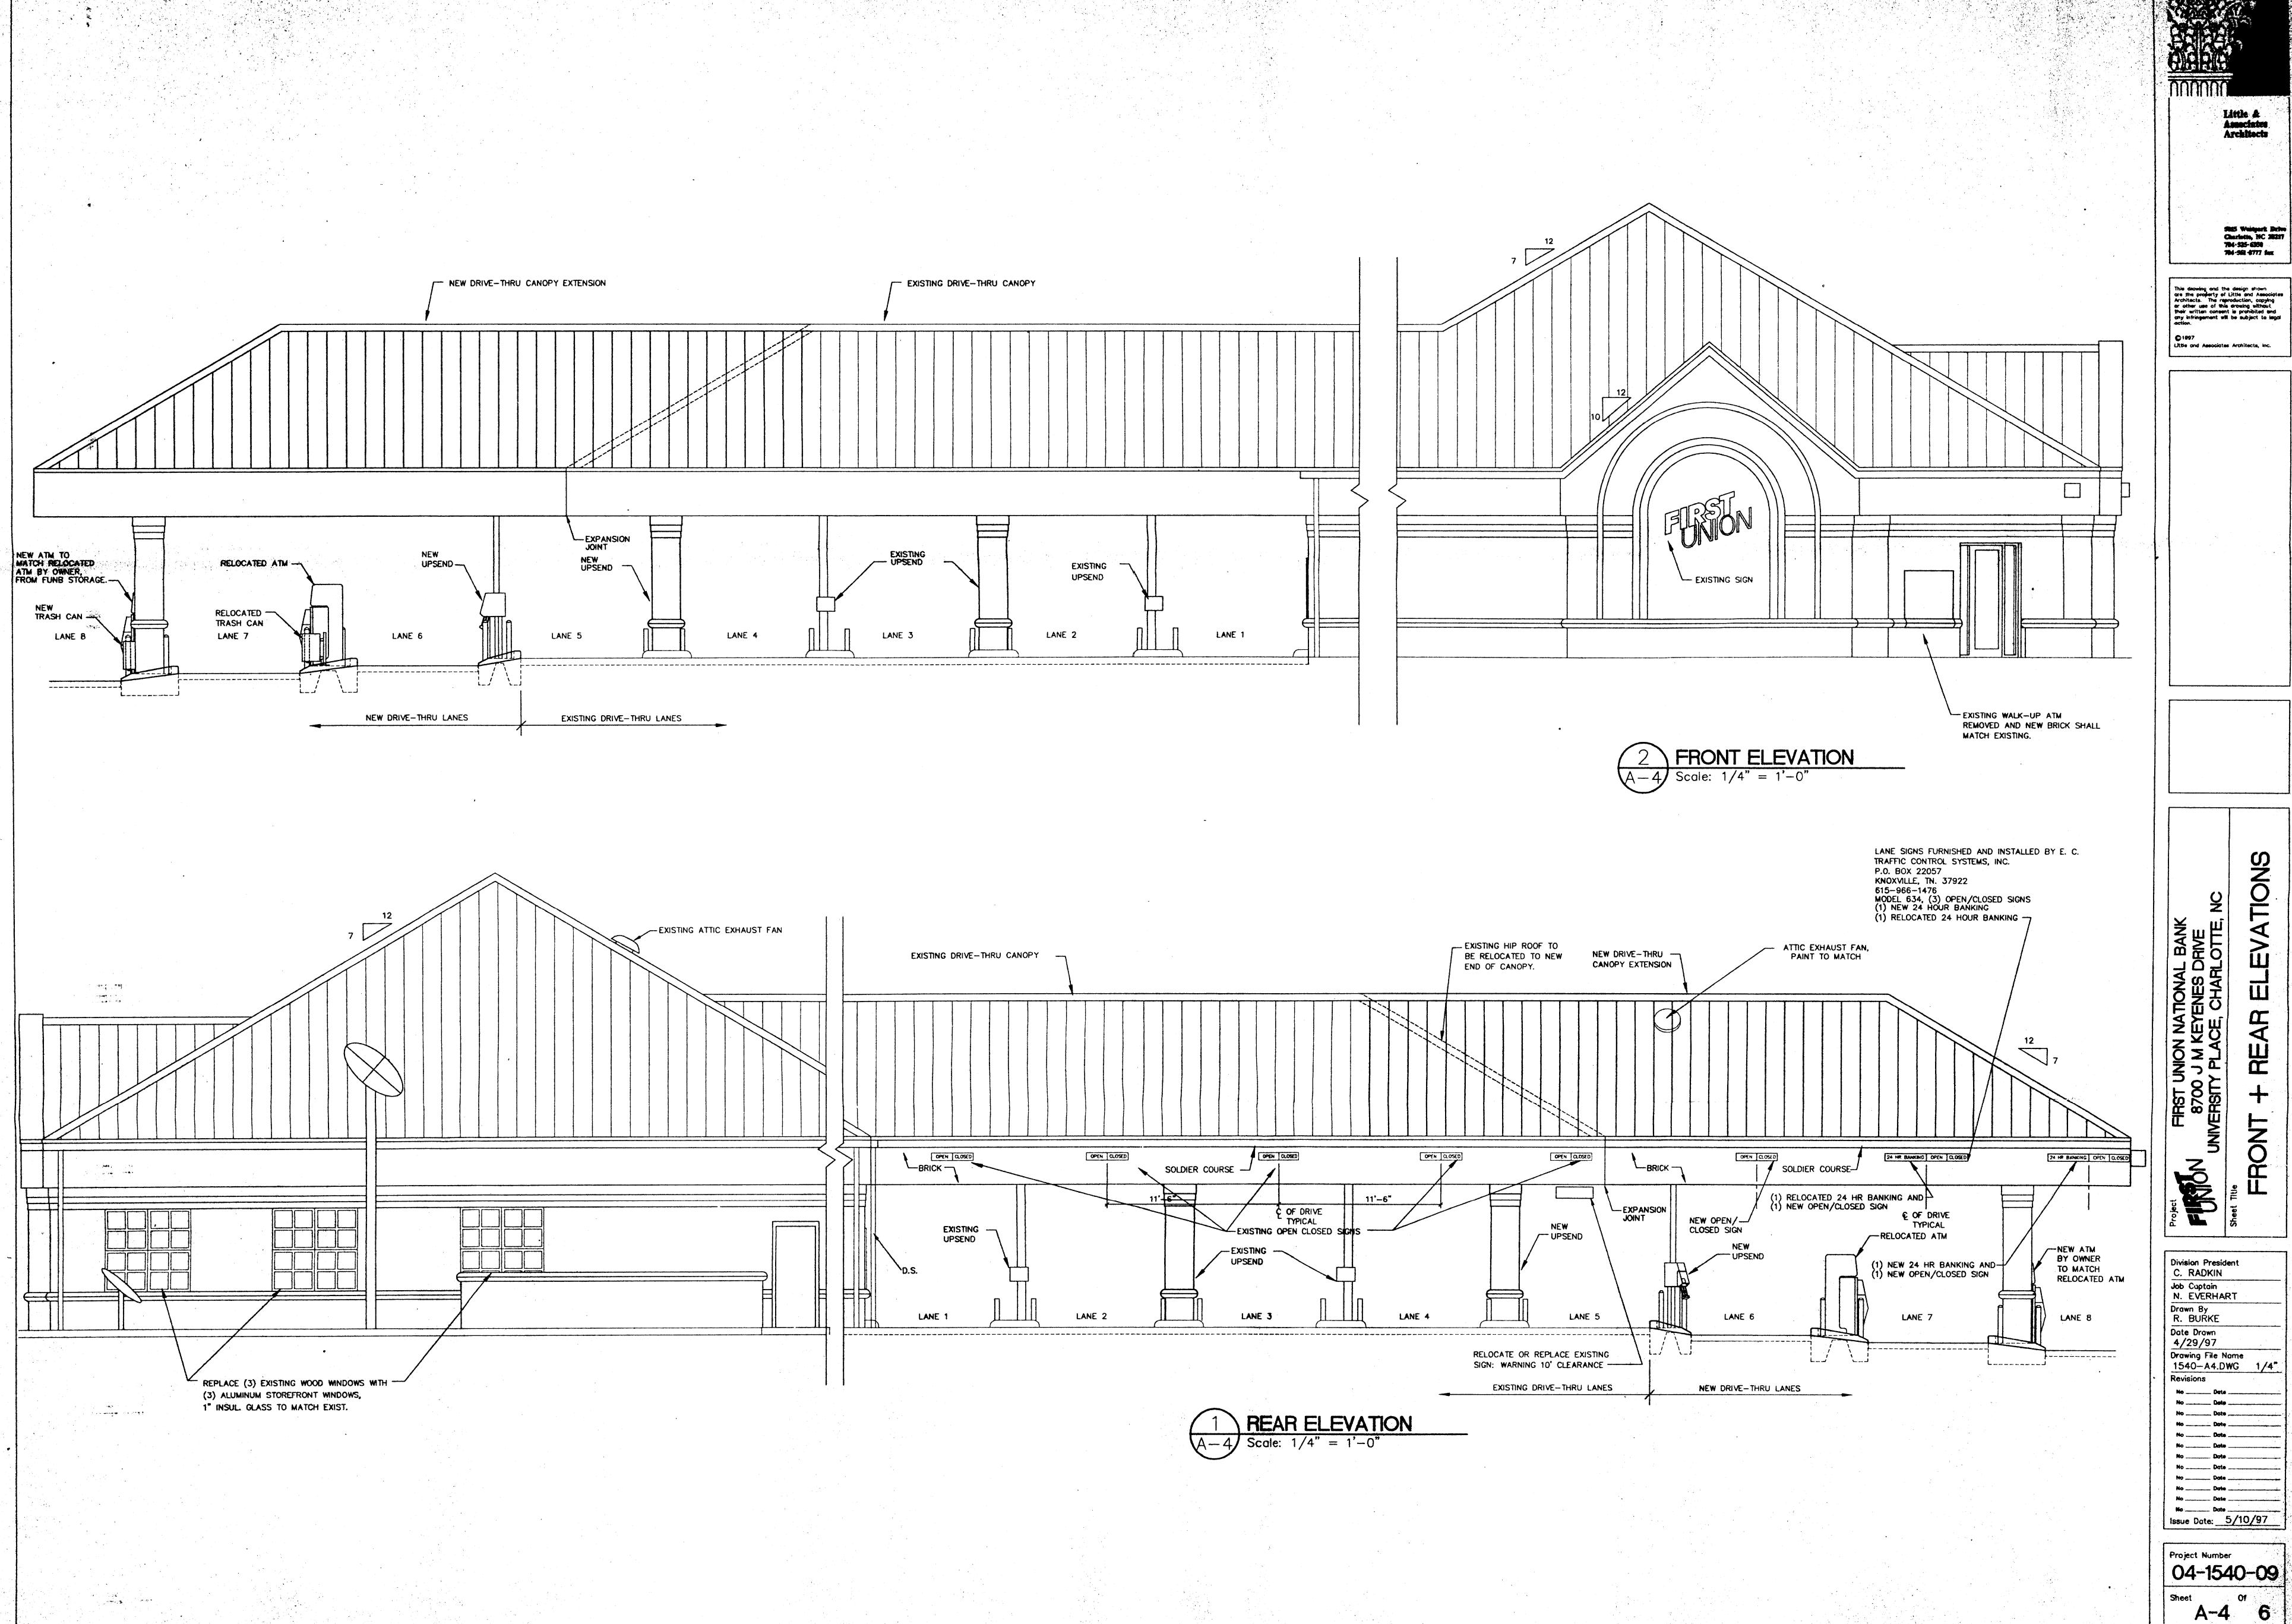

RIGHT SIDE ELEVATION

Scale: 1/4" = 1'-0"

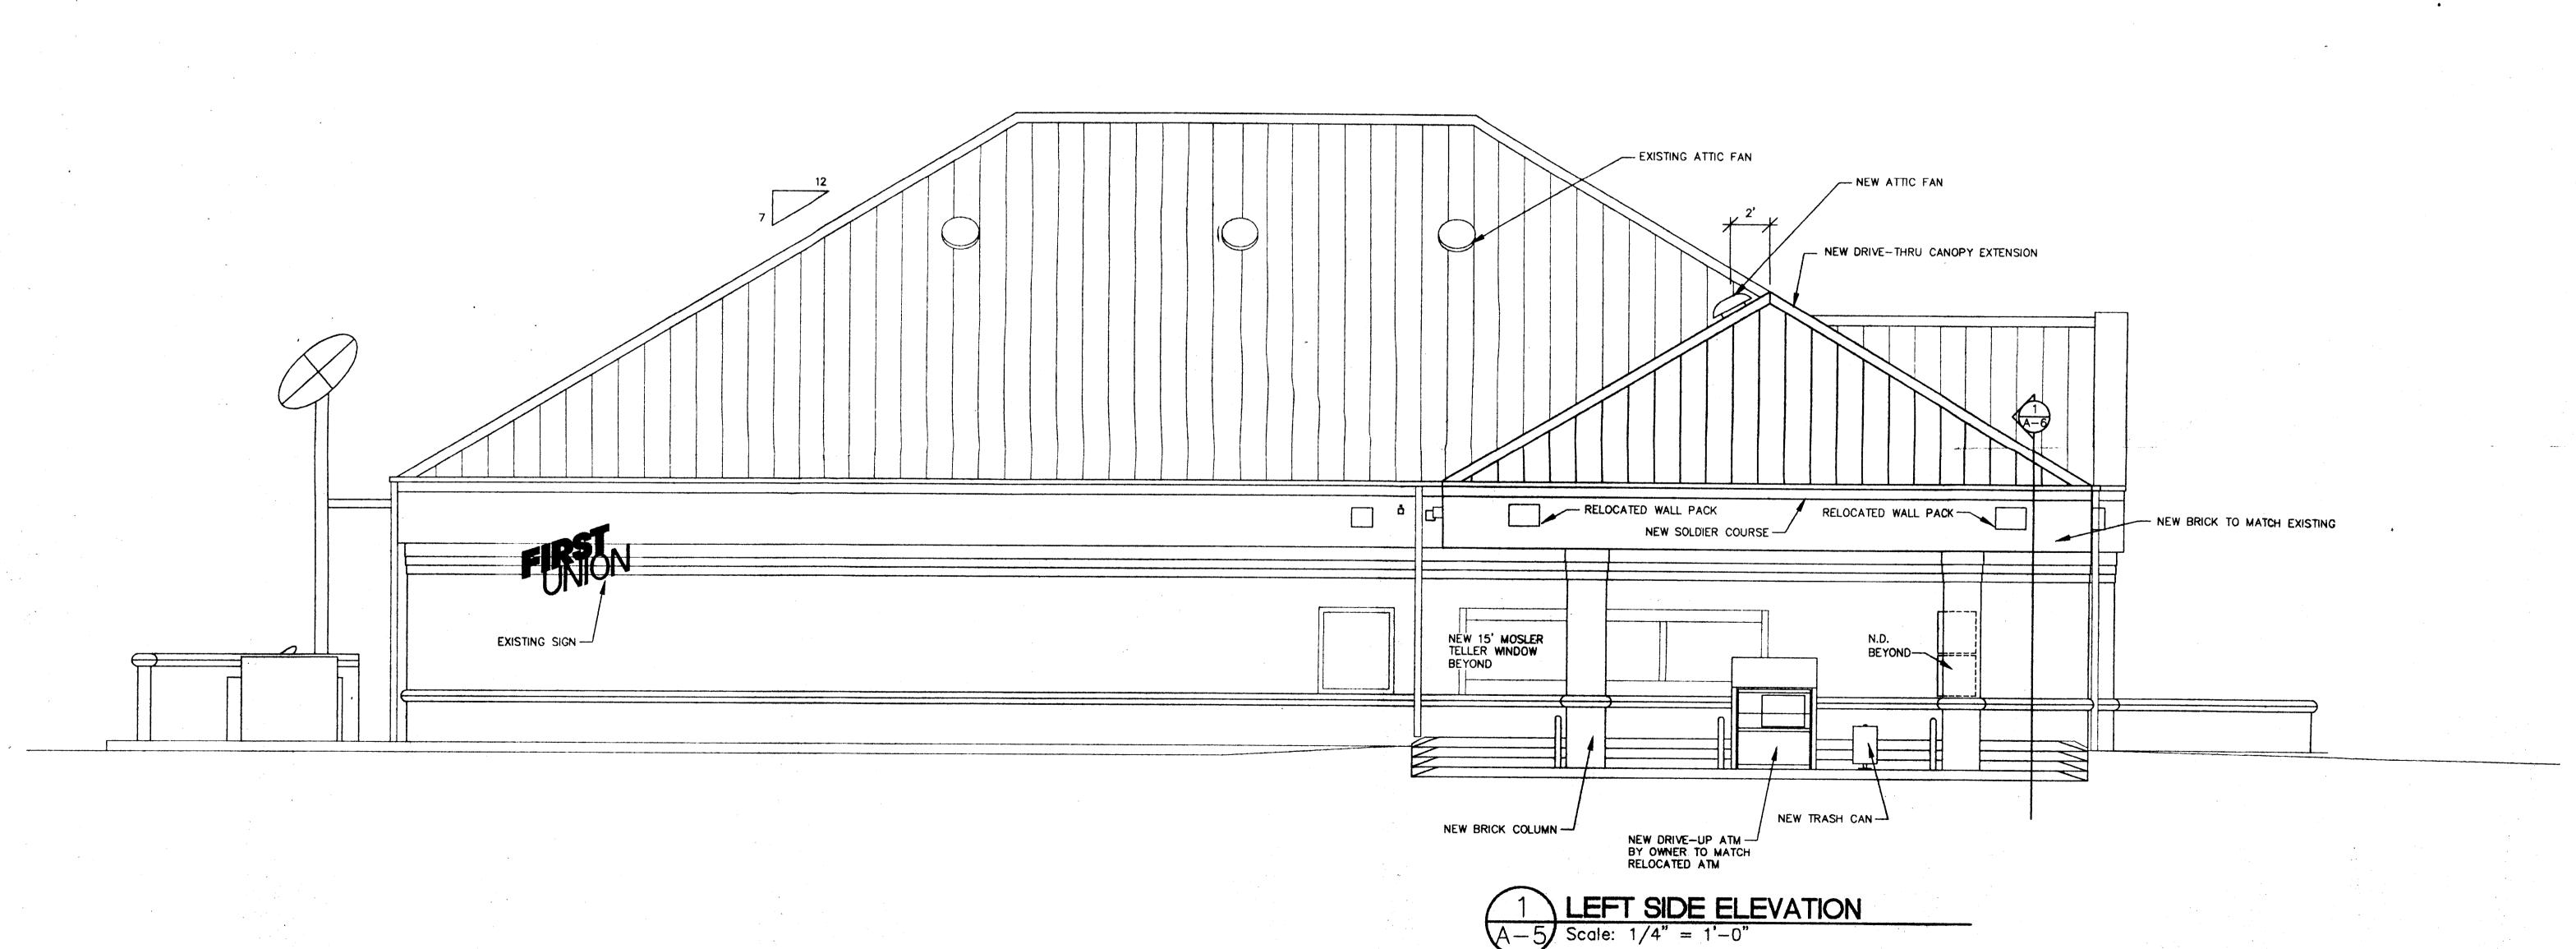

Little & Associates Architects

5815 Westpark Charlotta, NC : 784-525-6358 784-561-8777 fs

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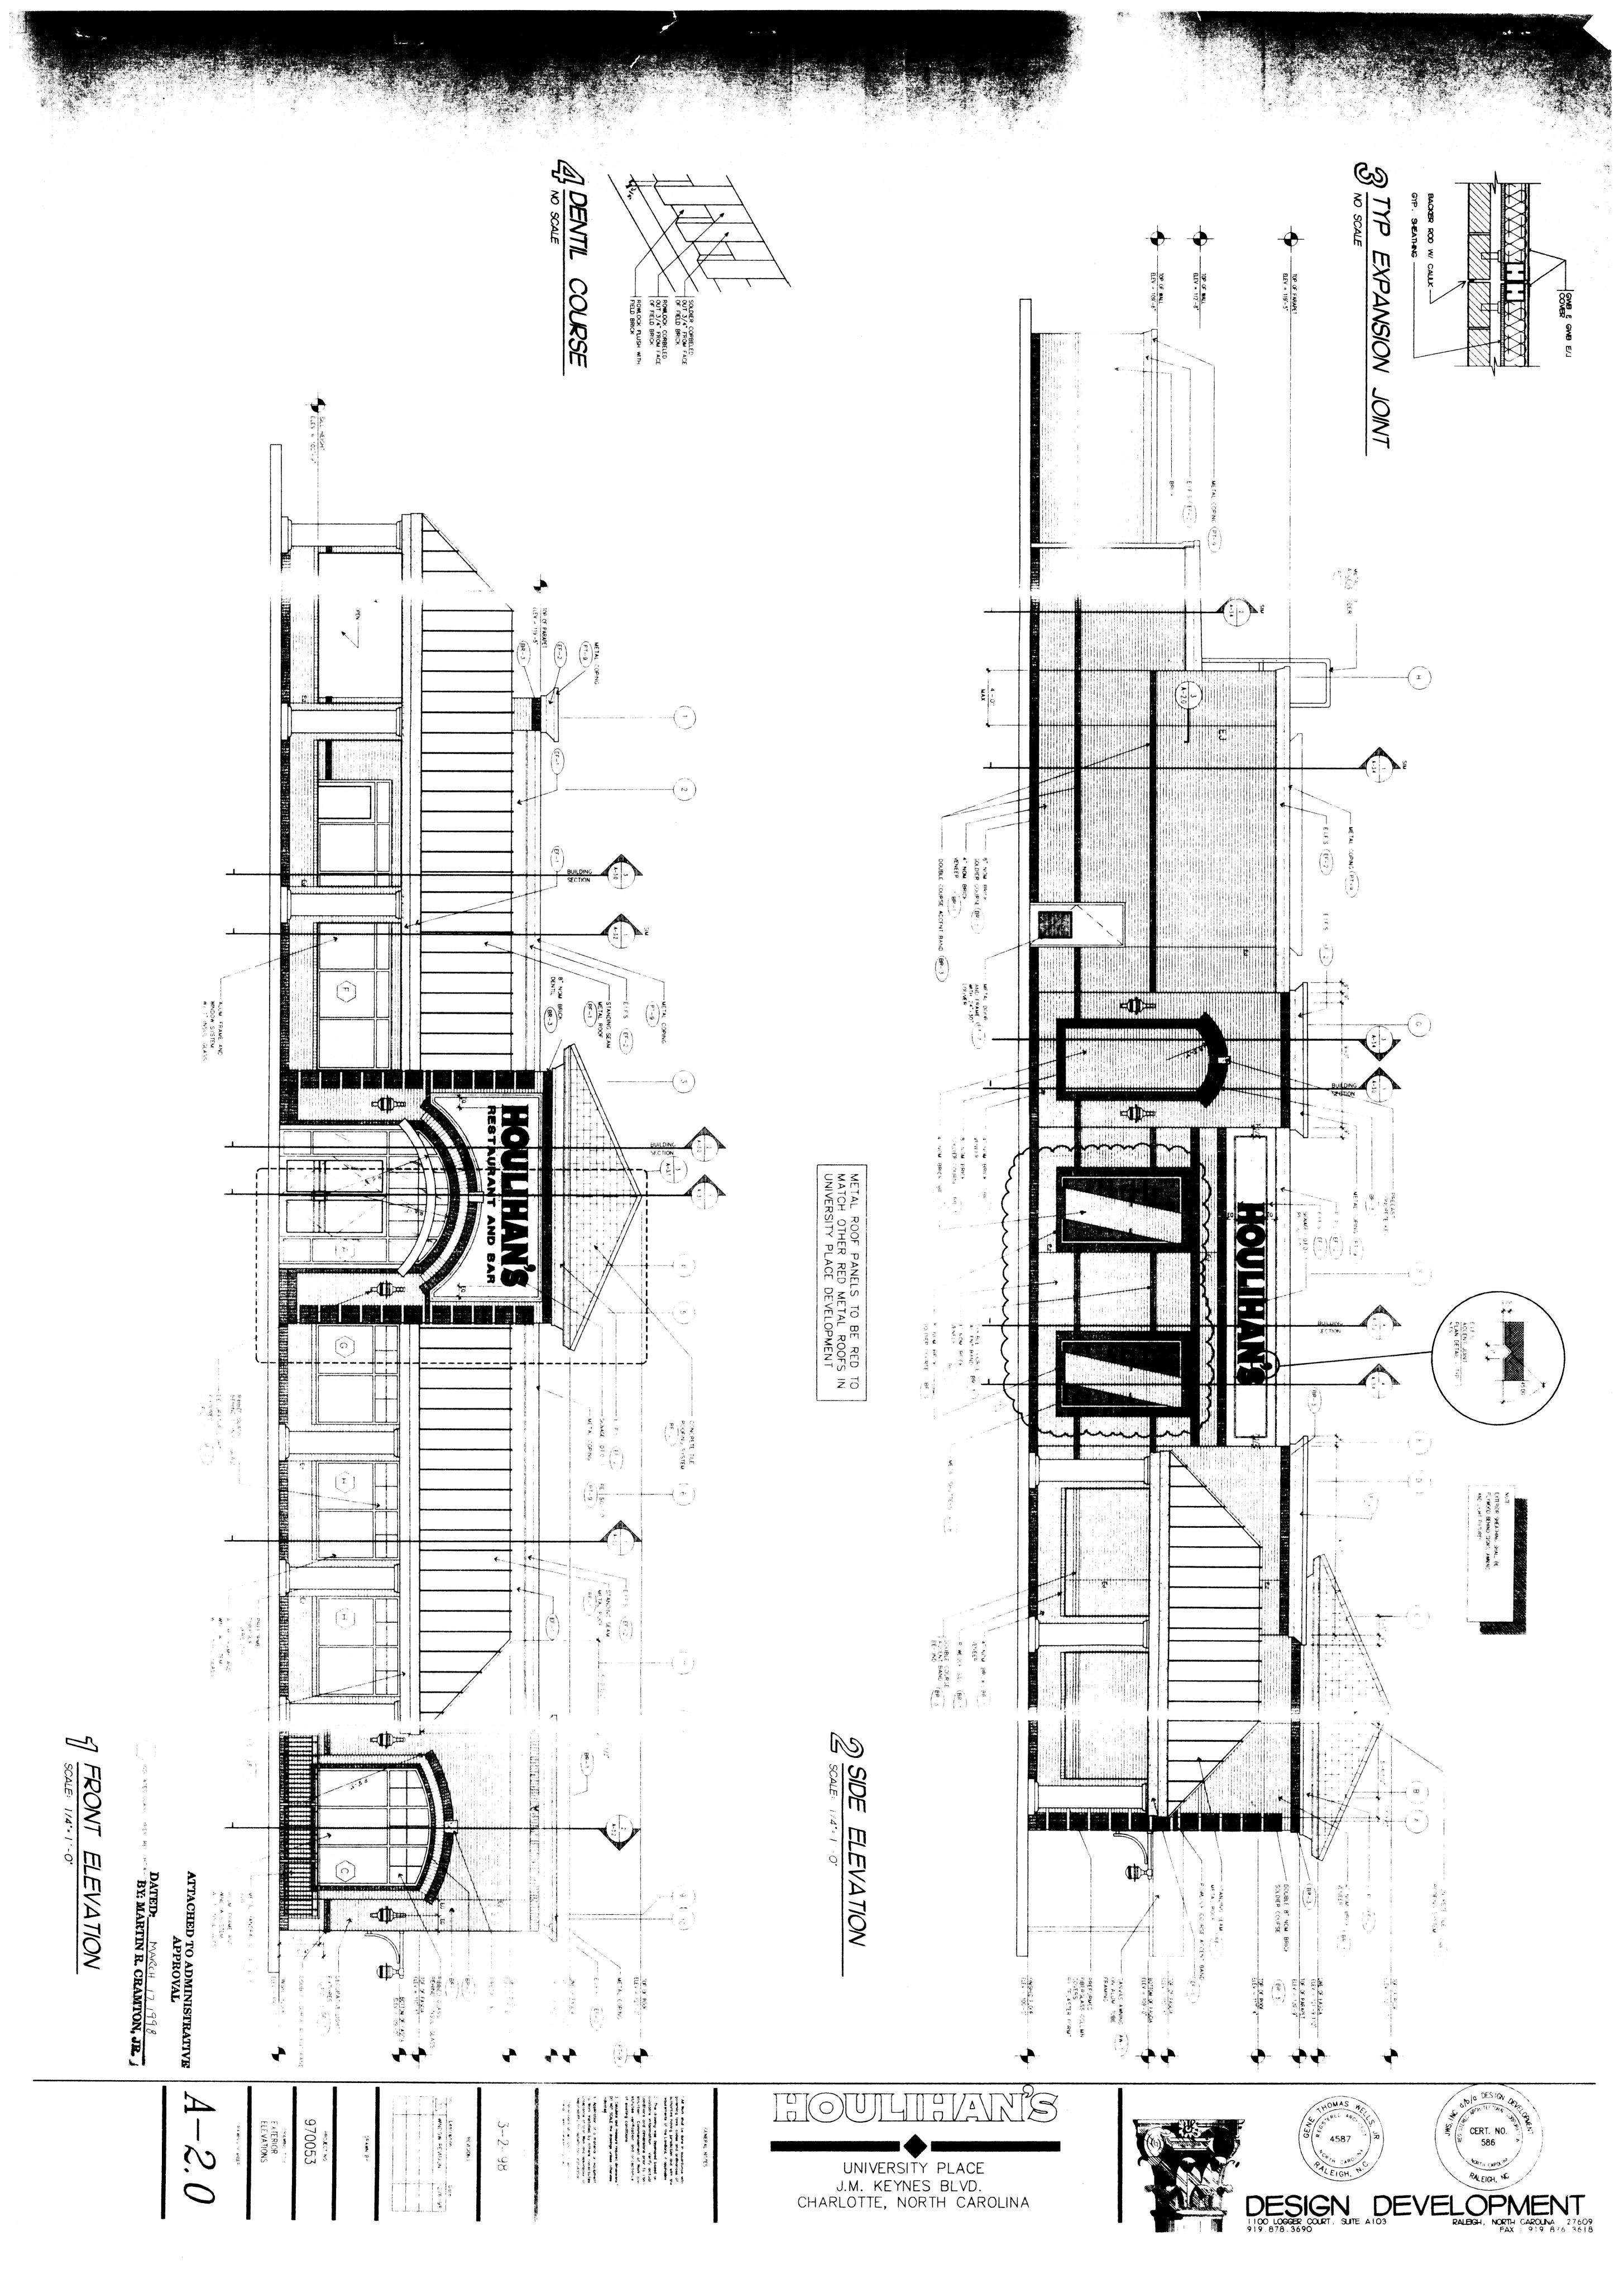
Little and Associates Architects, Inc.


N 8700 J M KEYENES DRIVE
UNIVERSITY PLACE, CHARLOTTE, NC


T + LEFT SIDE ELEVATIONS

Division President
C. RADKIN
Job Captain
N. EVERHART
Drawn By
R. BURKE
Date Drawn
4/29/97
Drawing File Name
1540—A5.DWG 1/4*
Revisions
No Date

Project Number 04-1540-09 Sheet of A-5 6



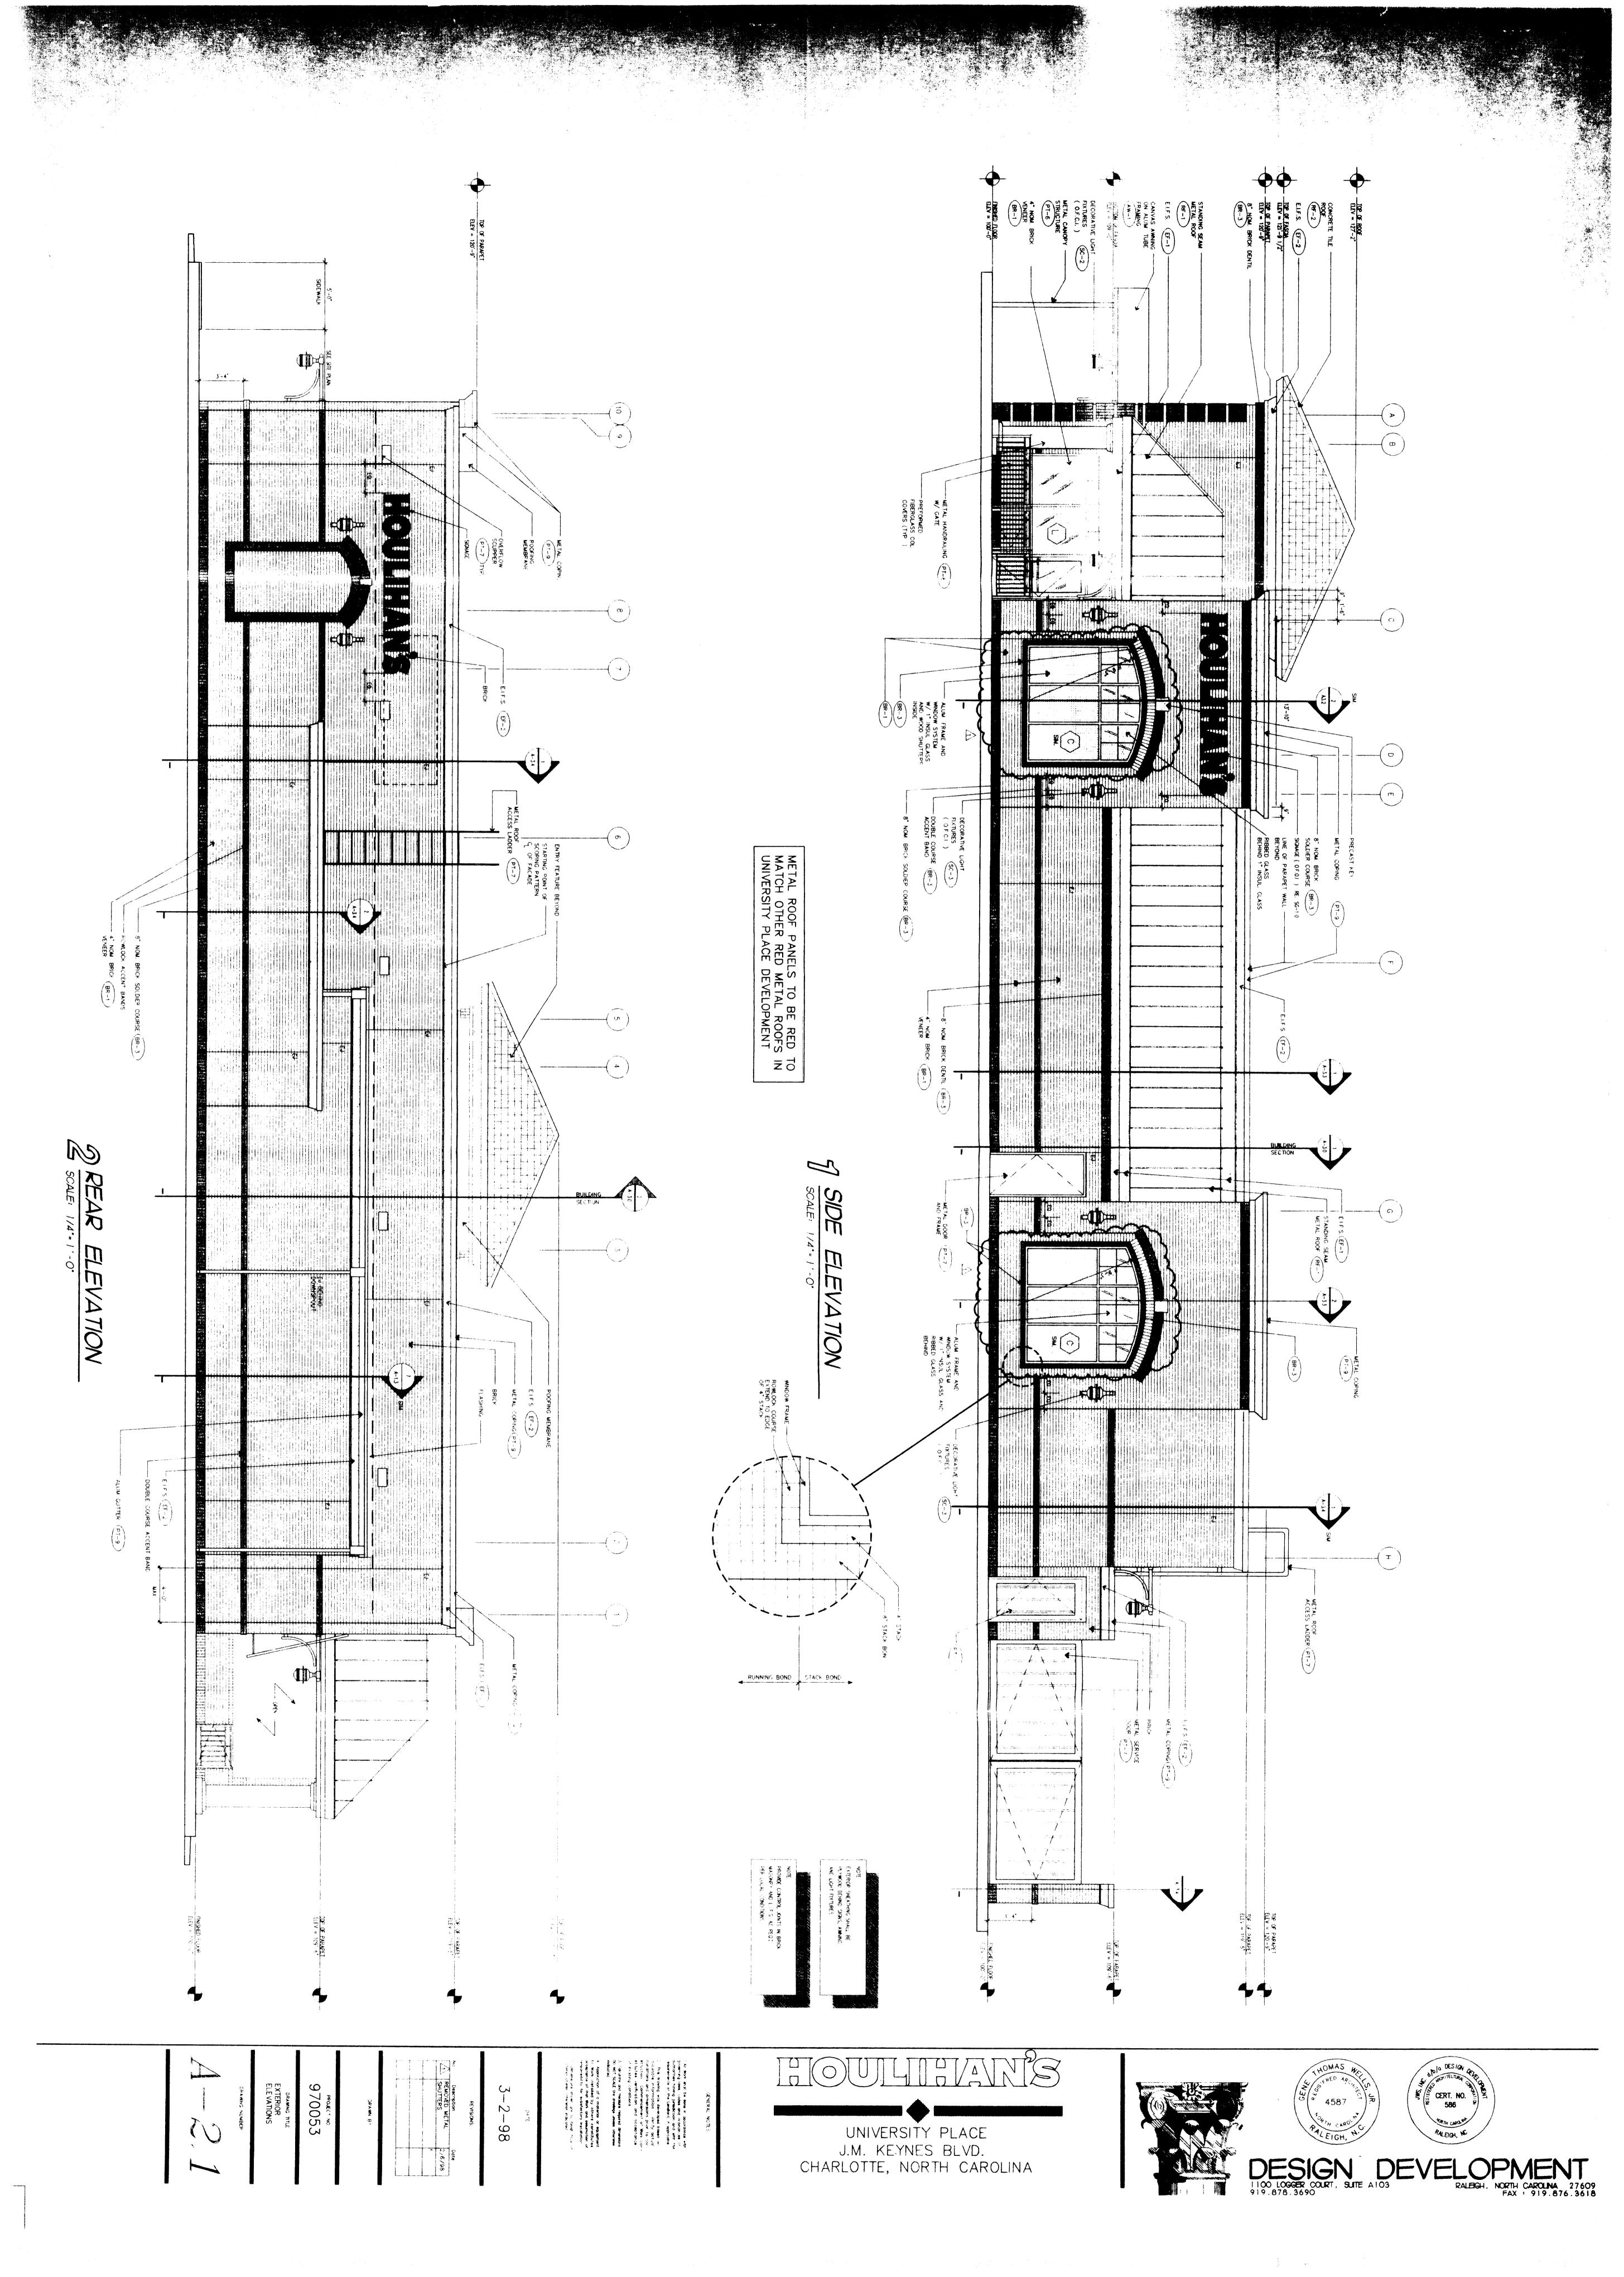

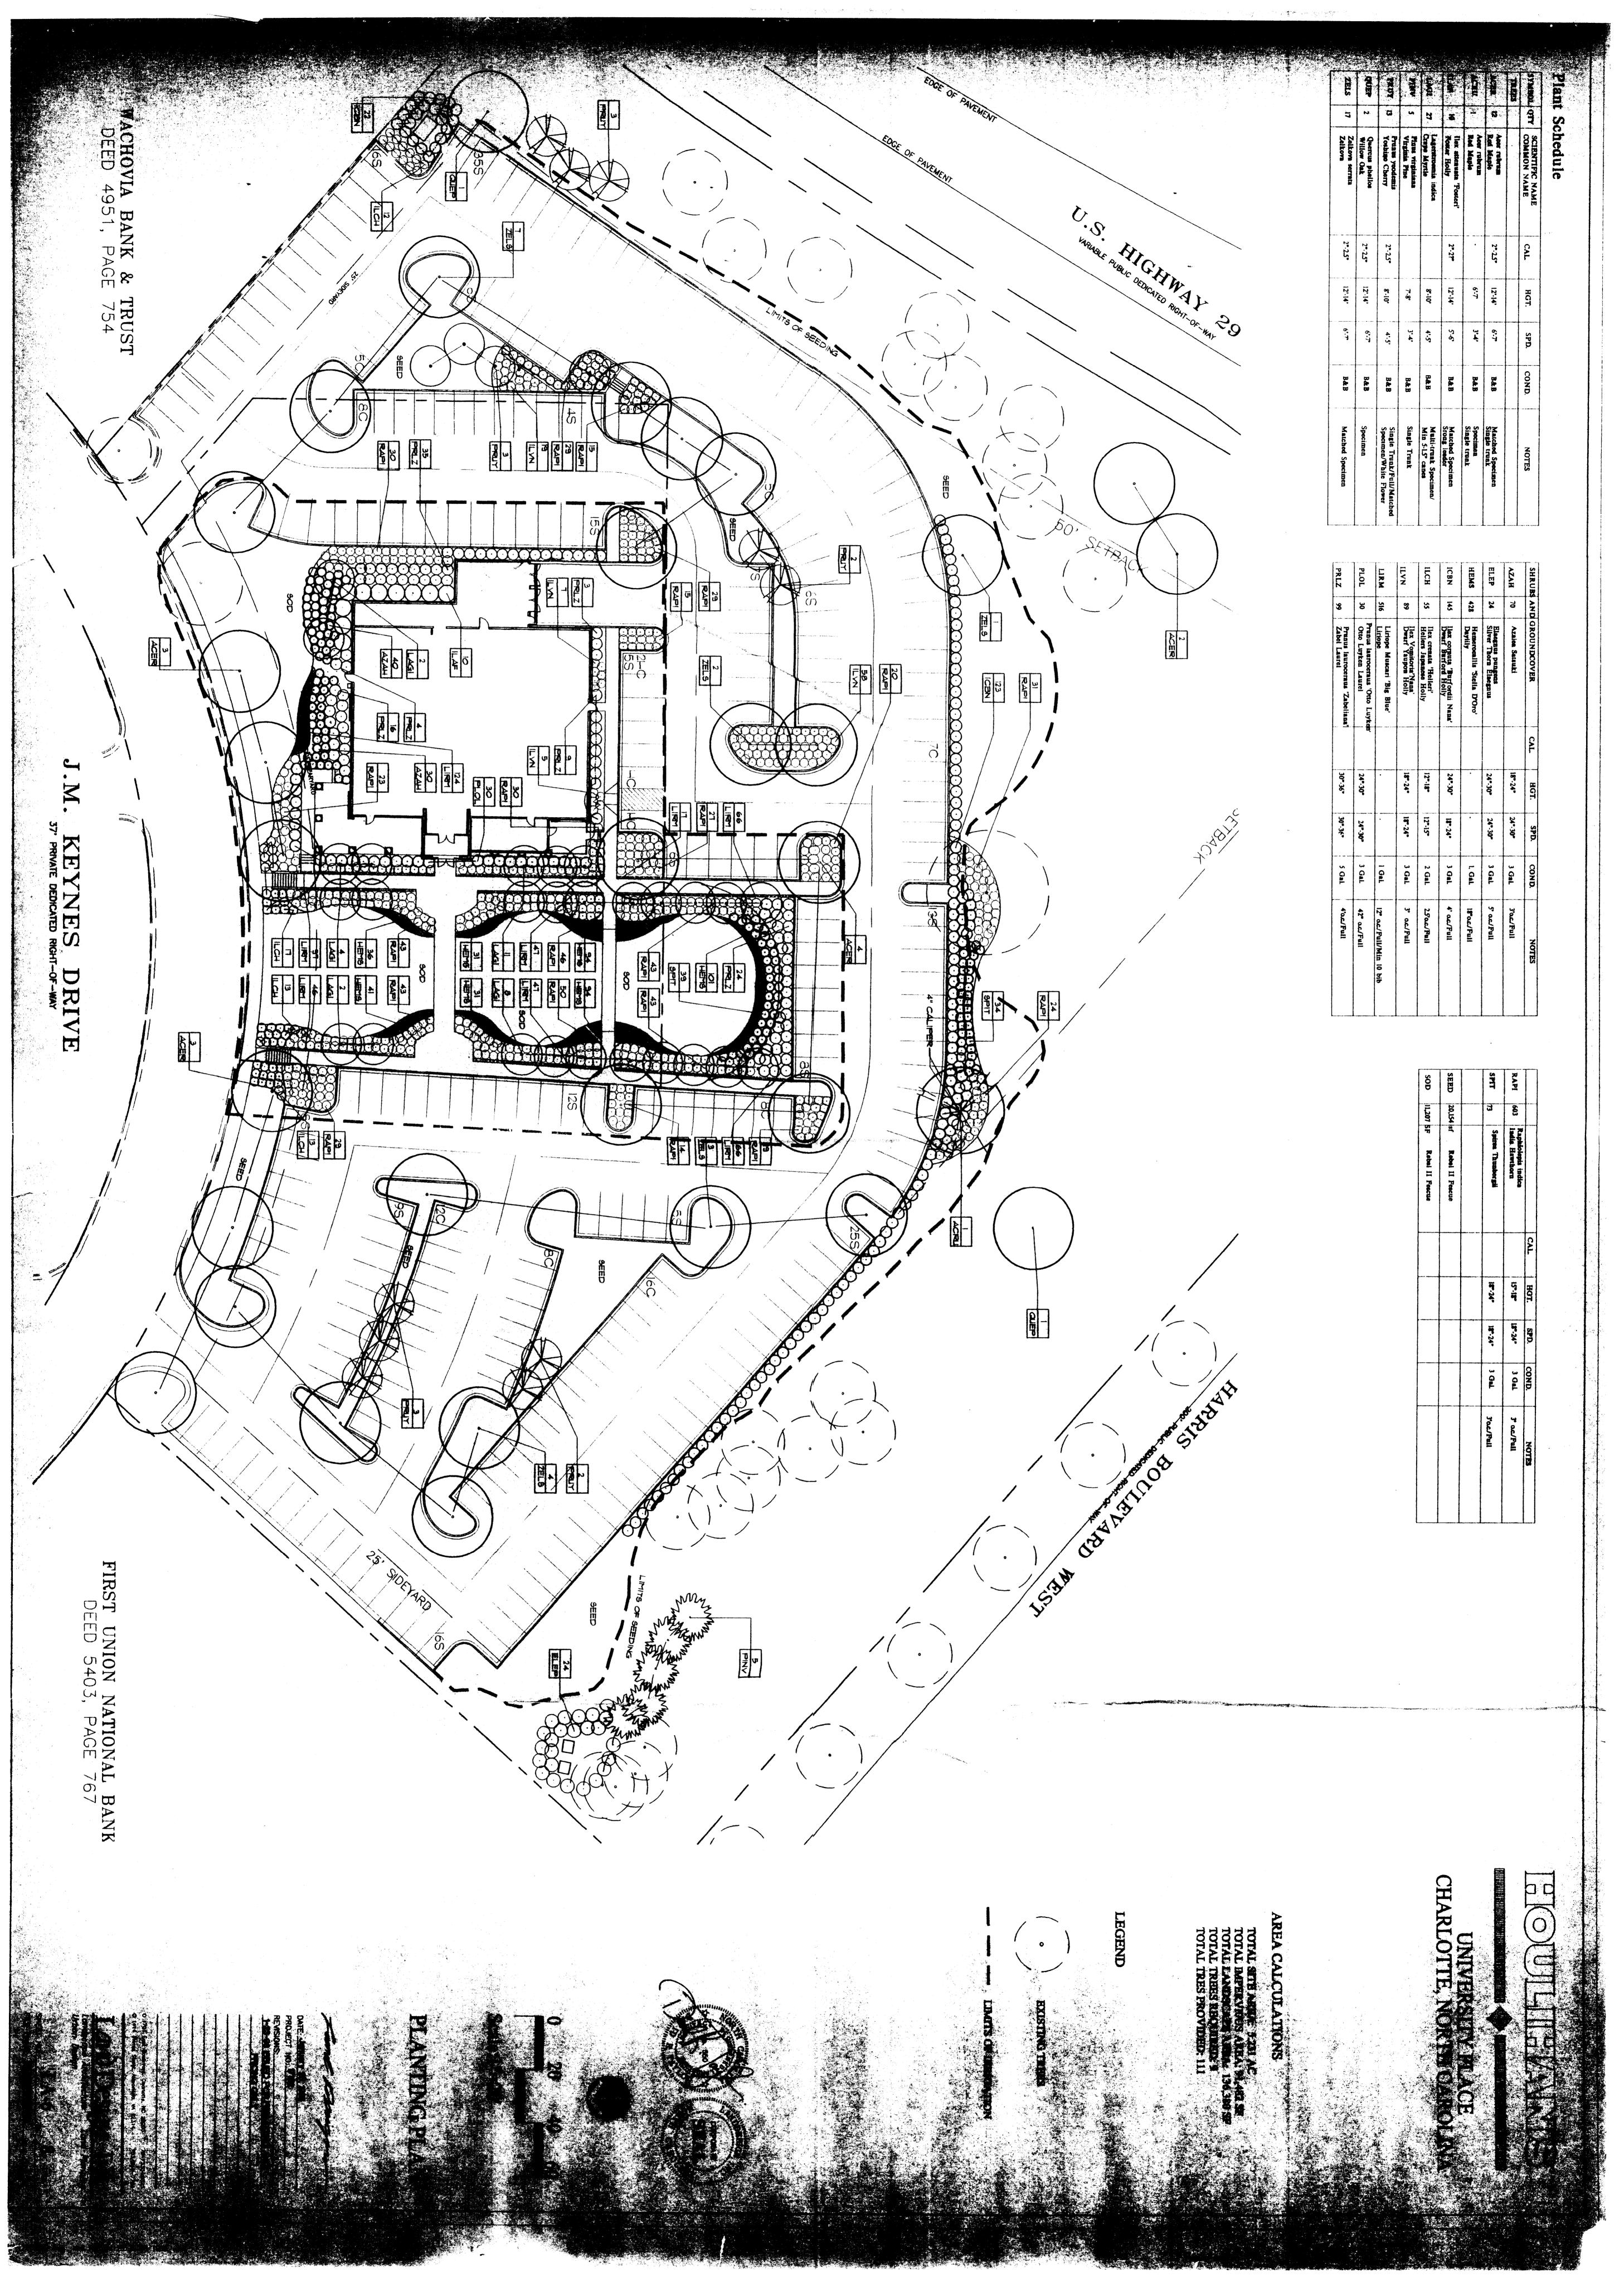



INTER - OFFICE COMMUNICATION

DATE: December 11, 2002


TO: Robert Brandon **FROM:** Martin R. Cramton, Jr.


Zoning Administrator Planning Director

SUBJECT: Administrative Approval for Petition No. 97-25 by Smokey Bones Restaurant (f.k.a.

Seaboard Realty Company).


Attached are specific plans for the upfit of the restaurant formerly known as Houlihan's. The plan indicates, among other things, specific colors of stucco finish and log columns, the type of mulch to be used and specifies that the grounds/landscaping will be professionally maintained, shows the location for expansion for a smoker(s) and indicates screening for the expansion. Please use these plans when evaluating requests for building permits and certificates of occupancy.

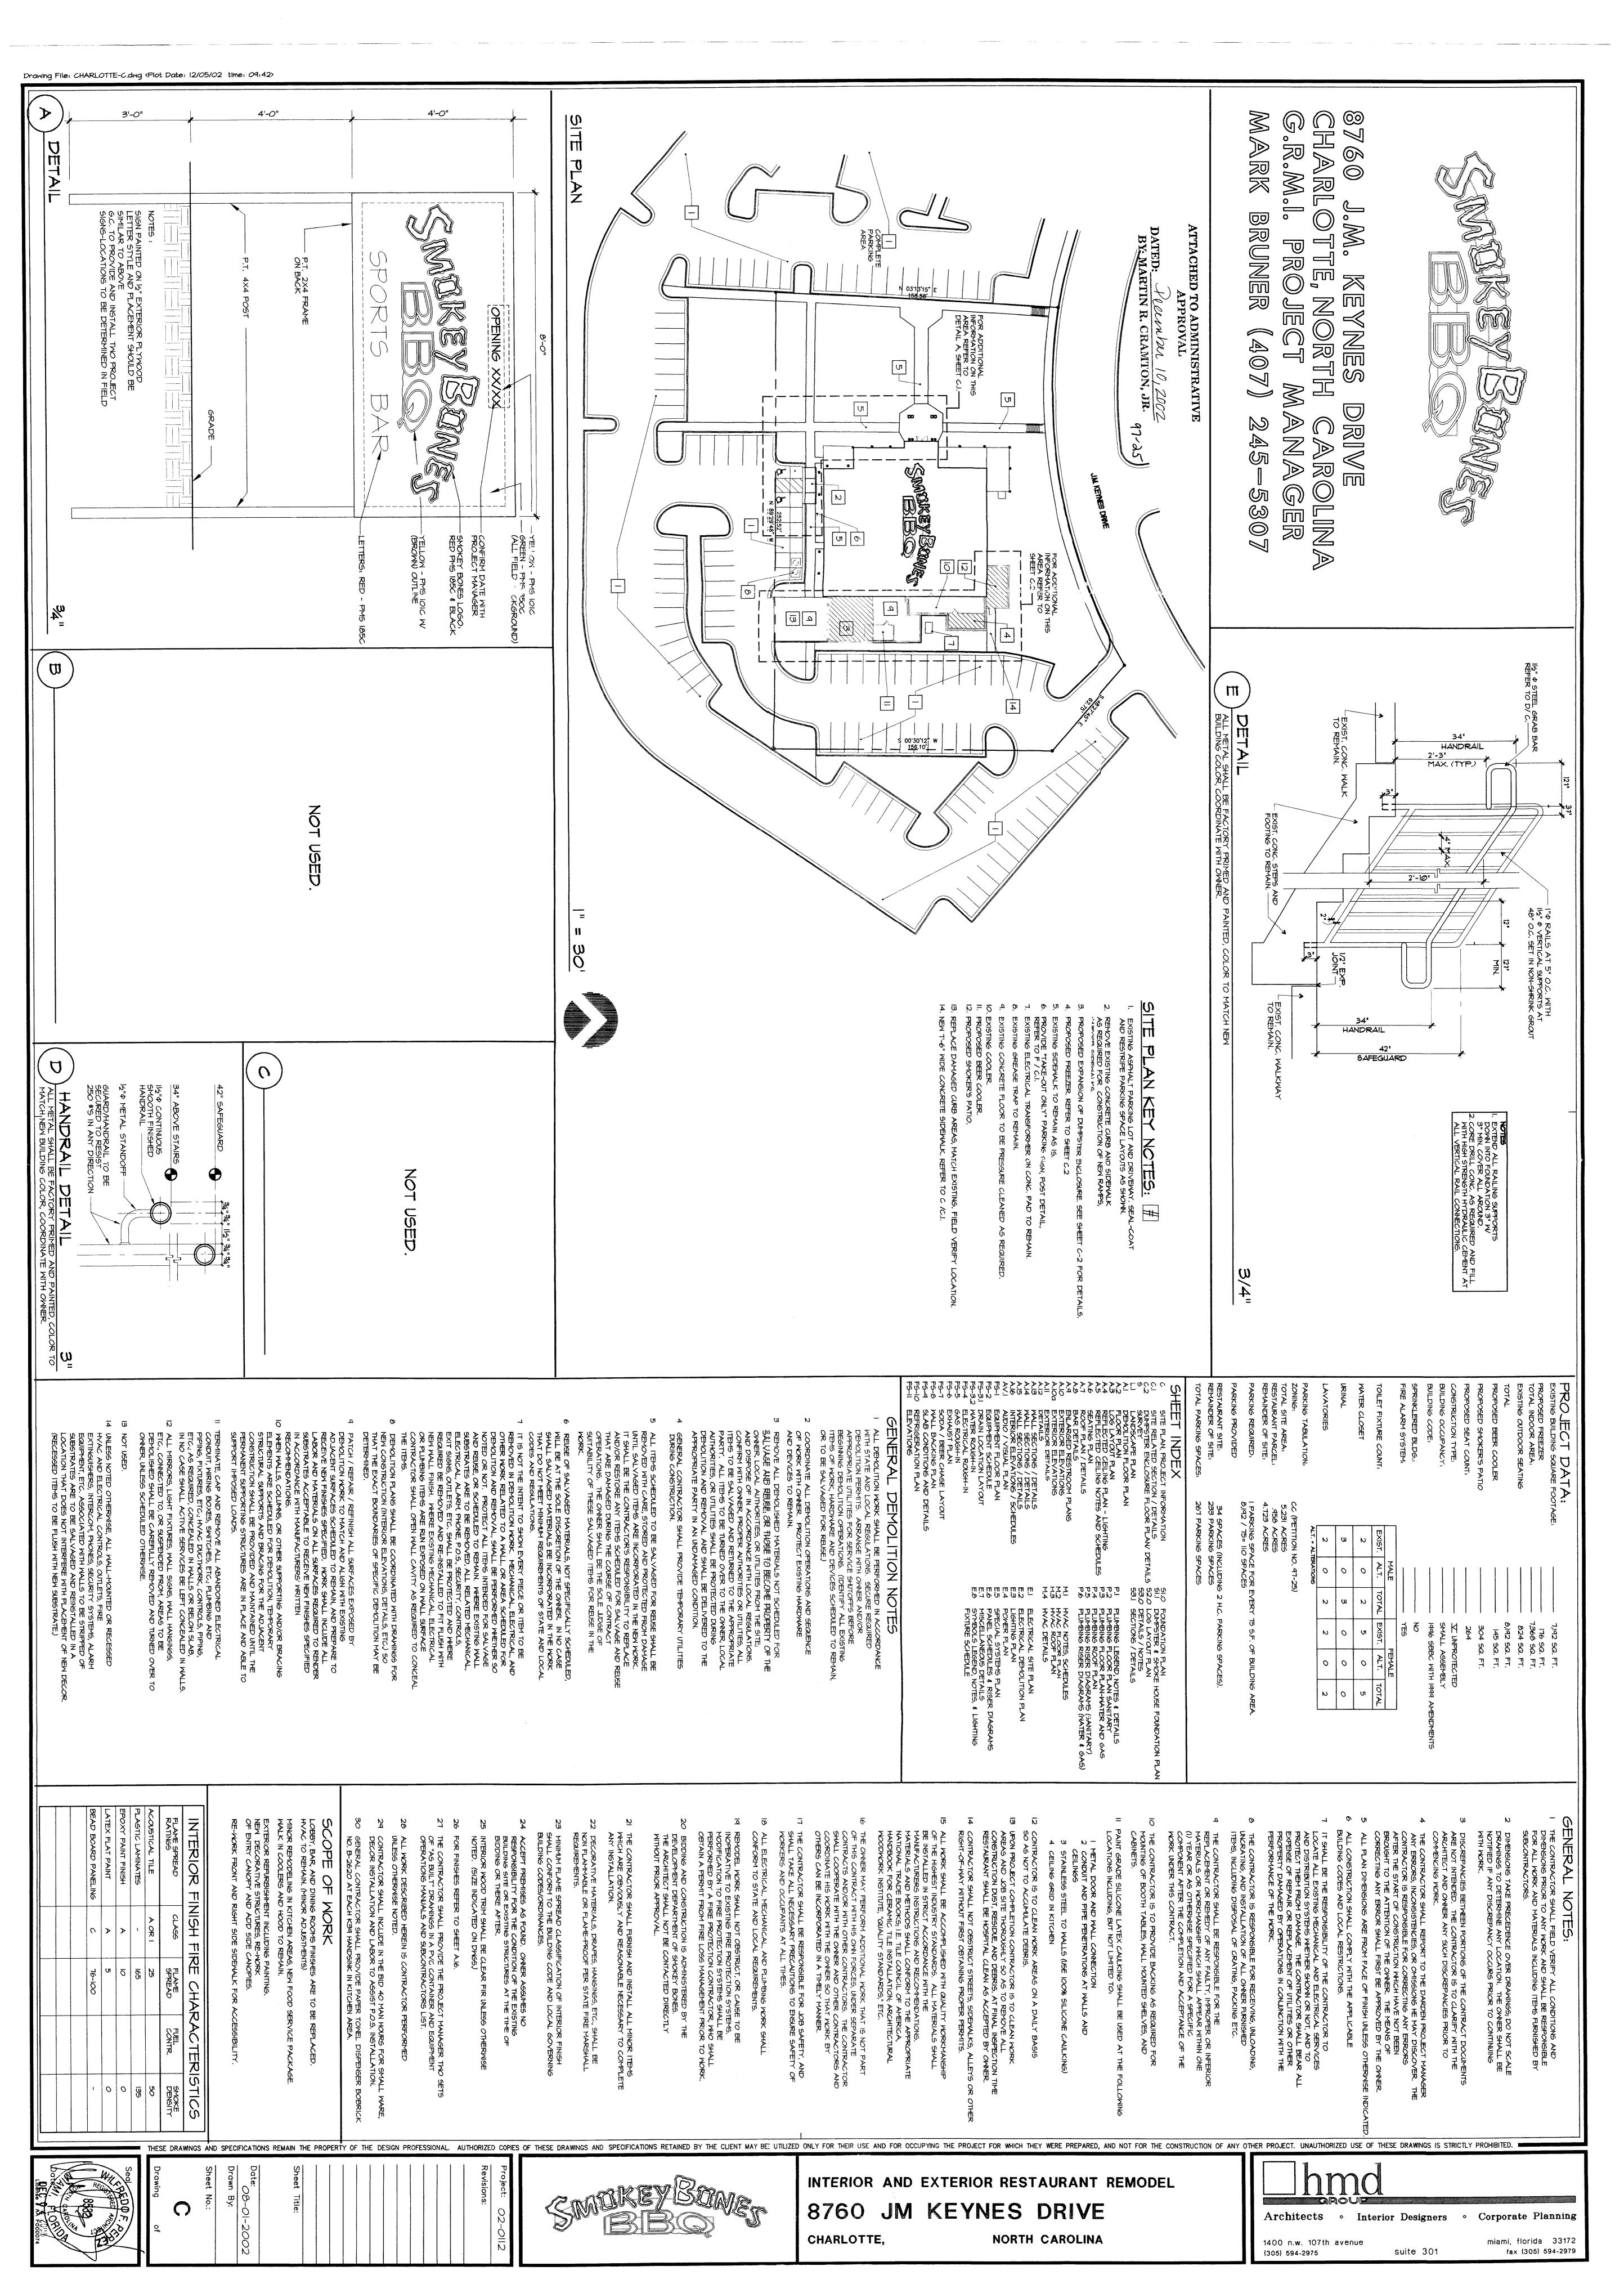

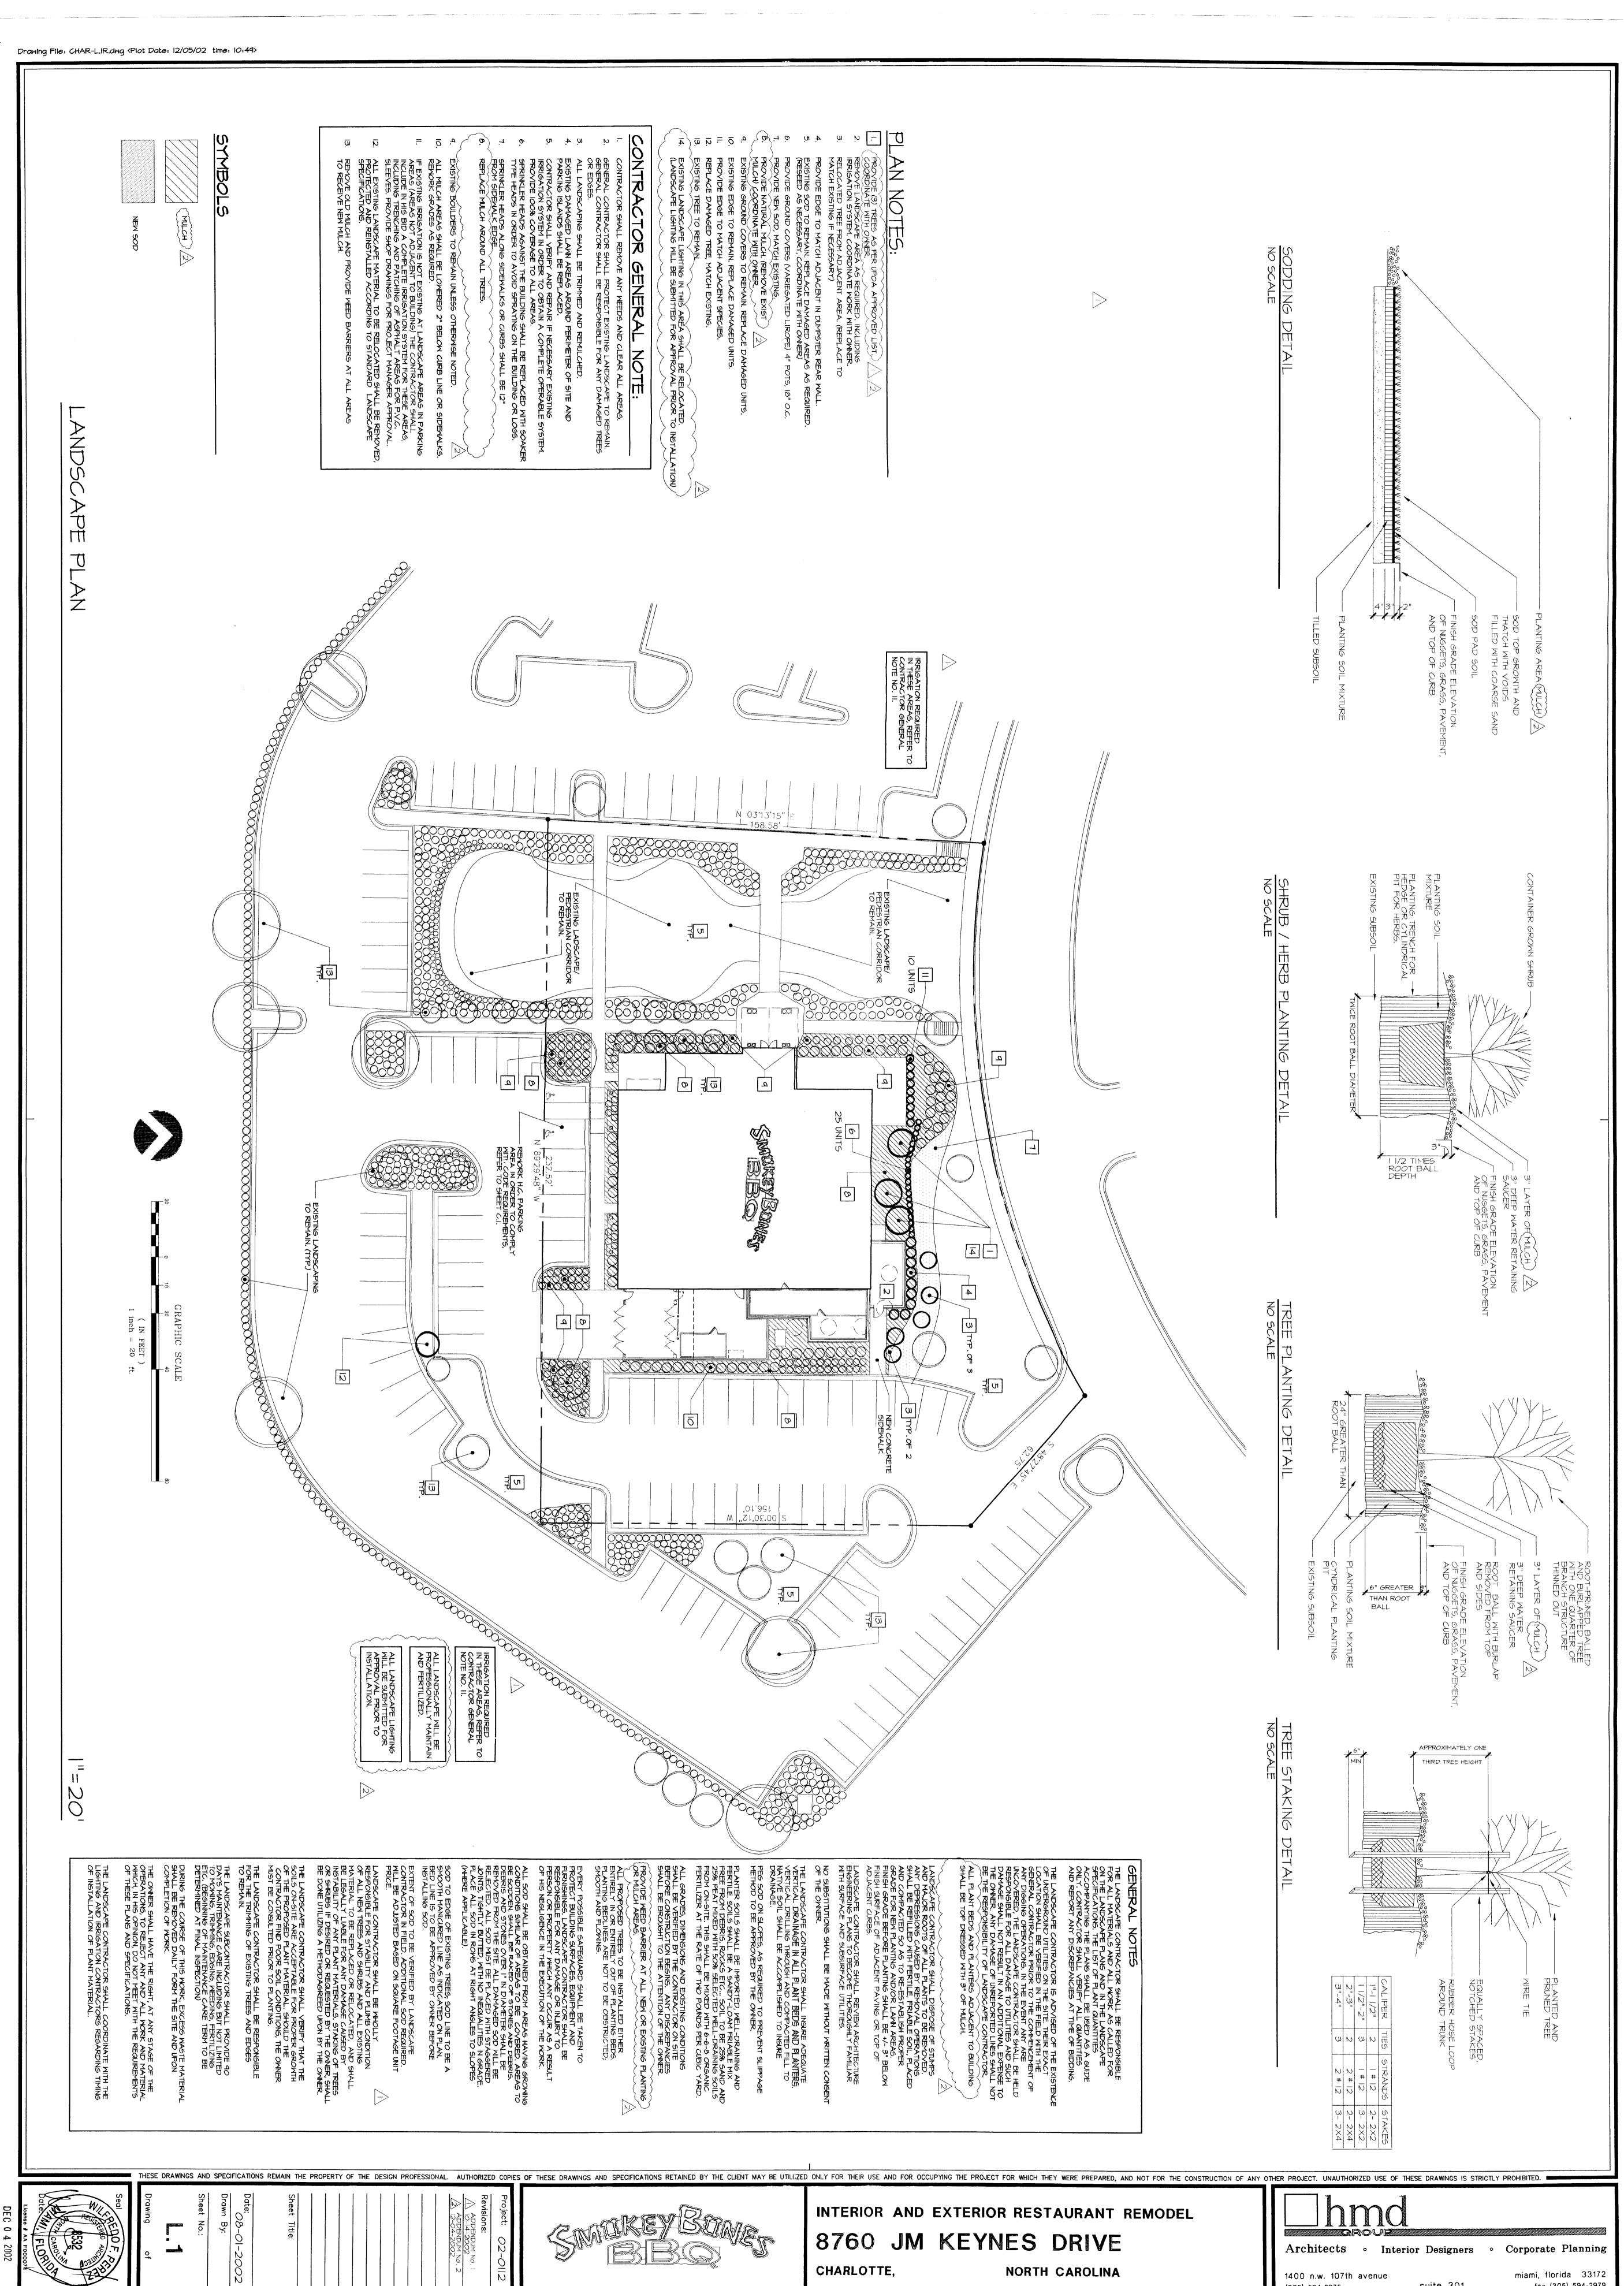




suite 301 fax (305) 594-2979

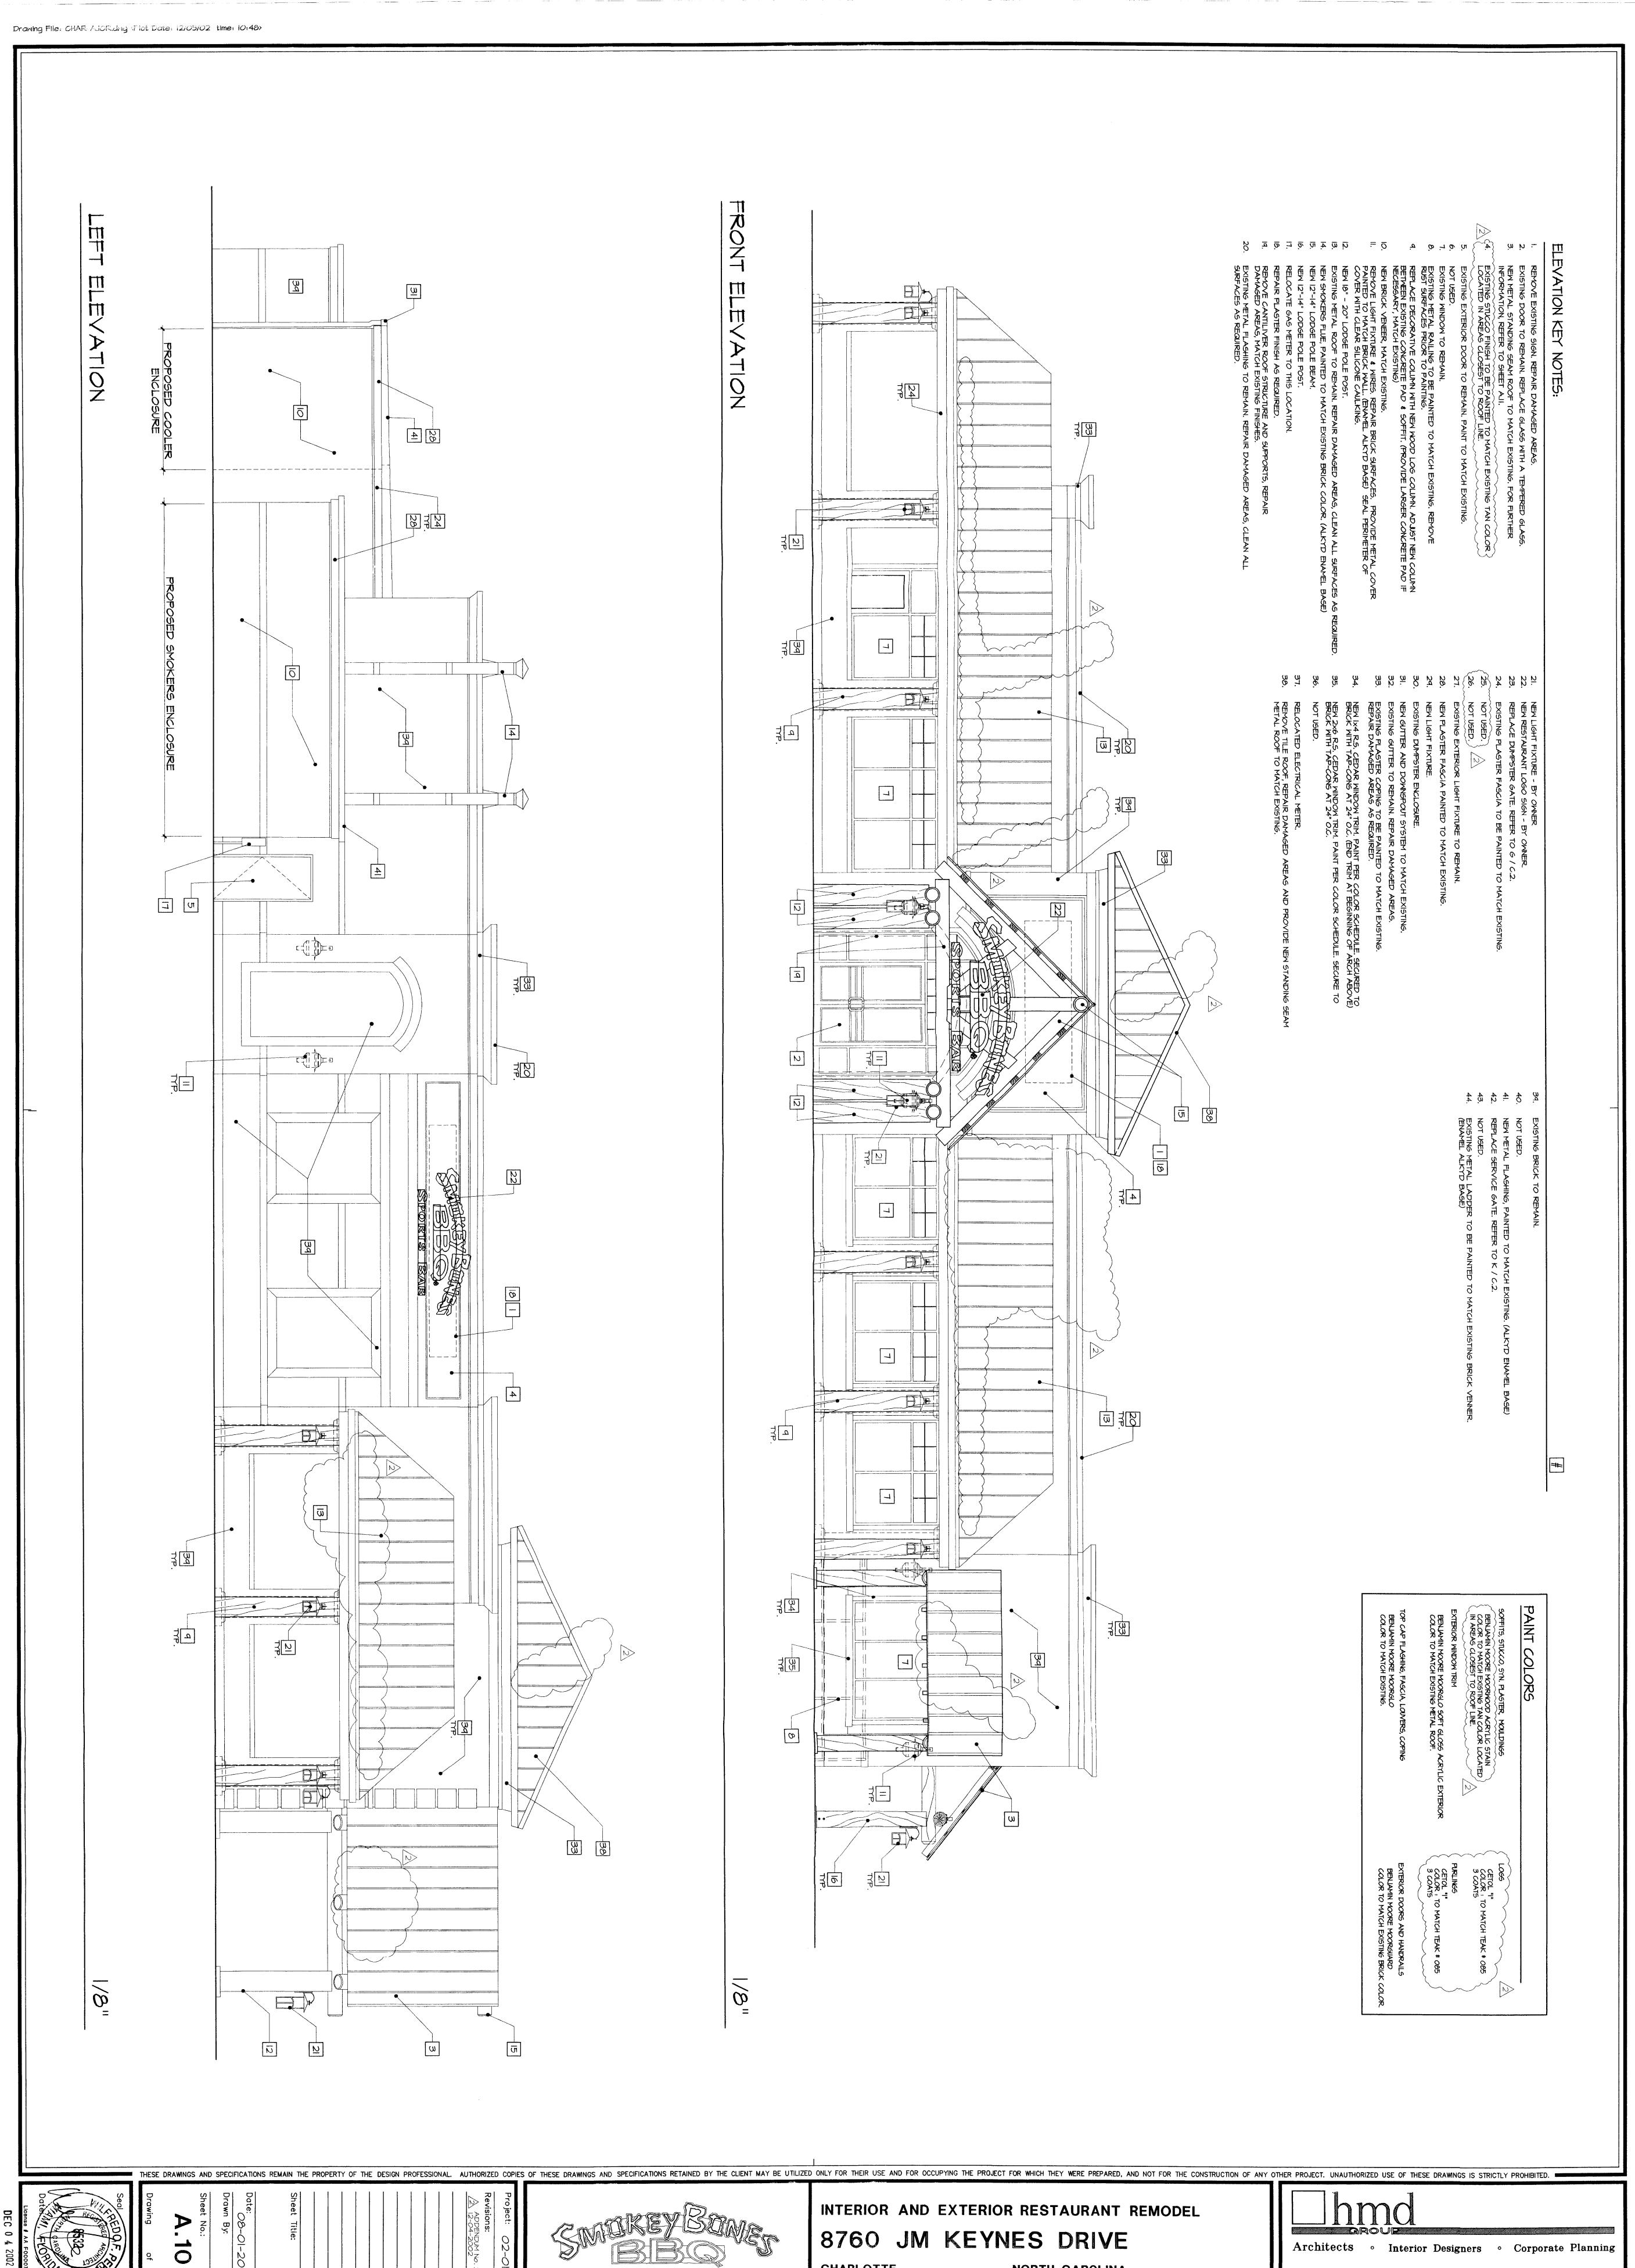



CHARLOTTE, NORTH CAROLINA 1400 n.w. 107th avenue miami, florida 33172 suite 301 fax (305) 594-2979 (305) 594-2975

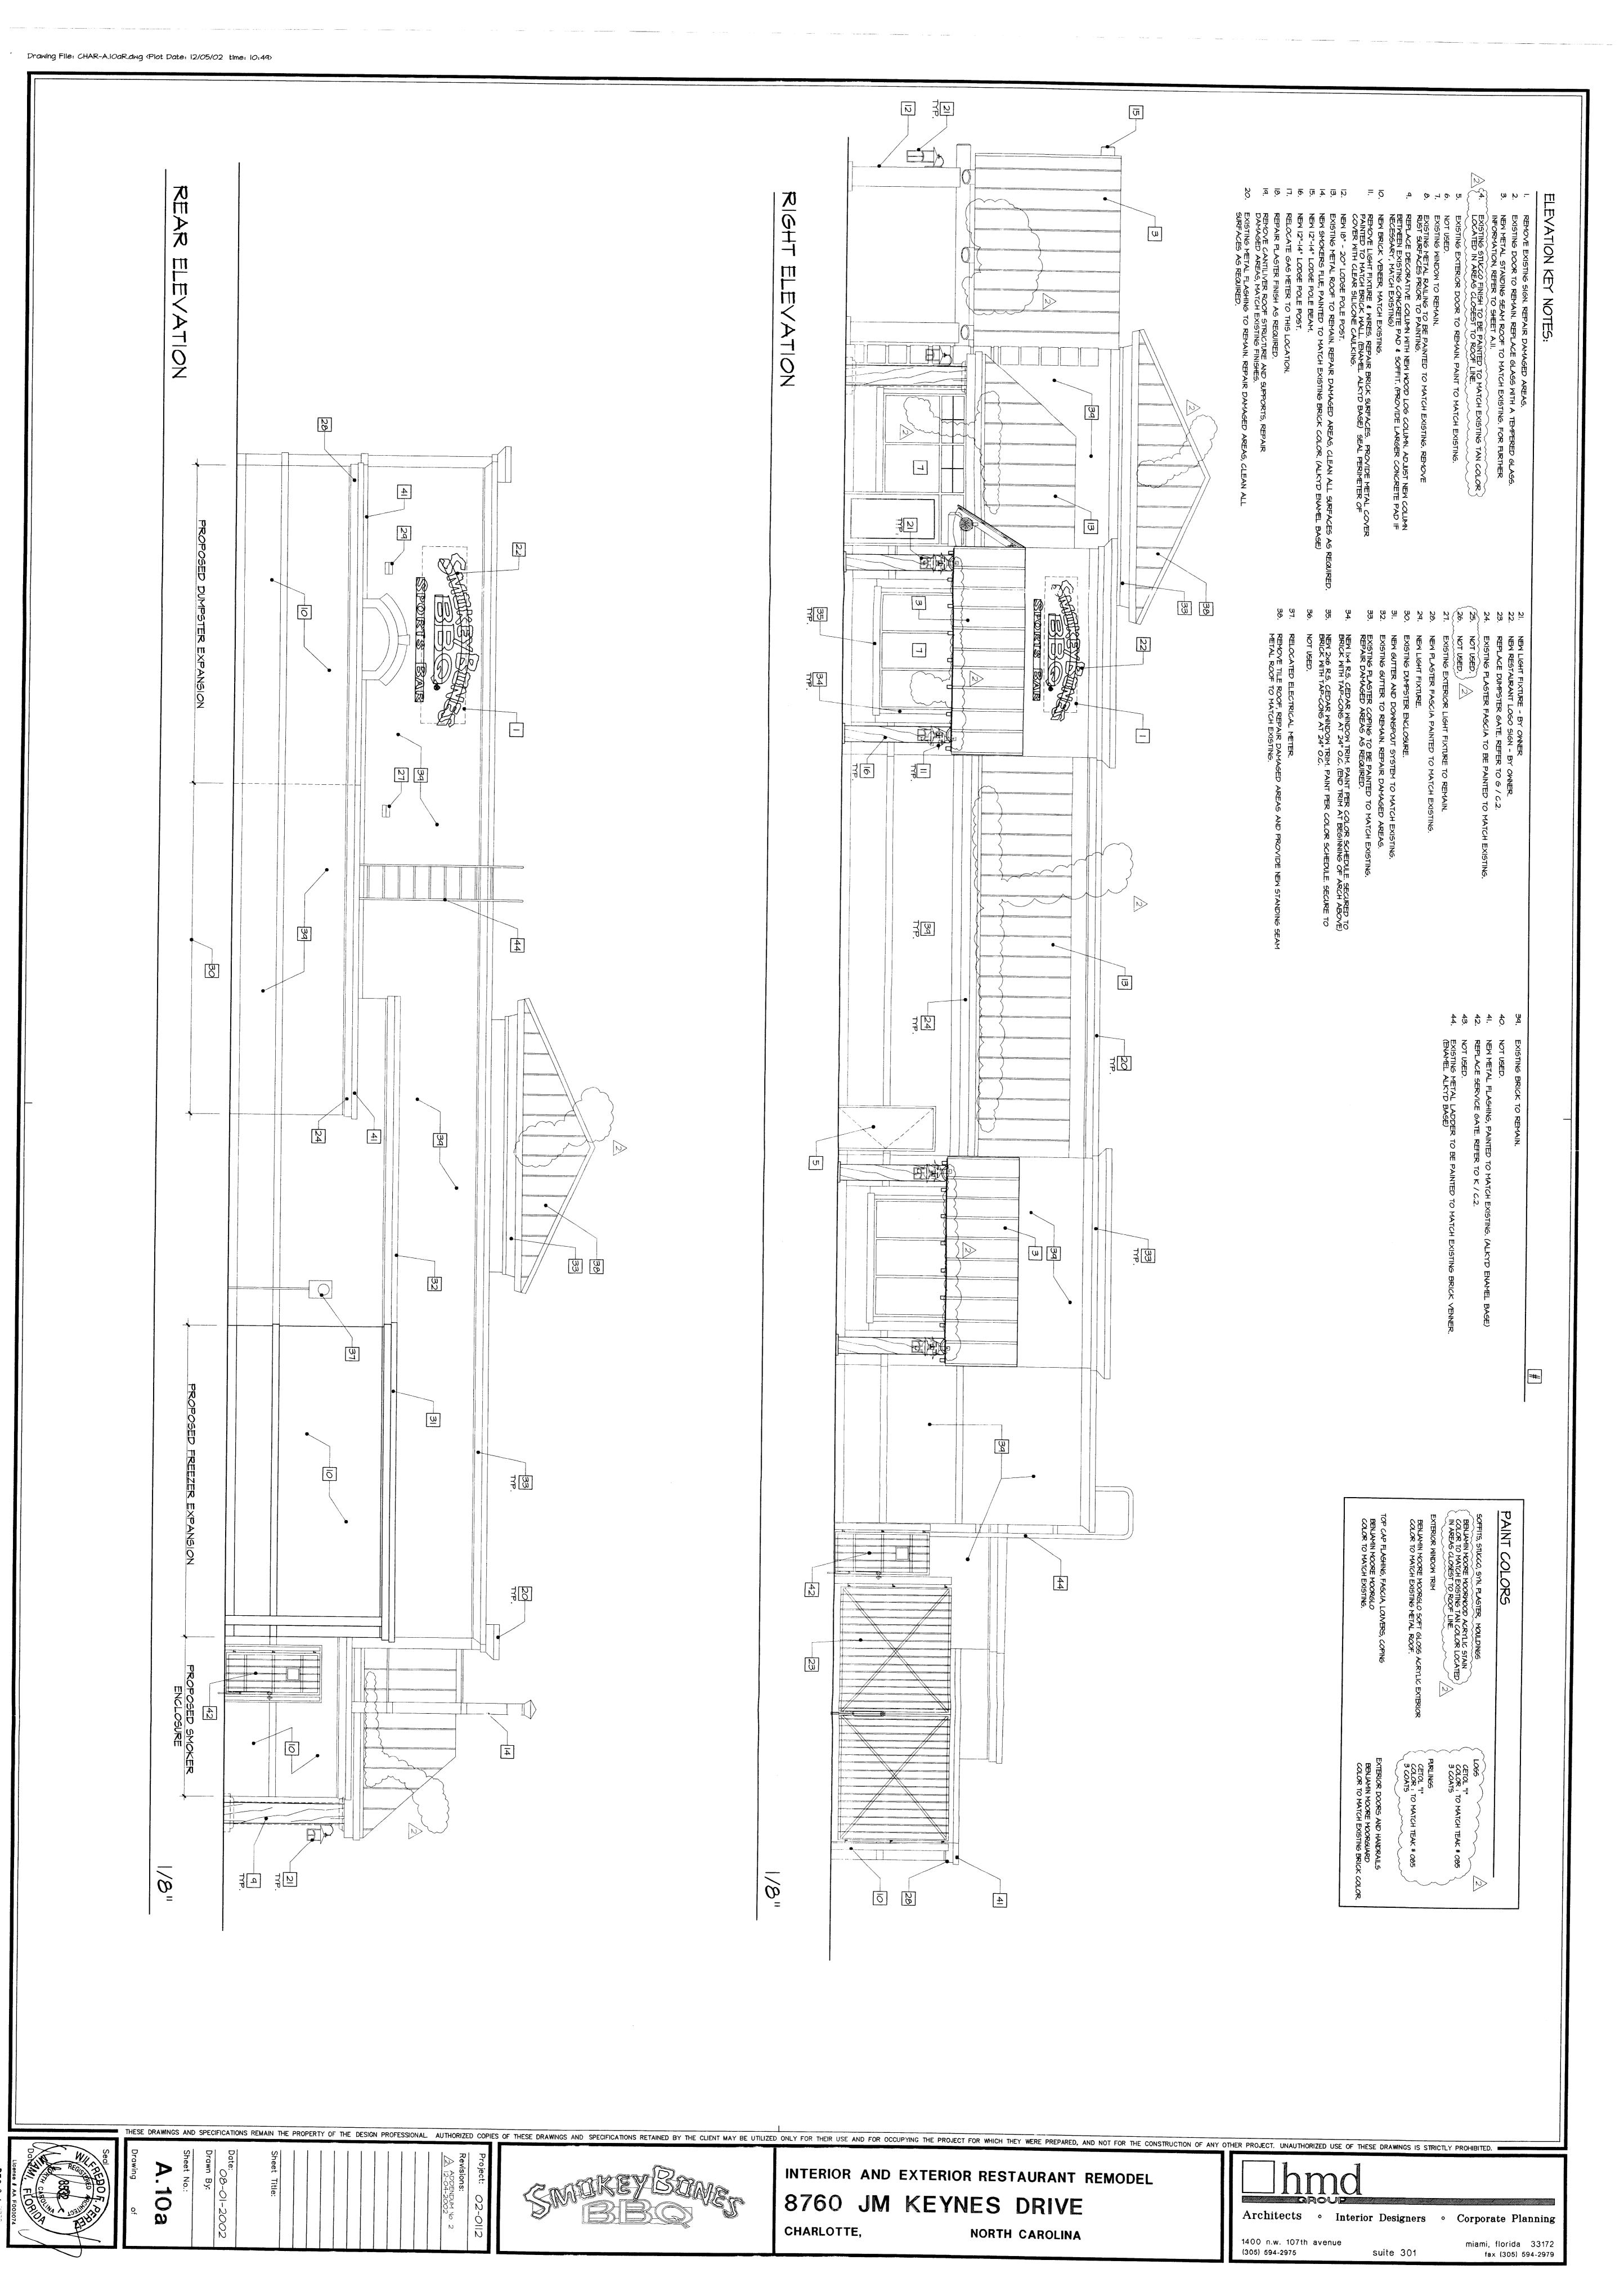



Charlotte-Mecklenburg Planning Department

DATE:

December 11, 2013

TO: Mark Fowler

Zoning Supervisor

FROM:

Debra Campbell Planning Director

\$F.ly

SUBJECT: Administrative Approval for Petition No. 1997-025 Seaboard Reality Company

Attached is the elevations of the proposed awnings for an existing restaurant/and or nightclub. Since these changes do not alter the intent of the development and meet the requirements of the conditional site plan. Please use these plans when evaluating requests for building permits and certificates of occupancy.

Note: All other Zoning, Subdivision, Tree Ordinance and conditional requirements still apply.

Signage was note reviewed as part of this request.


CHARLOTTE-MECKLENBURG PLANNING DEPARTMENT

www.charmeck.org

600 East Fourth Street Charlotte, NC 28202-2853 PH: (704)-336-2205 FAX: (704)-336-5123


ATTACHED TO ADMINISTRATIVE APPROVAL

DEC 1 1 2013

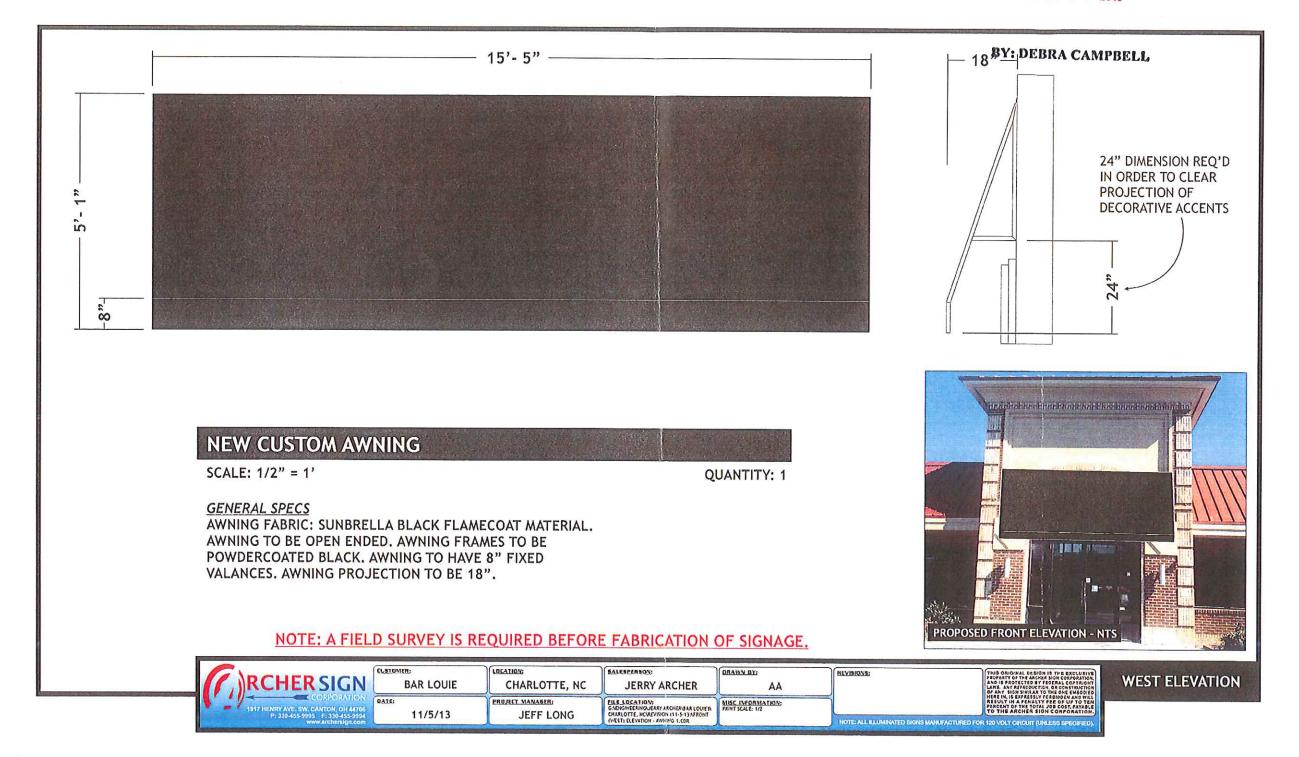

ATTACHED TO ADMINISTRATIVE APPROVAL

DEC 1 1 2013

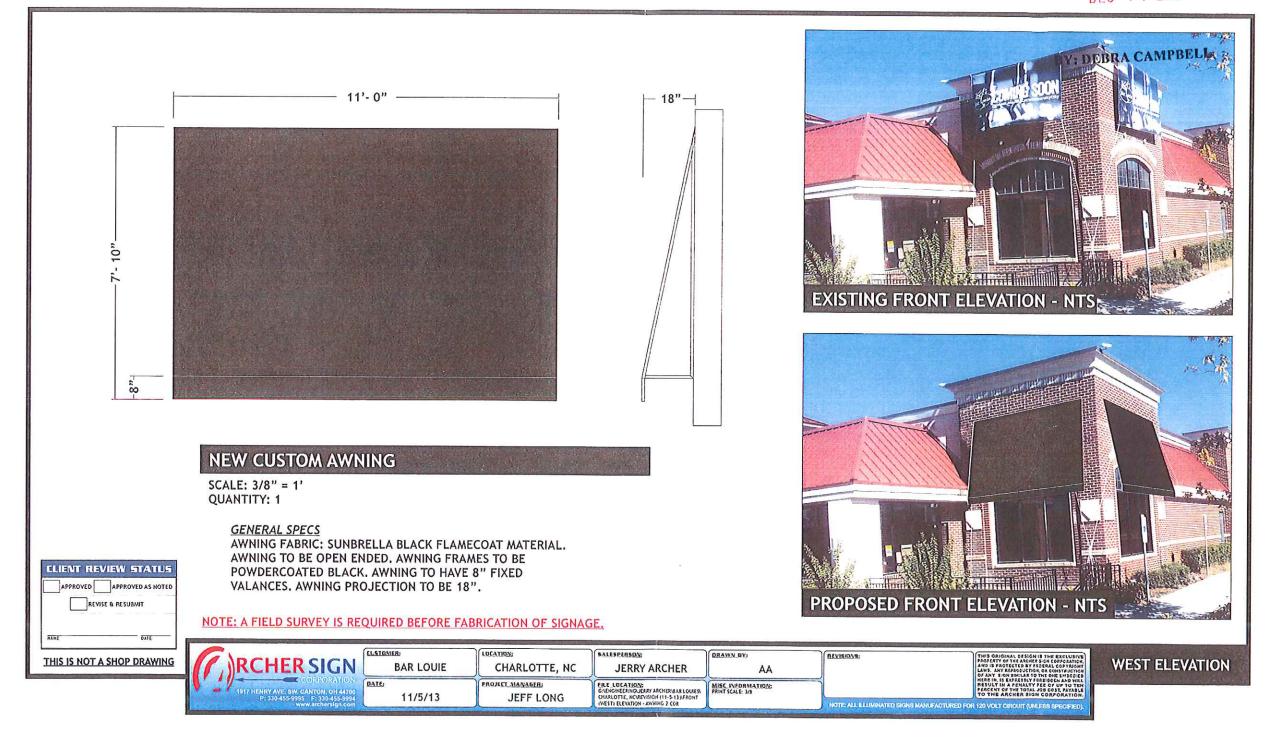

ATTACHED TO ADMINISTRATIVE APPROVAL



